

**ABBREVIATIONS**

AB	ANGLE	POUND (S)
ACST	ACOUSTICAL	LINEAL FOOT/FEET
ADA	AMERICANS WITH DISABILITIES ACT	LEFT HAND
ADL	ADDITIONAL	LEFT HAND REVERSE
ADJ	ADJACENT	LANDSCAPE
AFF	ABOVE FINISH FLOOR	LOCATION
AP	ACCESS PANEL	LIVING ROOM
APPR...	APPROXIMATE	LIGHTING
ARCHI	ARCHITECT (URAL)	LAMINATED VENEER LUMBER
ASTM	AMERICAN SOCIETY OF TESTING MATERIALS	MACHINE ROOM
AWI	ARCHITECTURAL WOODWORKING INSTITUTE	MAGNETIC (M)
BITUM	BITUMINOUS	MATERIAL
BLDG	BUILDING	MAXIMUM
BLKG	BLOCKING	MASTER BEDROOM
BM	BEAM	MECHANICAL CABINET
BO	BOTTOM OF	MECH
BOF	BOTTOM OF FOOTING	MEMBRANE
BR	BEDROOM	MACH
BSMT	BASEMENT	MATERIAL
BTU	BRITISH THERMAL UNIT	MEZZANINE
CAB	CABINET	MEZ
CB	CATCH BASIN	MF
C.C.	CENTER TO CENTER	MANUFACTURED
CFM	CUBIC FEET PER MINUTE	MANUFACTURER
CFOI	CONTRACTOR FURNISHED; OWNER INSTALLED	MINIMUM, MINUTE
CH	CHANNEL	MEDICINE CABINET
CI	CAST IRON	MIRR
CIP	CAST-IN-PLACE (CONCRETE)	MISCELLANEOUS
CL	CENTERLINE	MOS
CLG	CEILING	MASONRY OPENING
CLR	CLEAR	METAL
CMU	CONCRETE MASONRY UNIT	MULLION
CO	CLEAN OUT	NEW
COL	COLUMN	NOMINAL
CONC	CONCRETE	NOT IN CONTRACT
CONT	CONTINUOUS	NOT NOMINAL
COORD	COORDINATE	NOT TO SCALE
CPT	CARPET (ED)	OVERALL
CSMT	CASEMENT	ON CENTER
CT	CERAMIC TILE	OFFICE
° OR ...	DEGREES	OFFSHORE
DEMO	"DEMOLISH, DEMOLITION"	OPPOSITE HAND
DEPT	DEPARTMENT	OVERHEAD
DET	DETAIL	OVERLAP
DIAM	DIA (DIA)	PCP
DB	DECIBEL	PORTLAND CEMENT PLASTER
DIM	DIMENSION	PERFORATED
DN	DOWN	PERIMETER
DS	DOWNSPOUT	PERMANENT
DW	DISHWASHER	PERPENDICULAR
DWGS	DRAWINGS	PL
DWR	DRAWER	PROPERTY LINE
(E)	EXISTING	PLAM
E	EAST	PLWD
EA	EACH	POLYISOCYANURATE
EIFS	EXTERIOR INSULATION AND FINISH SYSTEM	PAIR
EL	ELEVATION	PCST
ELEC	ELECTRIC (AL)	PREFAB
ENCL	ENCLOSE (URE)	PREFABRICATED
EQ	EQUAL	PRELIM
EQUIP	EQUIPMENT	PARKING
ESMT	EASEMENT	PRKG
EST	ESTIMATE (D)	PROJECT
EW	EACH WAY	PROPERTY
EXH	EXHAUST	PROJ
EXP	EXPANSION	PROP
EXT	EXTERIOR	PSF
FAM	FLUID APPLIED MEMBRANE	POUNDS PER SQUARE FOOT
FD	FLOOR DRAIN	PSI
FDN	FOUNDATION	POUNDS PER SQUARE INCH
FE	FE FIRE EXTINGUISHER	PSL
F.G.	FINISH GRADE	PARTICLE BOARD
FIN	FINISH (ED)	PORTLAND CEMENT PLASTER
FL	FLASHING	PRECAST
FLR	FLOOR	PREFABRICATED
FF	FINISH FLOOR	PRELIM
FM	FACTORY MANUAL	PARTITION
FOC	FACE OF CONCRETE	POLYVINYL ACRYLIC
FOF	FACE OF FINISH	POLYVINYL CHLORIDE
FOIC	FURNISHED BY OWNER INSTALLED BY CONTRACTOR	PAVING
FOIO	FURNISHED BY OWNER INSTALLED BY OWNER	PAVING
FOM	FACE OF MASONRY	QTY
FOS	FACE OF STUDS	QUANTITY
FPHB	FROSTPROOF HOSE BIBB	RADIUS, RISER
FPL	FIREPLACE	REFLECTED CEILING PLAN
FRMG	FRAMING	REFLECTED CEILING PLAN
FT	FOOT, FEET"	REFLECTED CEILING PLAN
FTG	FOOTING	REFLECTED CEILING PLAN
FURN	FURNITURE	REFLECTED CEILING PLAN
G	NATURAL GAS	REFLECTED CEILING PLAN
GAU	GAUGE	REFLECTED CEILING PLAN
GALV	"GALVANIZED, GALVANIC"	REFLECTED CEILING PLAN
GAR	GARAGE	REFLECTED CEILING PLAN
GB	GRAB BAR	REFLECTED CEILING PLAN
CC	GENERAL CONTRACTOR	REFLECTED CEILING PLAN
GEN	GENERAL	REFLECTED CEILING PLAN
GL	GLUED LAMINATED WOOD	REFLECTED CEILING PLAN
GOVT	GOVERNMENT	REFLECTED CEILING PLAN
GSM	GALVANIZED SHEET METAL	REFLECTED CEILING PLAN
GWB	GYPSUM WALL BOARD	REFLECTED CEILING PLAN
HT	HEIGHT	REFLECTED CEILING PLAN
HB	HOSE BIBB	REFLECTED CEILING PLAN
HDR	HEADER	REFLECTED CEILING PLAN
HDW	HARDWARE	REFLECTED CEILING PLAN
HDWD	HARDWOOD	REFLECTED CEILING PLAN
HLDN	HOLDDOWN	REFLECTED CEILING PLAN
HM	HOLLOW METAL	REFLECTED CEILING PLAN
HO	HOLD OPEN	REFLECTED CEILING PLAN
HORIZ	HORIZONTAL	REFLECTED CEILING PLAN
HR	HOUR	REFLECTED CEILING PLAN
HSS	HOLLOW STRUCTURAL SECTION	REFLECTED CEILING PLAN
HVAC	HEATING, VENTILATION, AND AIR CONDITIONING	REFLECTED CEILING PLAN
HWH	HOT WATER HEATER	REFLECTED CEILING PLAN
ID	INSIDE DIAMETER	REFLECTED CEILING PLAN
IE	INVERT ELEVATION	REFLECTED CEILING PLAN
IIC	IMPACT ISOLATION CLASS	REFLECTED CEILING PLAN
IN	INCH (S)	REFLECTED CEILING PLAN
INCL	INCLUDING (ED)	REFLECTED CEILING PLAN
INFO	INFORMATION	REFLECTED CEILING PLAN
INSUL	INSULATION	REFLECTED CEILING PLAN
INT	INTERIOR	REFLECTED CEILING PLAN
JAN	JANITOR	REFLECTED CEILING PLAN
JST	JOIST (S)	REFLECTED CEILING PLAN
KIT	KITCHEN	REFLECTED CEILING PLAN
KW	KILOWATT	REFLECTED CEILING PLAN
L	LENGTH	REFLECTED CEILING PLAN
LAM	LAMINATE(D), LIQUID APPLIED MEMBRANE	REFLECTED CEILING PLAN
LAV	LAVATORY	REFLECTED CEILING PLAN

**MATERIAL LEGEND**

LB (S)	POUND (S)	CEMENTITIOUS UNDERLAYMENT
LF	LINEAL FOOT/FEET	CONCRETE
LH	LEFT HAND	EARTH, UNDISTURBED
LHR	LEFT HAND REVERSE	EARTH, COMPAKTED FILL
LNDSCP	LANDSCAPE	GYPSUM WALL BOARD
LOC	LOCATION	INSULATION - BATT
LR	LIVING ROOM	INSULATION - RIGID
LTG	LIGHTING	ORIENTED STRAND BOARD
LVL	LAMINATED VENEER LUMBER	PARTICLEBOARD
MACH	MACHINE ROOM	PLYWOOD
MAG	MAGNETIC (M)	POURS FILL
MATL	MATERIAL	SAND, GROUT
MAX	MAXIMUM	SPRAY FOAM
MBR	MASTER BEDROOM	STEEL, OTHER METALS
MC	MEDICINE CABINET	WOOD - BLOCKING OR SHIM
MECH	MECHANICAL	WOOD - FINISHED
MEMB	MEMBRANE	WOOD - GLUE LAMINATED
MACH	MACHINE ROOM	WOOD - NOMINAL LUMBER

**SYMBOL LEGEND**

8'-0"	CEILING HEIGHT TAG
E	COLUMN GRIDS
500	DATUM / CONTROL POINT
PF-1	FINISH, FIXTURE, AND EQUIPMENT TAG
1	BUILDING SECTION DRAWING NUMBER SHEET NUMBER
1	REVISION TAG / REVISION CLOUD
T	WALL ASSEMBLY TAG
101	ROOM NAME
150 SF	ROOM TAG
	WALL - NEW
	WALL - EXISTING
	WALL - DEMOLITION
AA	WINDOW TAG
#	KEY NOTE PER LEGEND

**CAMAS PUBLIC LIBRARY****CAMAS LIBRARY INTERIOR BUILDING IMPROVEMENTS****CAMAS LIBRARY INTERIOR BUILDING IMPROVEMENTS**625 NE 4TH AVE  
CAMAS, WA 98607

**SHEET TITLE**  
**GENERAL NOTES, ABBREVIATIONS, SYMBOLS**

SHEET NO.

**G001**

Drawn  
Checked  
Author  
Checker  
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 Suite 510  
 Seattle, WA 98121  
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 f 206.523.9382

**DRAWING INDEX****PROJECT INFORMATION**

G001	GENERAL NOTES, ABBREVIATIONS, SYMBOLS
G002	CODE SUMMARY
G003	ICC ACCESSIBILITY & MOUNTING REQUIREMENTS
V001	SURVEY
A201	LEVEL 1 - OVERALL FLOOR PLAN
A210	LEVEL 1 - DEMOLITION FLOOR PLANS
A211	LEVEL 1 - DEMOLITION RCPS
A221	LEVEL 1 - ENLARGED PLANS
A600	LEVEL 1 - REFLECTED CEILING PLAN
A610	LEVEL 1 - ENLARGED RCPS
A611	LEVEL 1 - ENLARGED RCPS
A700	FINISH SCHEDULE & LEGEND
A701	INTERIOR ELEVATIONS
A702	INTERIOR ELEVATIONS
A703	INTERIOR ELEVATIONS
A950	HVAC RELOCATION
A951	INTERIOR DETAILS
A952	INTERIOR DETAILS
A953	INTERIOR DETAILS - DISCOVERY HALLWAY
E000	ELECTRICAL
E001	SYMBOL LIST AND GENERAL NOTES - ELECTRIC
E002	LUMINAIRE SCHEDULE - LIGHTING
E003	LEVEL 1 DEMOLITION PLAN - LIGHTING
E004	LEVEL 1 DEMOLITION PLAN - POWER
E005	LEVEL 1 CEILING PLAN - LIGHTING
E006	LEVEL 1 FLOOR PLAN - POWER
E007	LEVEL 1 ENLARGED PLAN - CHILDREN'S LIBRARY - POWER
E008	LEVEL 1 ENLARGED PLAN - NON-FICTION - POWER
E009	SINGLE LINE DIAGRAMS - ELECTRICAL
E010	SCHEDULES - ELECTRICAL
E701	DETAILS - ELECTRICAL
L1	LANDSCAPE
L100	LANGO HANSEN
L101	1100 NE GLISAN, #3A
L102	PORLTAND, OR 97209
L103	PH: (206) 523-6150
L104	CONTACT: KATHERINE SHEIE
L105	KATHERINE@LANGOHANSEN.COM
SITE	STRUCTURAL:
SITE	CATENA CONSULTING ENGINEERS
SITE	1500 NE IRVING STREET, SUITE 412
SITE	PORTLAND, OR 97232
SITE	PH: (503) 380-8760
SITE	CONTACT: SARAH BURK
SITE	SARAH.BURK@JOHNSTONARCHITECTS.COM
SITE	MECHANICAL:
SITE	JOHNSTON ARCHITECTS LLC
SITE	3131 WESTERN AVE, SUITE 510
SITE	SEATTLE, WA 98121
SITE	PH: (206) 523-6150
SITE	CONTACT: JARED LEWIS
SITE	JARED@CATENAENGINEERS.COM
SITE	LANDSCAPE:
SITE	LANGO HANSEN
SITE	1100 NE GLISAN, #3A
SITE	PORLTAND, OR 97209
SITE	PH: (206) 523-6150
SITE	CONTACT: KATHERINE SHEIE
SITE	KATHERINE@LANGOHANSEN.COM
	</td

SYMBOL LEGEND	
ROOM NAME	ROOM NAME & NUMBER
100	
- SF	SQUARE FOOTAGE / OCCUPANCY
B	OCCUPANCY LOAD FACTOR
OCC/SF	TOTAL OCCUPANTS / # OF REQUIRED EXITS
- OCCS	
- EXITS REQ	
DOOR #	DOOR # (E = EXISTING)
- SF	DOOR OCCUPANTS SERVED
- IN. REQ.	REQUIRED DOOR WIDTH
- IN. WIDTH	ACTUAL DOOR WIDTH
FACP	FIRE ALARM CONTROL PANEL
FEC	FIRE EXTINGUISHER CABINET
FA	FIRE ALARM
F	FIRE ALARM PULL STATION
●	PATH OF EGRESS (MAX TRAVEL DISTANCE)
—	COMMON PATH OF TRAVEL
×	EXIT SIGN

## APPLICABLE CODES

ZONING CODE: CITY OF CAMAS  
 BUILDING CODE: 2021 INTERNATIONAL BUILDING CODE  
 ENERGY CODE: 2021 WASHINGTON STATE ENERGY CODES (WSEC)  
 PLUMBING CODE: 2021 UNIFORM PLUMBING CODE (UPC)  
 MECHANICAL CODE: 2021 INTERNATIONAL MECHANICAL CODE  
 ELECTRICAL CODE: 2020 WASHINGTON CITIES ELECTRICAL CODE  
 FIRE PROTECTION: 2021 INTERNATIONAL FIRE CODE  
 ACCESSIBILITY: 2017 ICC A117.1 ACCESSIBLE AND USEABLE BUILDINGS AND FACILITIES  
 IBC CHAPTER 11 AND APPENDIX E FOR ACCESSIBILITY

## DEFERRED SUBMITTALS

- MEP EQUIPMENT, ANCHORAGE, AND BRACING
- CEILING AND CEILING SUPPORTS
- LOW VOLTAGE
- CONSTRUCTION (ROW) PERMIT

## BUILDING CODE SUMMARY:


PROJECT ADDRESS: 625 NE 4TH AVE  
 CAMAS, WA 98607  
 DESCRIPTION: THIS PROJECT IS A PROPOSED RENOVATION OF AN EXISTING PUBLIC LIBRARY WITH ASSOCIATED BUSINESS AREAS. NO CHANGE OF OCCUPANCY IS PROPOSED.  
 ORIGINAL PERMIT #:   
 ZONING: DC (DOWNTOWN COMMERCIAL)  
 CONSTRUCTION TYPE: V-A (EXISTING)  
 BUILDING HEIGHT: NO MAXIMUM HEIGHT FOR DC ZONE PER 18.09.030 TABLE 1  
 NO CHANGE TO STRUCTURE HEIGHT PROPOSED  
 SPRINKLER: NO  
 FIRE ALARM: YES  
 BUILDING AREA (ABOVE GRADE):  
 EXISTING LEVEL 1 17,914 SF  
 EXISTING LEVEL 2 8,455 SF  
 TOTAL BUILDING AREA 26,303 SF  
 PROJECT AREA: 10,672 SF

12494  
 REGISTERED  
 ARCHITECT  
 Mona Zellers  
 STATE OF WASHINGTON

## CAMAS LIBRARY INTERIOR BUILDING IMPROVEMENTS

625 NE 4TH AVE  
 CAMAS, WA 98607


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 # DATE DESCRIPTION  
 01/14/2026 100% CONSTRUCTION DOCUMENTS

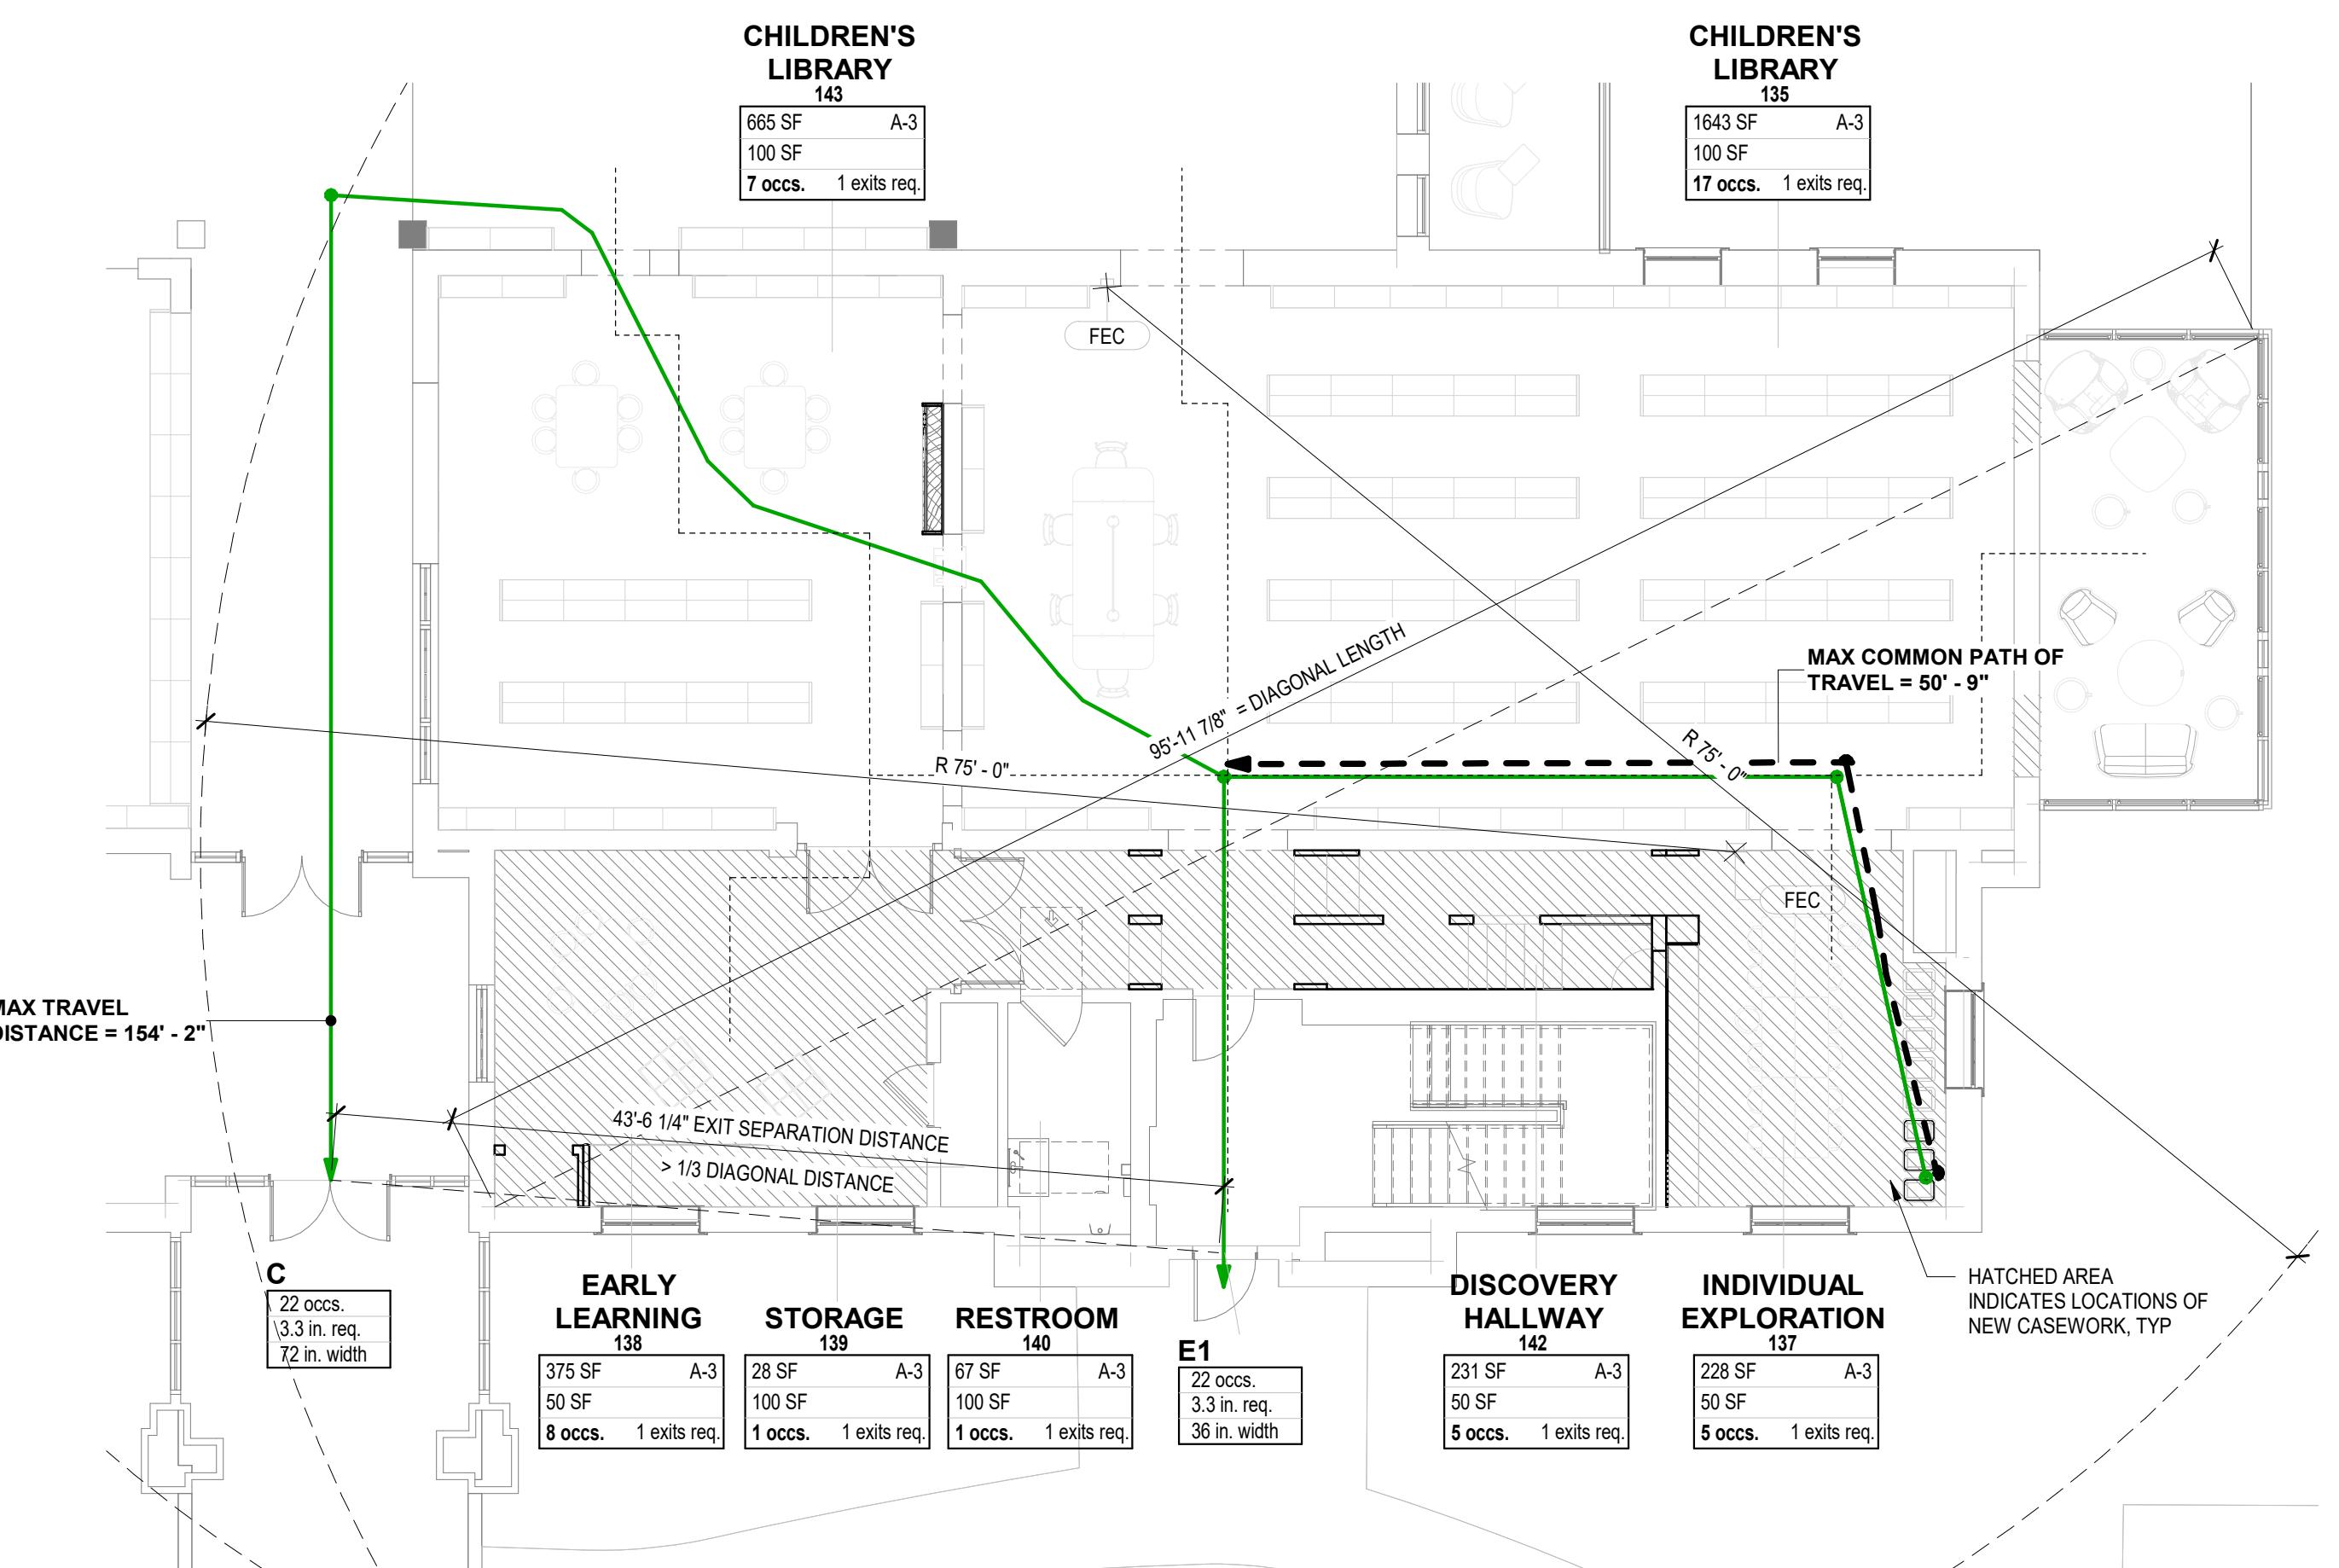









## CAMAS LIBRARY INTERIOR BUILDING IMPROVEMENTS

625 NE 4TH AVE  
CAMS, WA 98607

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01/14/2026 100% CONSTRUCTION DOCUMENTS




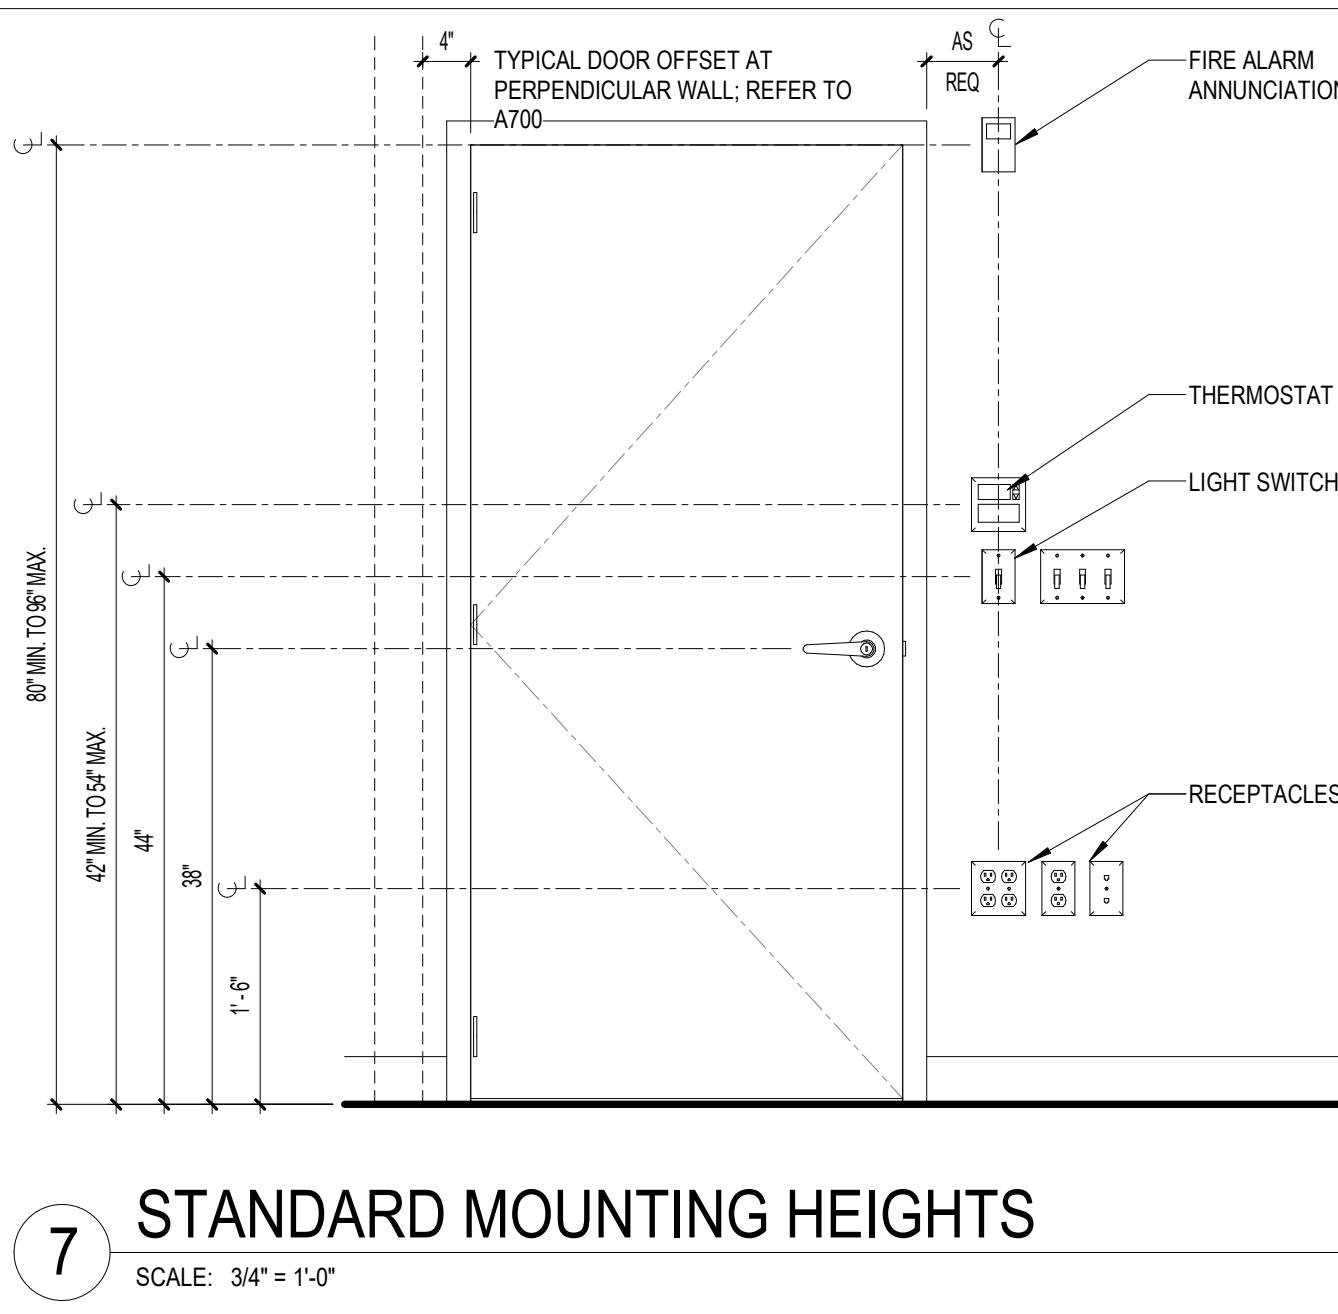


**NOTE:**  
OPERABLE PARTS SHALL BE OPERABLE WITH ONE HAND AND SHALL NOT REQUIRE TIGHT GRASPING, PINCHING, OR TWISTING OF THE WRIST. THE FORCE REQUIRED TO ACTIVATE OPERABLE PARTS SHALL BE 5 POUNDS (22.2 N) MAX.

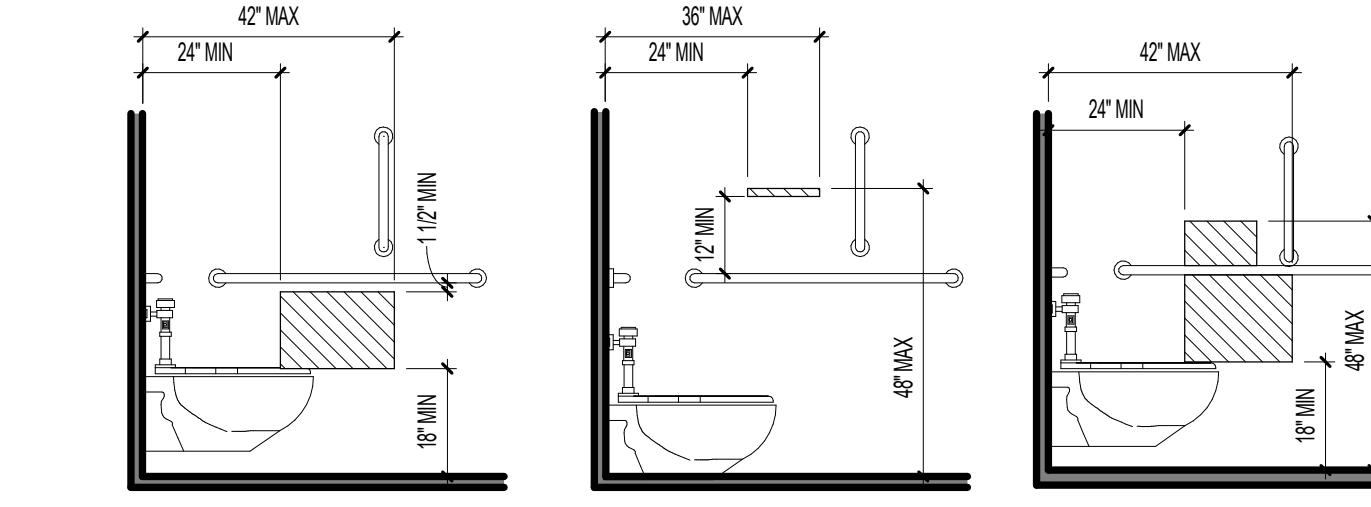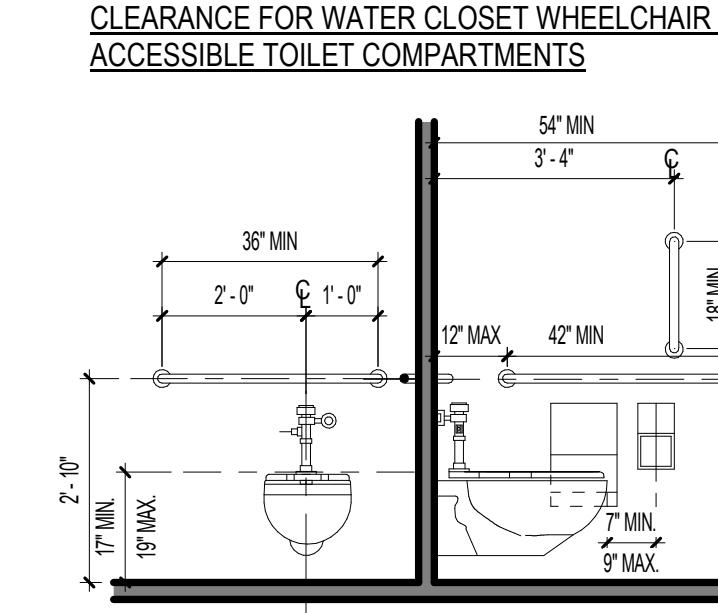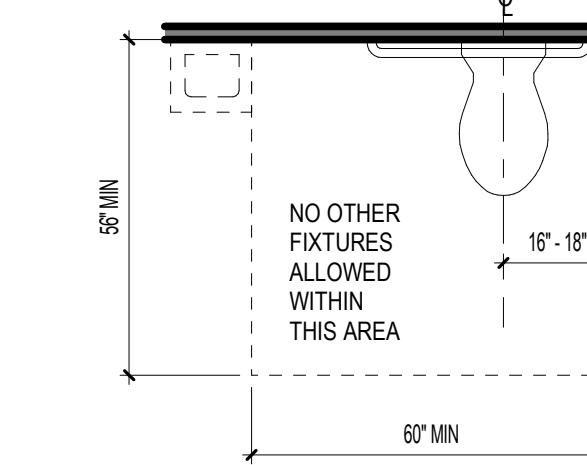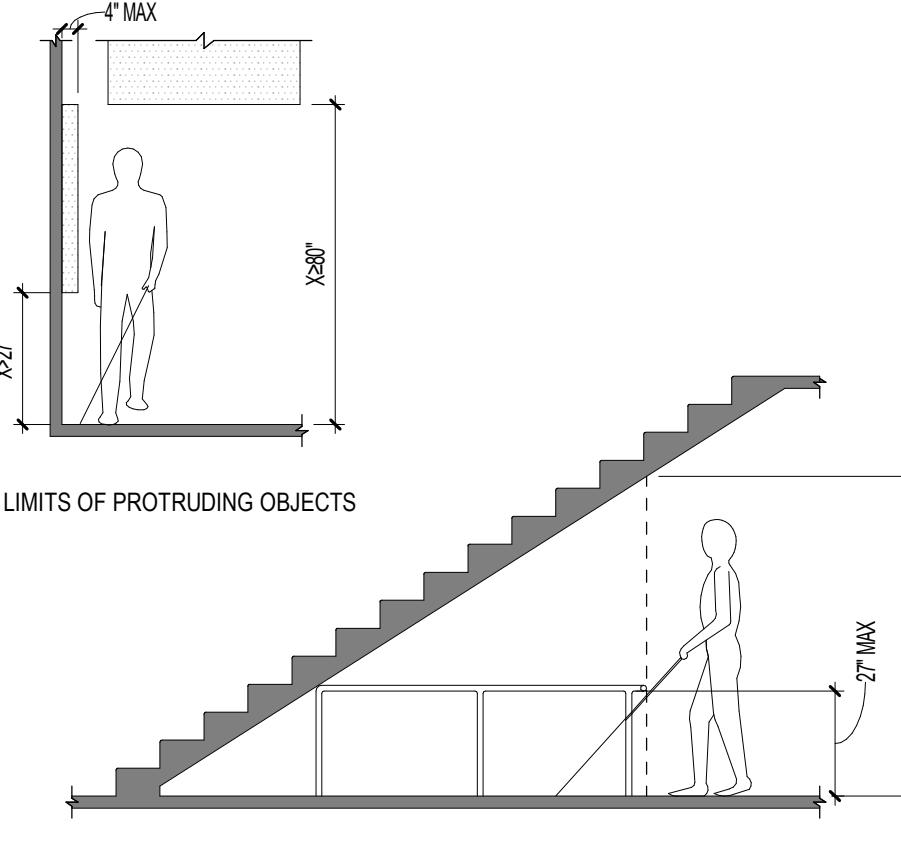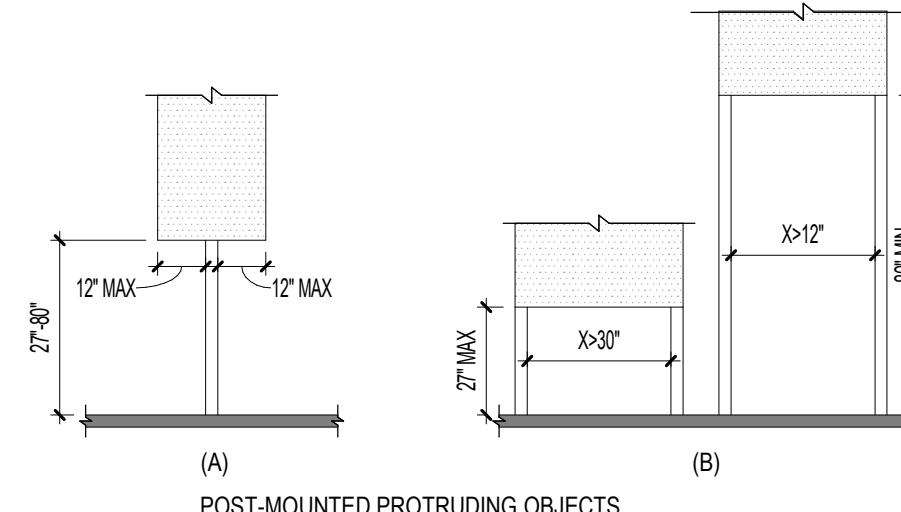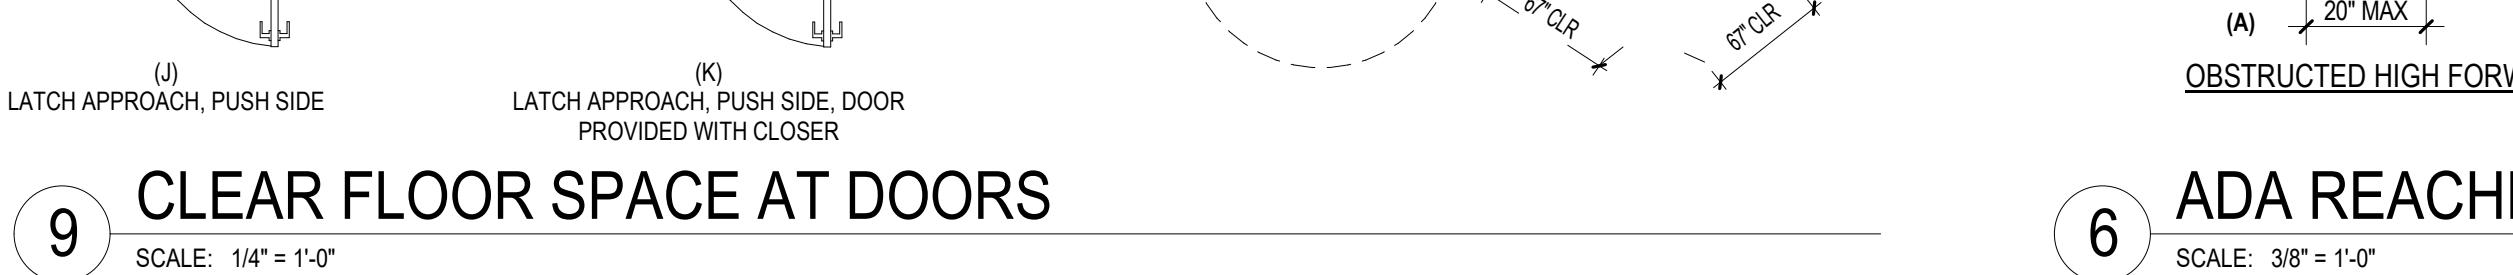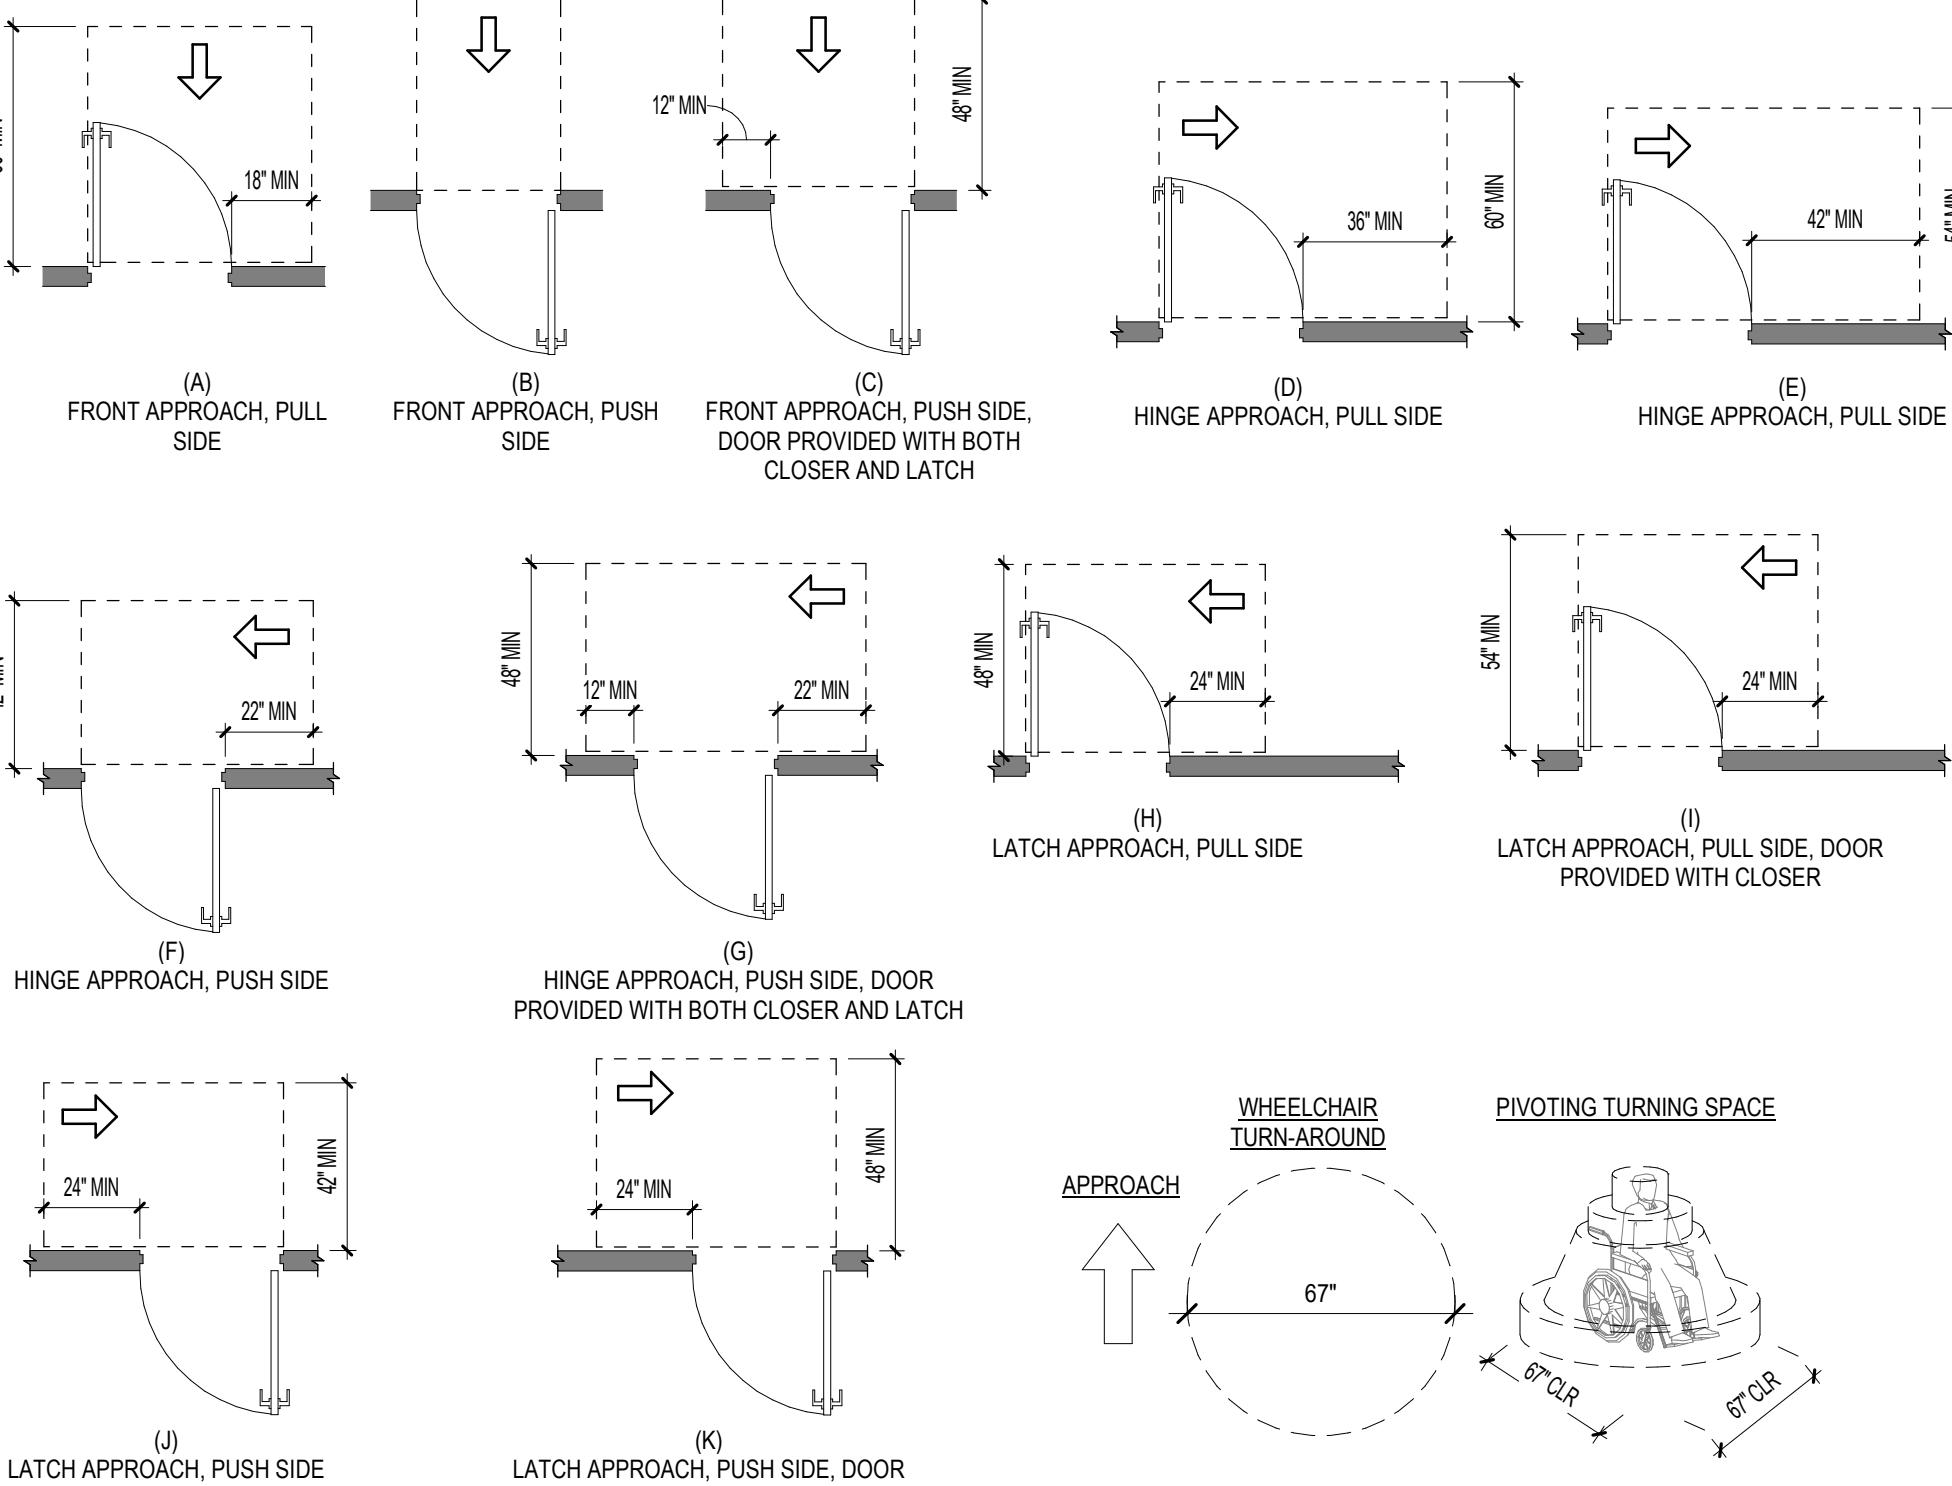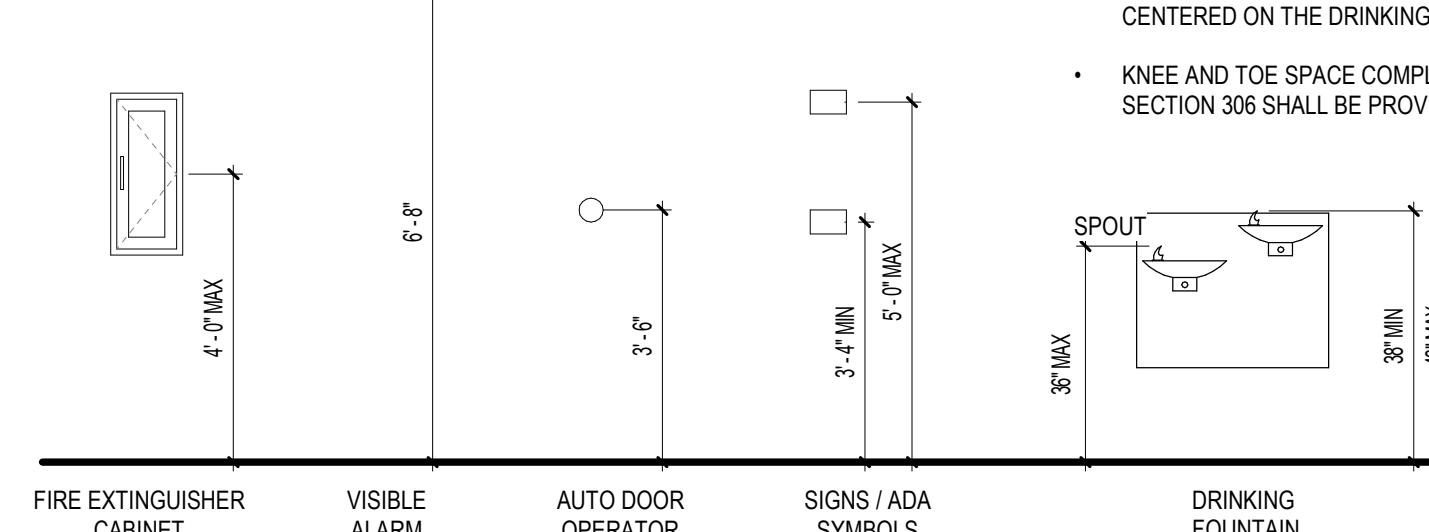

**NOTE:**  
WHERE ACCESSIBILITY IS REQUIRED, THE OPERATING PARTS OF LIGHTING CONTROLS, ELECTRICAL SWITCHES AND RECEPTACLES, ENVIRONMENTAL CONTROLS, APPLIANCE CONTROLS, OPERATING HARDWARE FOR OPERABLE WINDOWS, PLUMBING FIXTURE CONTROLS, AND USER CONTROLS FOR SECURITY OR INTERCOM SYSTEMS SHALL COMPLY WITH SECTION 309 OF ANSI / ICC A117.1-2009. DRYING EQUIPMENT, TOWEL OR CLEANSING PRODUCT DISPENSERS, AND DISPOSAL FIXTURES SHALL BE 40" MAX AFF FOR REACH DEPTHS LESS THAN 6" EBC 110.2.7 AND WAC AMENDMENTS.

**NOTE:**  
HAND-OPERATED FAUCETS OPERABLE PARTS SHALL BE WITHIN REACH RANGE & EASY TO OPERATE WITH ONE HAND AND SHALL NOT REQUIRE TIGHT GRASPING, PINCHING, OR TWISTING OF THE WRIST. THE FORCE REQUIRED TO ACTIVATE OPERABLE PARTS SHALL BE 5 POUNDS (22.2 N) MAX.

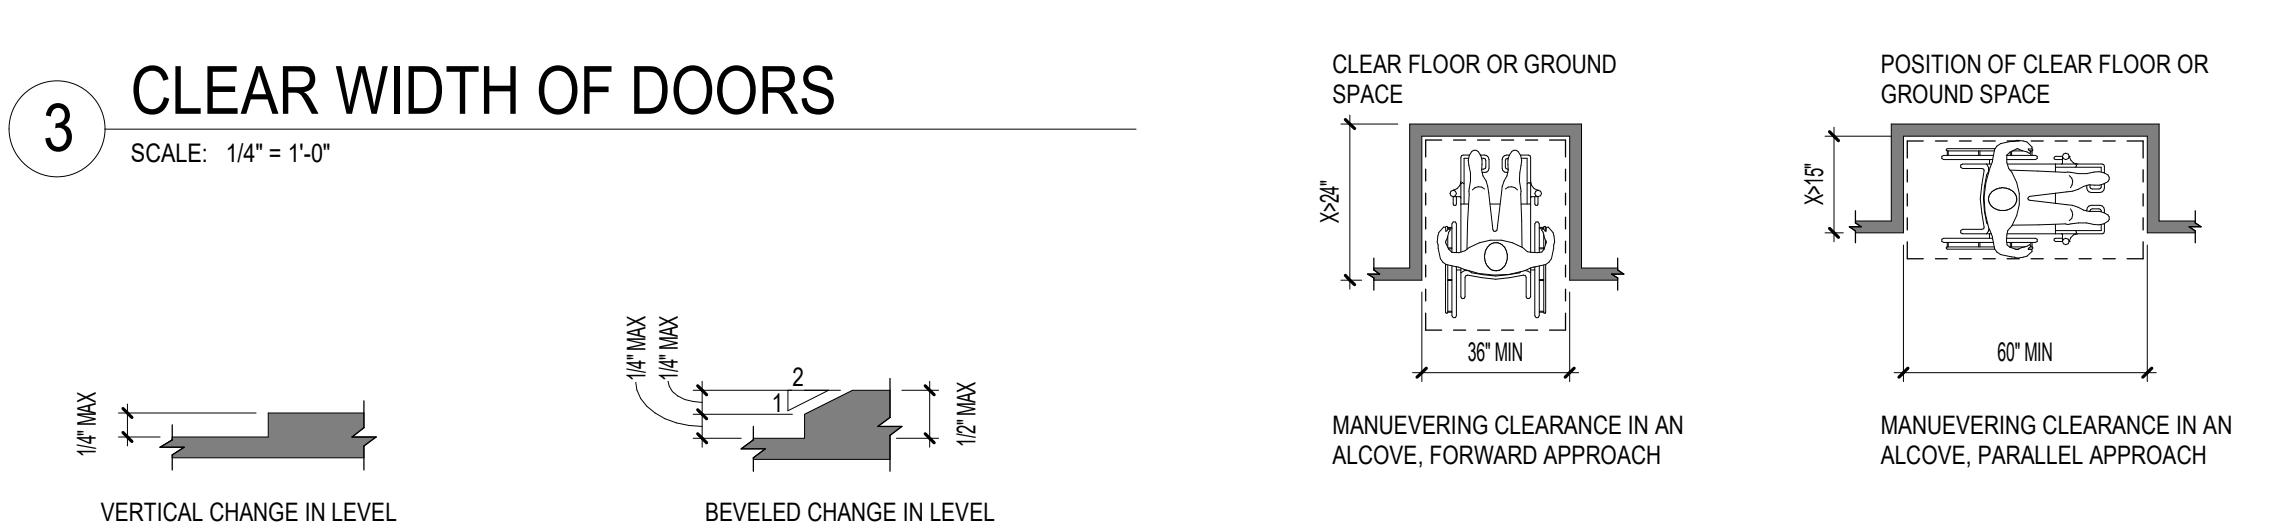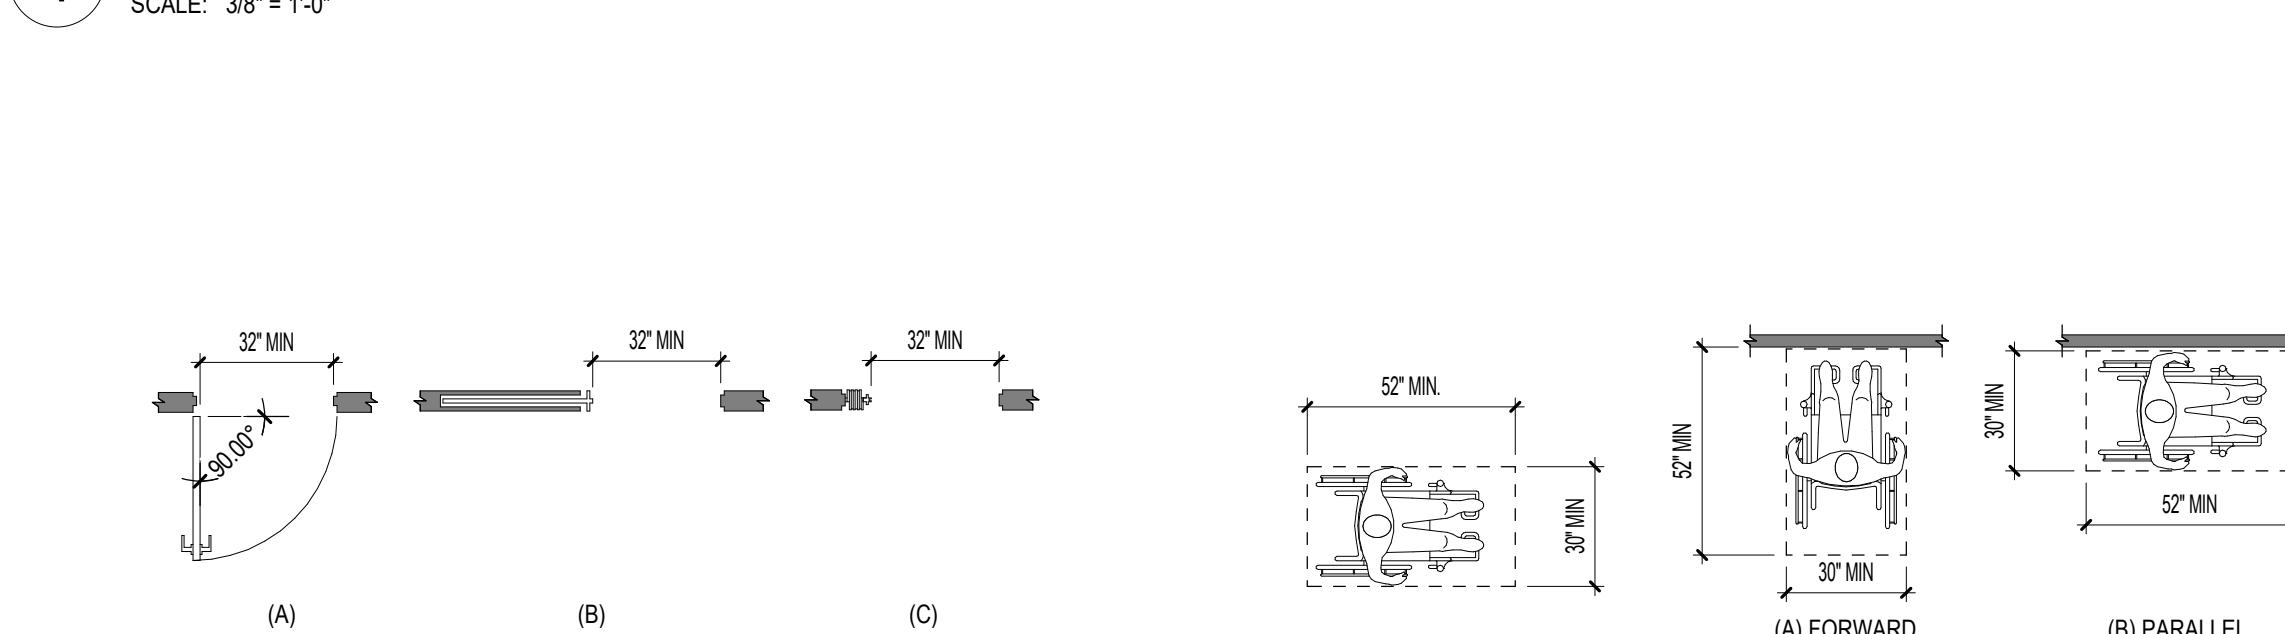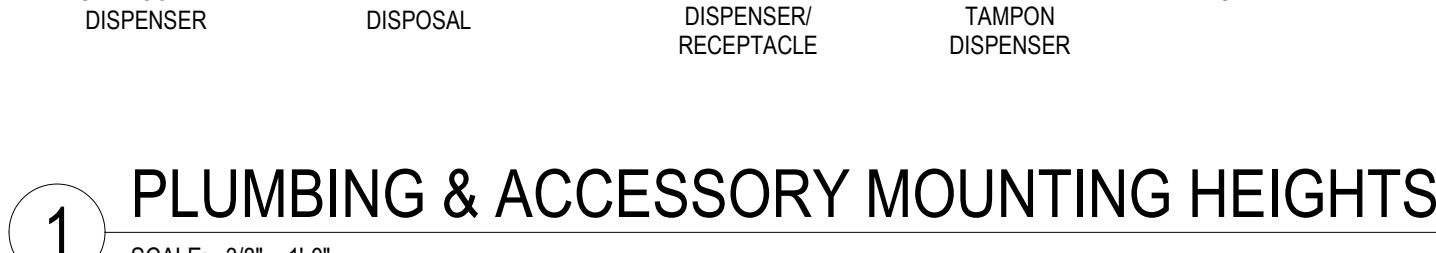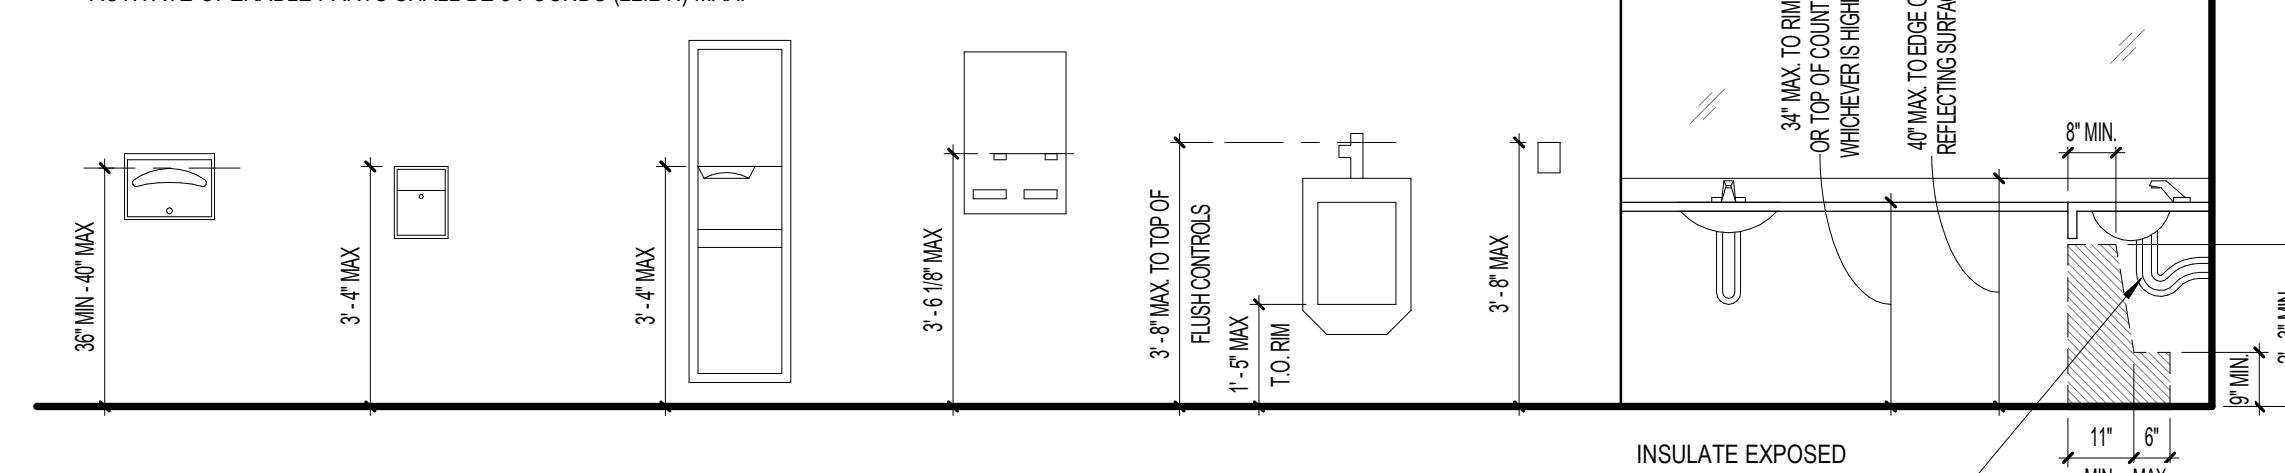

**SHEET TITLE**  
**ICC ACCESSIBILITY & MOUNTING REQUIREMENTS**

**SHEET NO.**

**G003**


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MAC, LB  
AWB

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# TOPOGRAPHIC SURVEY CAMAS LIBRARY


BLOCK 35, PLAT OF LA CAMAS,  
A PORTION OF THE H J G MAXON DLC,  
SITUATED IN THE SW 1/4 OF THE NE 1/4 OF SECTION 11,  
TOWNSHIP 1 NORTH, RANGE 3 EAST, W.M.,  
CITY OF CAMAS, CLARK COUNTY, WASHINGTON

PREPARED FOR  
ITY OF CAMAS  
EBRUARY 25, 2024

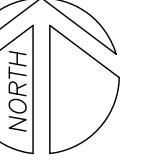

**BASIS OF BEARINGS**

PLAT OF LA CAMAS R-25

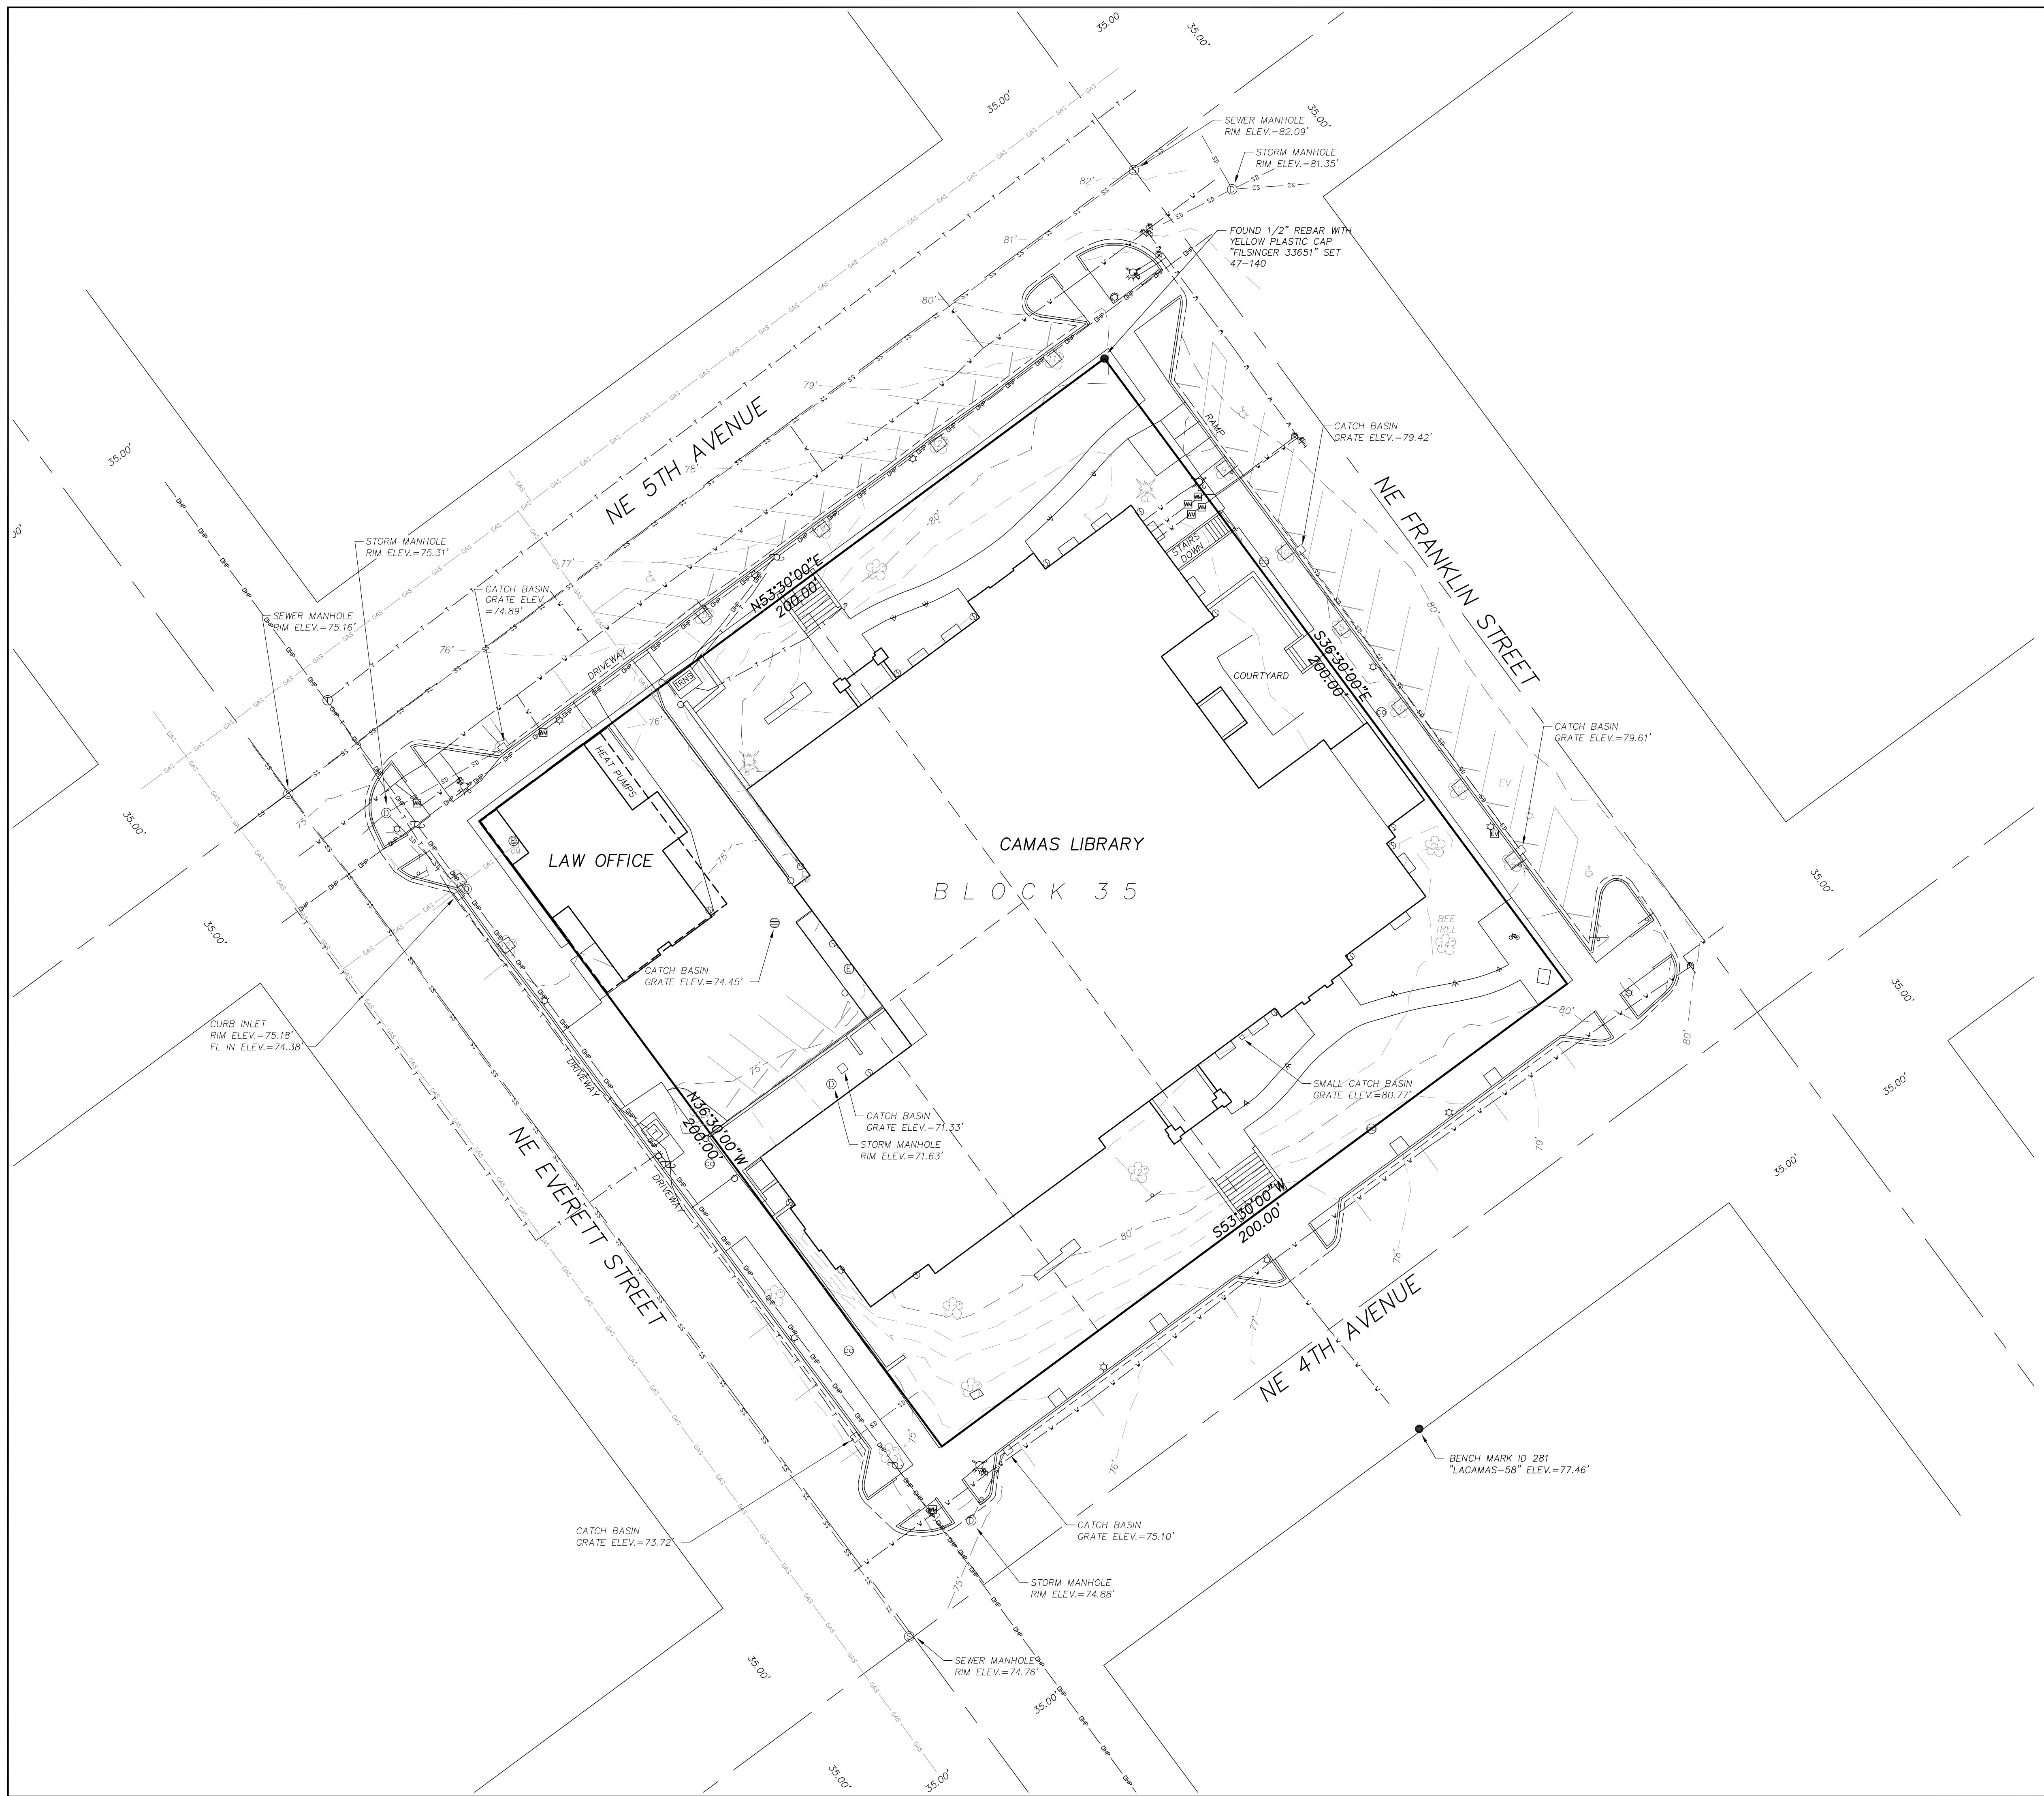

## LEGEND

- FOUND LOT CORNER AS SHOWN
- ◎ SANITARY SEWER MANHOLE
- ◎ SANITARY SEWER CLEANOUT
- ◎ STORM DRAINAGE MANHOLE
- STORM DRAINAGE CATCH BASIN
- ◎ STORM DRAINAGE CATCH BASIN (ROUND)
- ◎ STORM GUTTER TO BELOW GROUND
- FIRE HYDRANT
- FIRE DEPARTMENT CONNECTION
- WATER METER
- WATER VALVE
- UTILITY POLE
- LIGHT
- ↖ SMALL DECORATIVE LIGHT
- GUY WIRE
- ELECTRIC METER
- ELECTRIC PANEL
- TRANSFORMER
- ELECTRIC VEHICLE CHARGER
- TELEPHONE MANHOLE
- TELEPHONE PANEL
- SIGN
- BOLLARD
- HANDICAPPED PARKING
- GAS METER
- GAS VALVE
- DECIDUOUS TREE WITH DIAMETER AS SHOWN
- CONIFEROUS TREE WITH DIAMETER AS SHOWN
- SD — SD — UNDERGROUND STORM DRAINAGE LINE
- SS — SS — UNDERGROUND SANITARY SEWER LINE
- W — W — UNDERGROUND WATER LINE
- GAS — GAS — UNDERGROUND GAS LINE
- OHP — OHP — OVERHEAD UTILITY LINE
- T — T — UNDERGROUND TELEPHONE LINE



JOB NO.


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OF 1

## NOTES:

UTILITY LINES ARE APPROXIMATE, BASED UPON SURFACE  
STRUCTURES AND UTILITY LOCATE PAINT MARKS BY OTHERS


BOUNDARY LINES ARE APPROXIMATE, BASED UPON ONE REMAINING  
BLOCK CORNER AS SET BY SURVEY IN BOOK 47, PAGE 140 AND  
THE STREET ALIGNMENTS.



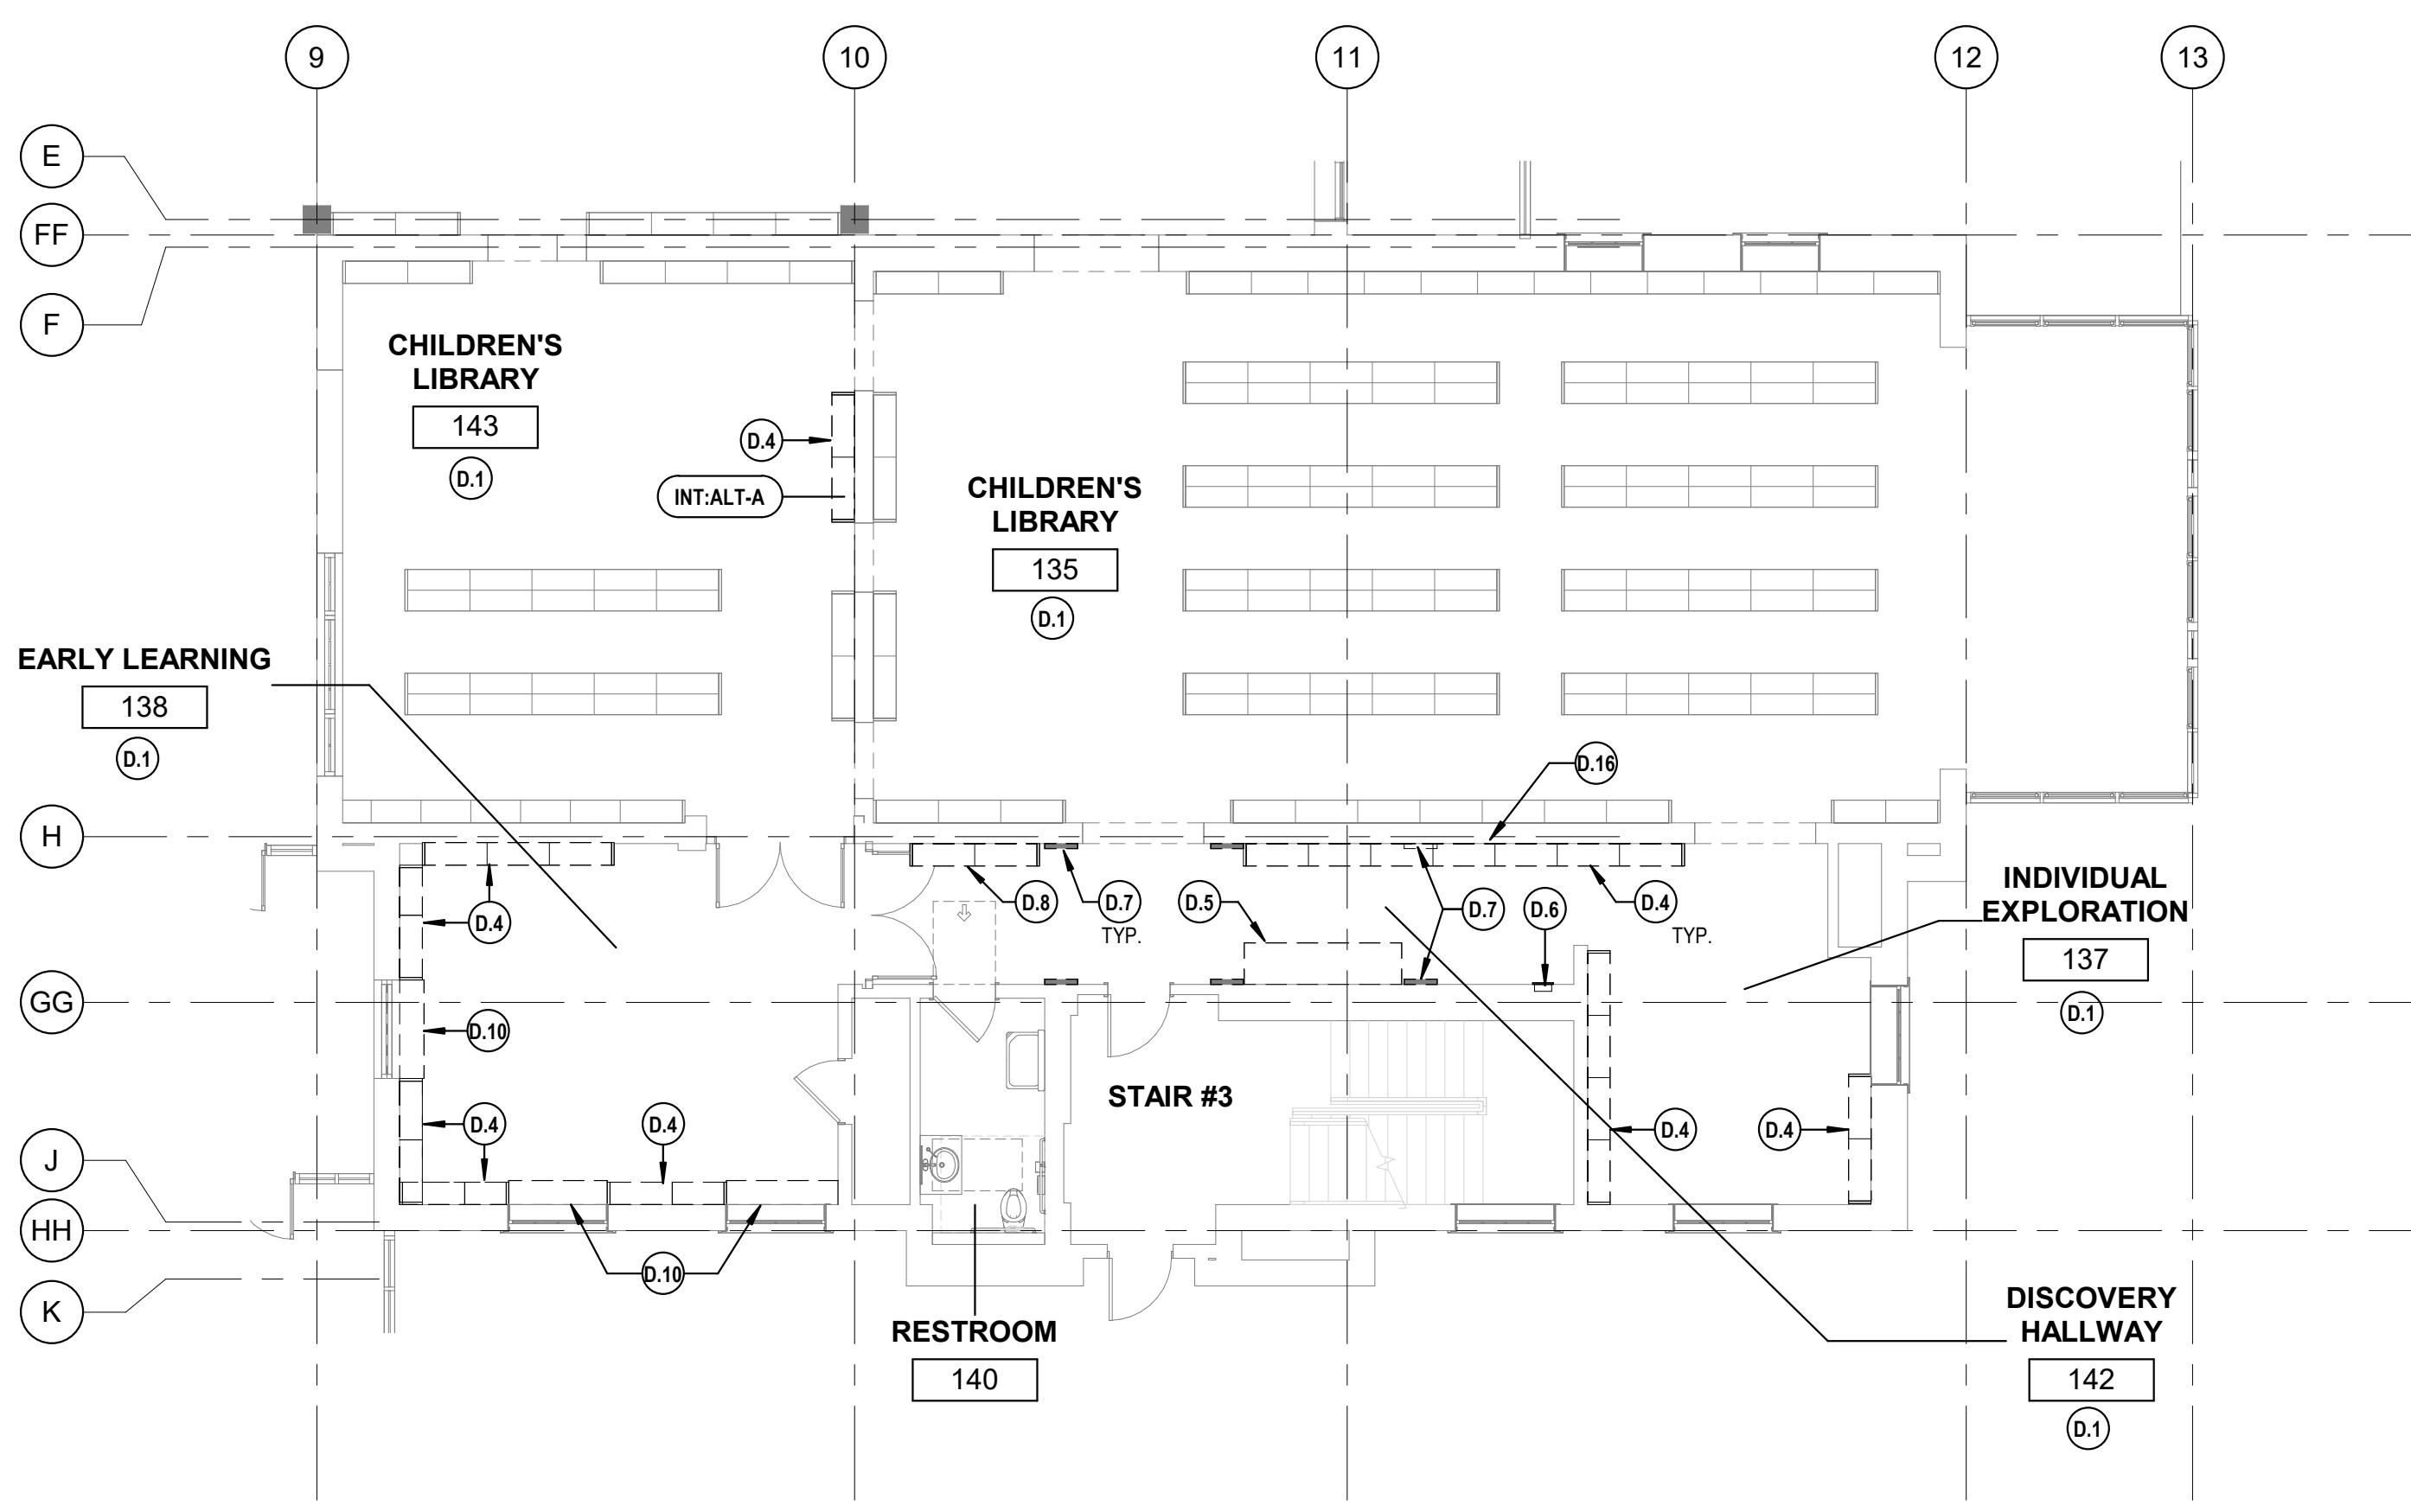

1 LEVEL 1 - DEMOLITION PLAN - CHILDREN'S LIBRARY

SCALE: 1/8" = 1'-0"

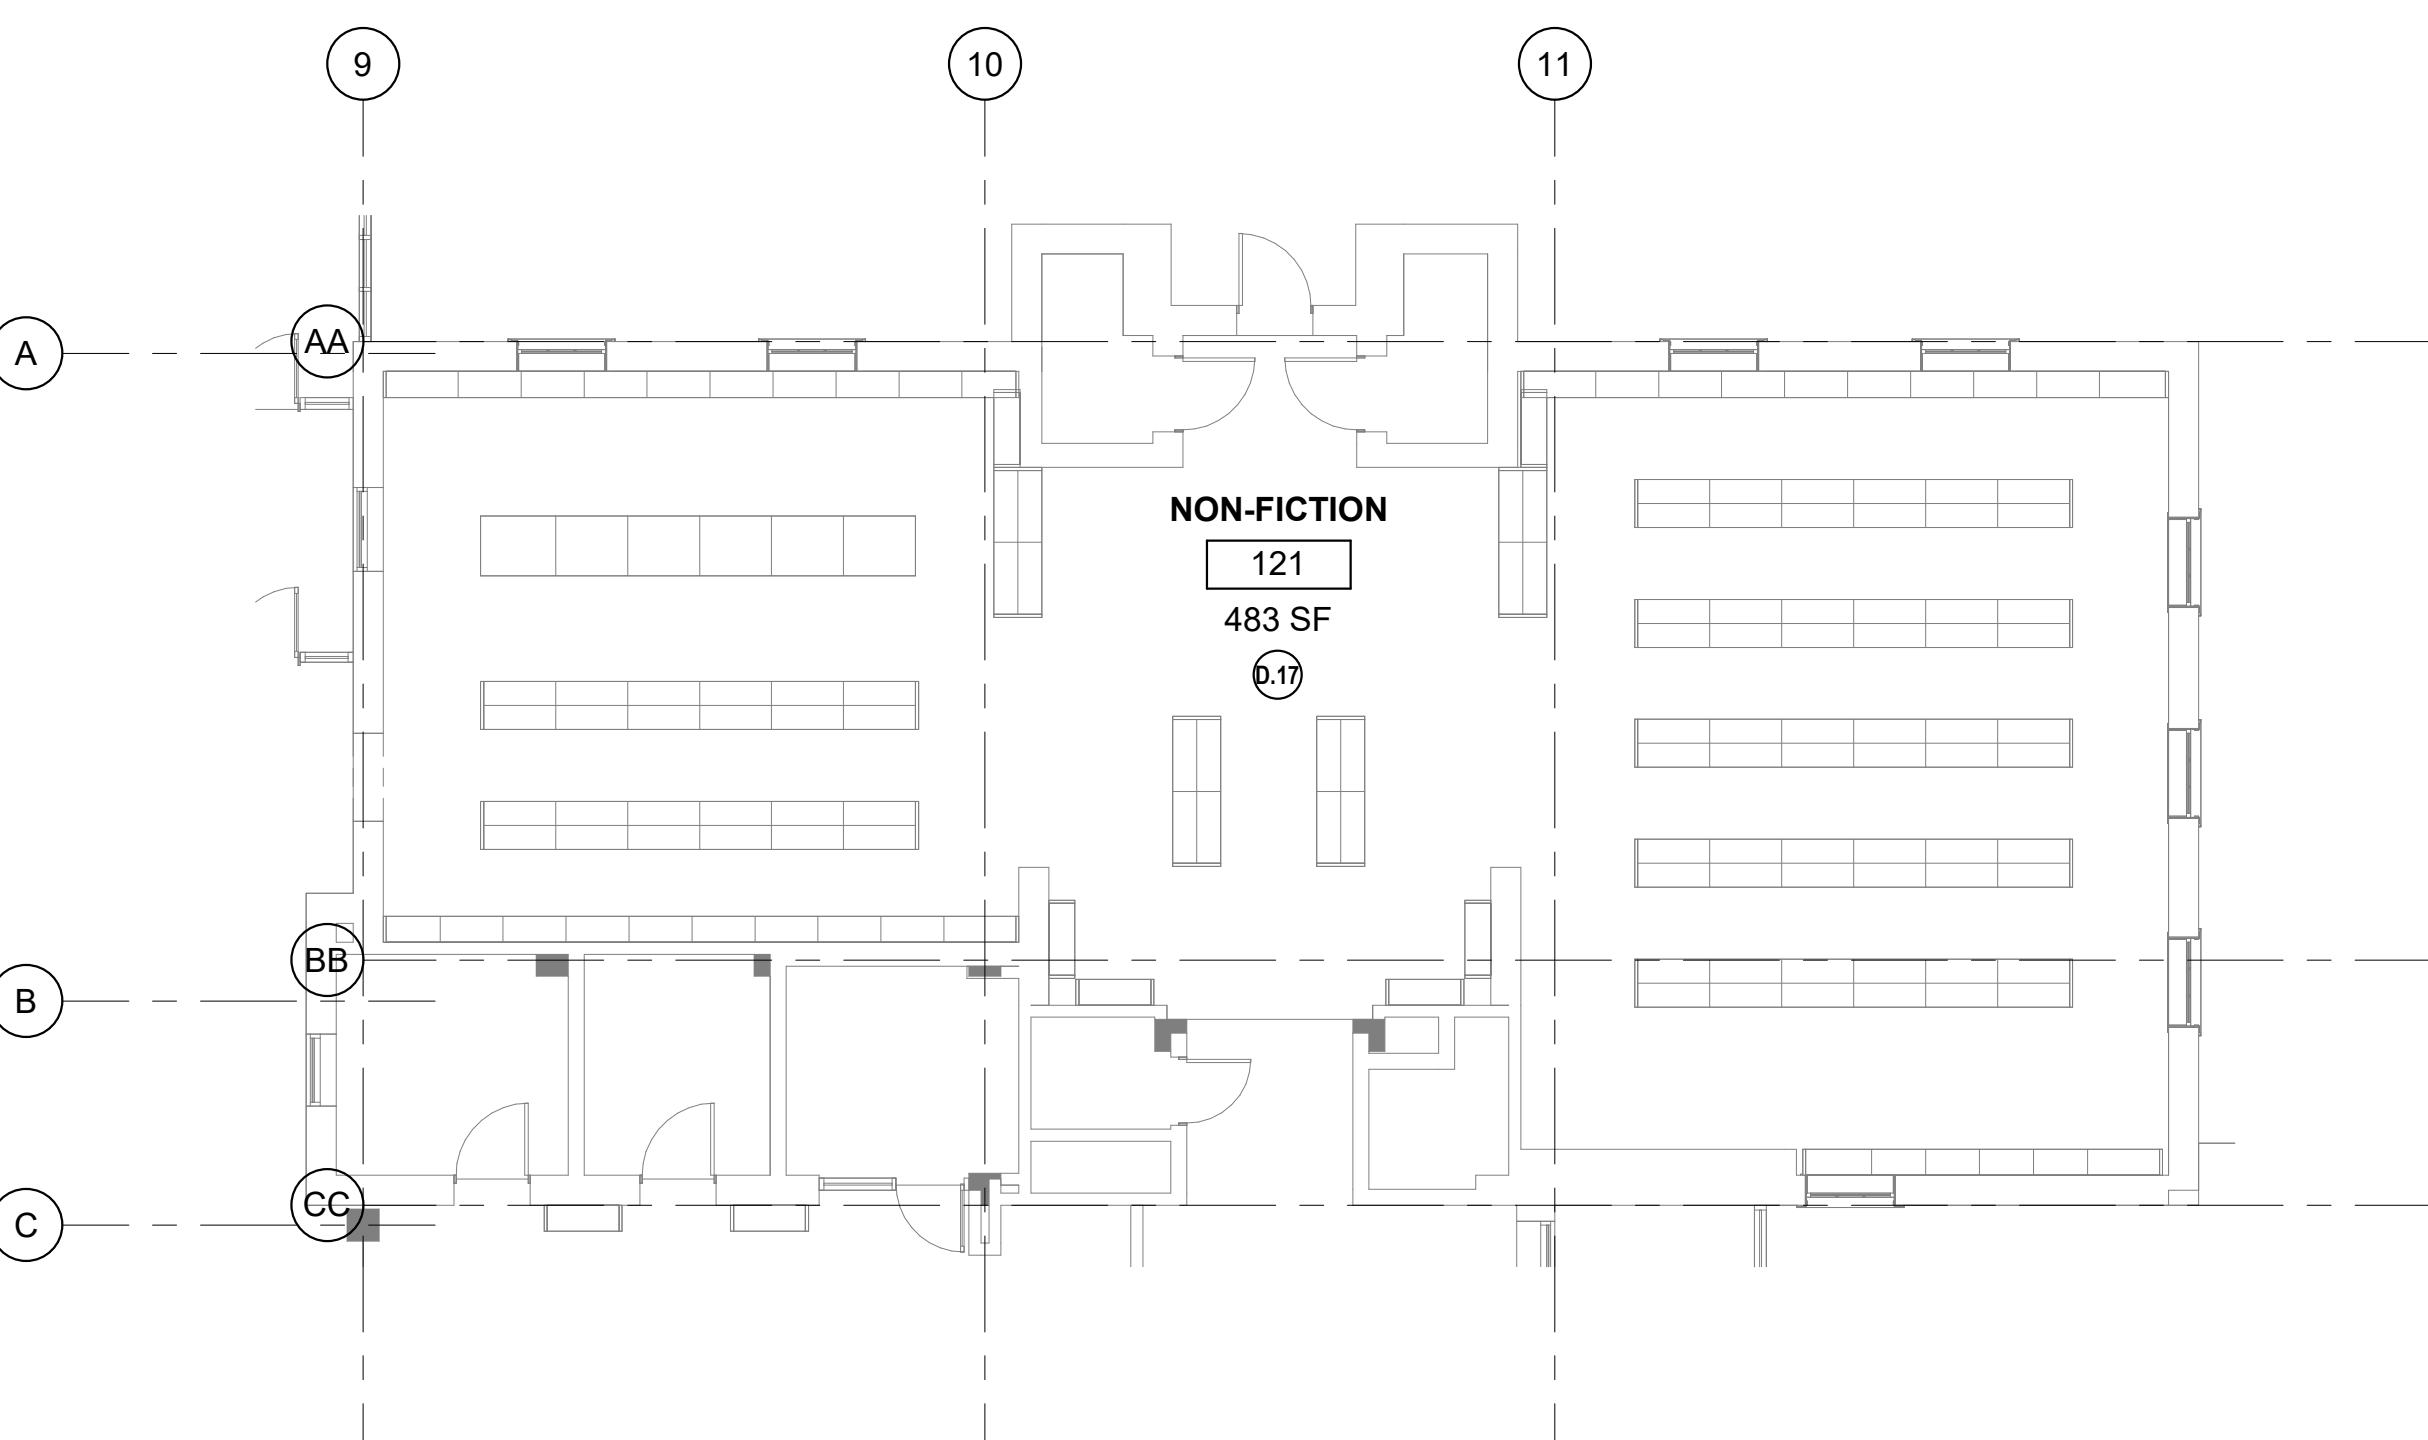

2 LEVEL 1 - DEMOLITION PLAN - NON-FICTION

SCALE: 1/8" = 1'-0"

**DEMOLITION GENERAL NOTES**

- SEE G001 FOR NOTES APPLICABLE TO ALL PORTIONS OF THE WORK.
- THE CONTRACTOR SHALL COORDINATE ALL DEMOLITION AND PHASING EFFORTS WITH THE ARCHITECT AND OWNER'S REPRESENTATIVE. EVERY EFFORT SHALL BE MADE TO MINIMIZE DISRUPTION OF OWNER'S OPERATIONS. EXCESSIVE NOISE OR VIBRATION SHALL BE PRE-APPROVED AND COORDINATED WITH THE OWNER'S REPRESENTATIVE. IN ALL CASES, PROVISIONS SHALL BE MADE FOR USER'S SAFETY.
- MAINTAIN MEANS OF EGRESS THROUGHOUT THE WORK.
- MAINTAIN A SECURE SPACE AT ALL TIMES.
- VERIFY ALL EXISTING CONDITIONS, DIMENSIONS AND ELEVATIONS IN-FIELD AND NOTIFY THE ARCHITECT OF ANY DISCREPANCIES.
- REMOVE IN THEIR ENTIRETY ALL EXISTING WALLS, DOORS, MILLWORK, PLUMBING FIXTURES, CEILINGS, SOFFITS, MARKERBOARDS, AND OTHER ITEMS, AS REQUIRED TO EXECUTE THE DEMOLITION AND CONSTRUCTION WORK DESCRIBED BY THE DRAWINGS.
- OWNER HAS FIRST SALVAGE RIGHTS TO ALL ITEMS NOT BEING UTILIZED IN THIS SCOPE OF WORK. VERIFY SALVAGE DESIRES PRIOR TO DISPOSAL.
- EXISTING MATERIALS SHALL NOT BE REUSED UNLESS NOTED OTHERWISE OR AS AUTHORIZED BY ARCHITECT.
- SEE MECHANICAL AND ELECTRICAL DRAWINGS AND NOTES FOR FURTHER SEQUENCING AND SCOPE OF WORK.
- REMOVE ALL FURNITURE AND EQUIPMENT FROM AREA OF WORK. SALVAGE AS REQUIRED FOR NEW LAYOUT, SHEET XXXX. DISPOSE OF ITEMS NOT NEEDED FOR NEW SPACE.


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f 206.523.9382

12494 REGISTERED ARCHITECT  
Mona Zellers  
Mona Zellers  
STATE OF WASHINGTON

CAMAS LIBRARY INTERIOR BUILDING  
IMPROVEMENTS

625 NE 4TH AVE  
CAMSAS, WA 98607

DRAWING ISSUE  
# DATE DESCRIPTION  
01/14/2026 100% CONSTRUCTION DOCUMENTS

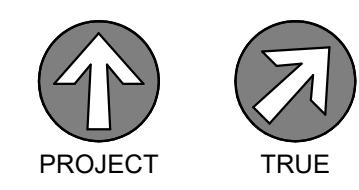


SHEET TITLE  
LEVEL 1 -  
DEMOLITION  
FLOOR PLANS

SHEET NO.

**A210**

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Author  
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#### DEMOLITION GENERAL NOTES

- SEE G001 FOR NOTES APPLICABLE TO ALL PORTIONS OF THE WORK.
- THE CONTRACTOR SHALL COORDINATE ALL DEMOLITION AND PHASING EFFORTS WITH THE ARCHITECT AND OWNER'S REPRESENTATIVE. EVERY EFFORT SHALL BE MADE TO MINIMIZE DISRUPTION OF OWNER'S OPERATIONS. EXCESSIVE NOISE OR VIBRATION SHALL BE PRE-APPROVED AND COORDINATED WITH THE OWNER'S REPRESENTATIVE. IN ALL CASES, PROVISIONS SHALL BE MADE FOR USER'S SAFETY.
- MANTAIN MEANS OF EGRESS THROUGHOUT THE WORK.
- MANTAIN A SECURE SPACE AT ALL TIMES.
- VERIFY ALL EXISTING CONDITIONS, DIMENSIONS AND ELEVATIONS IN-FIELD AND NOTIFY THE ARCHITECT OF ANY DISCREPANCIES.
- REMOVE IN THEIR ENTIRETY ALL EXISTING WALLS, DOORS, MILLWORK, PLUMBING FIXTURES, CEILINGS, SOFFITS, MARKERBOARDS, AND OTHER ITEMS, AS REQUIRED TO EXECUTE THE DEMOLITION AND CONSTRUCTION WORK DESCRIBED BY THE DRAWINGS.
- OWNER HAS FIRST SALVAGE RIGHTS TO ALL ITEMS NOT BEING UTILIZED IN THIS SCOPE OF WORK. VERIFY SALVAGE DESIRES PRIOR TO DISPOSAL.
- EXISTING MATERIALS SHALL NOT BE REUSED UNLESS NOTED OTHERWISE OR AS AUTHORIZED BY ARCHITECT.
- SEE MECHANICAL AND ELECTRICAL DRAWINGS AND NOTES FOR FURTHER SEQUENCING AND SCOPE OF WORK.
- REMOVE ALL FURNITURE AND EQUIPMENT FROM AREA OF WORK. SALVAGE AS REQUIRED FOR NEW LAYOUT, SHEET XXXX. DISPOSE OF ITEMS NOT NEEDED FOR NEW SPACE.

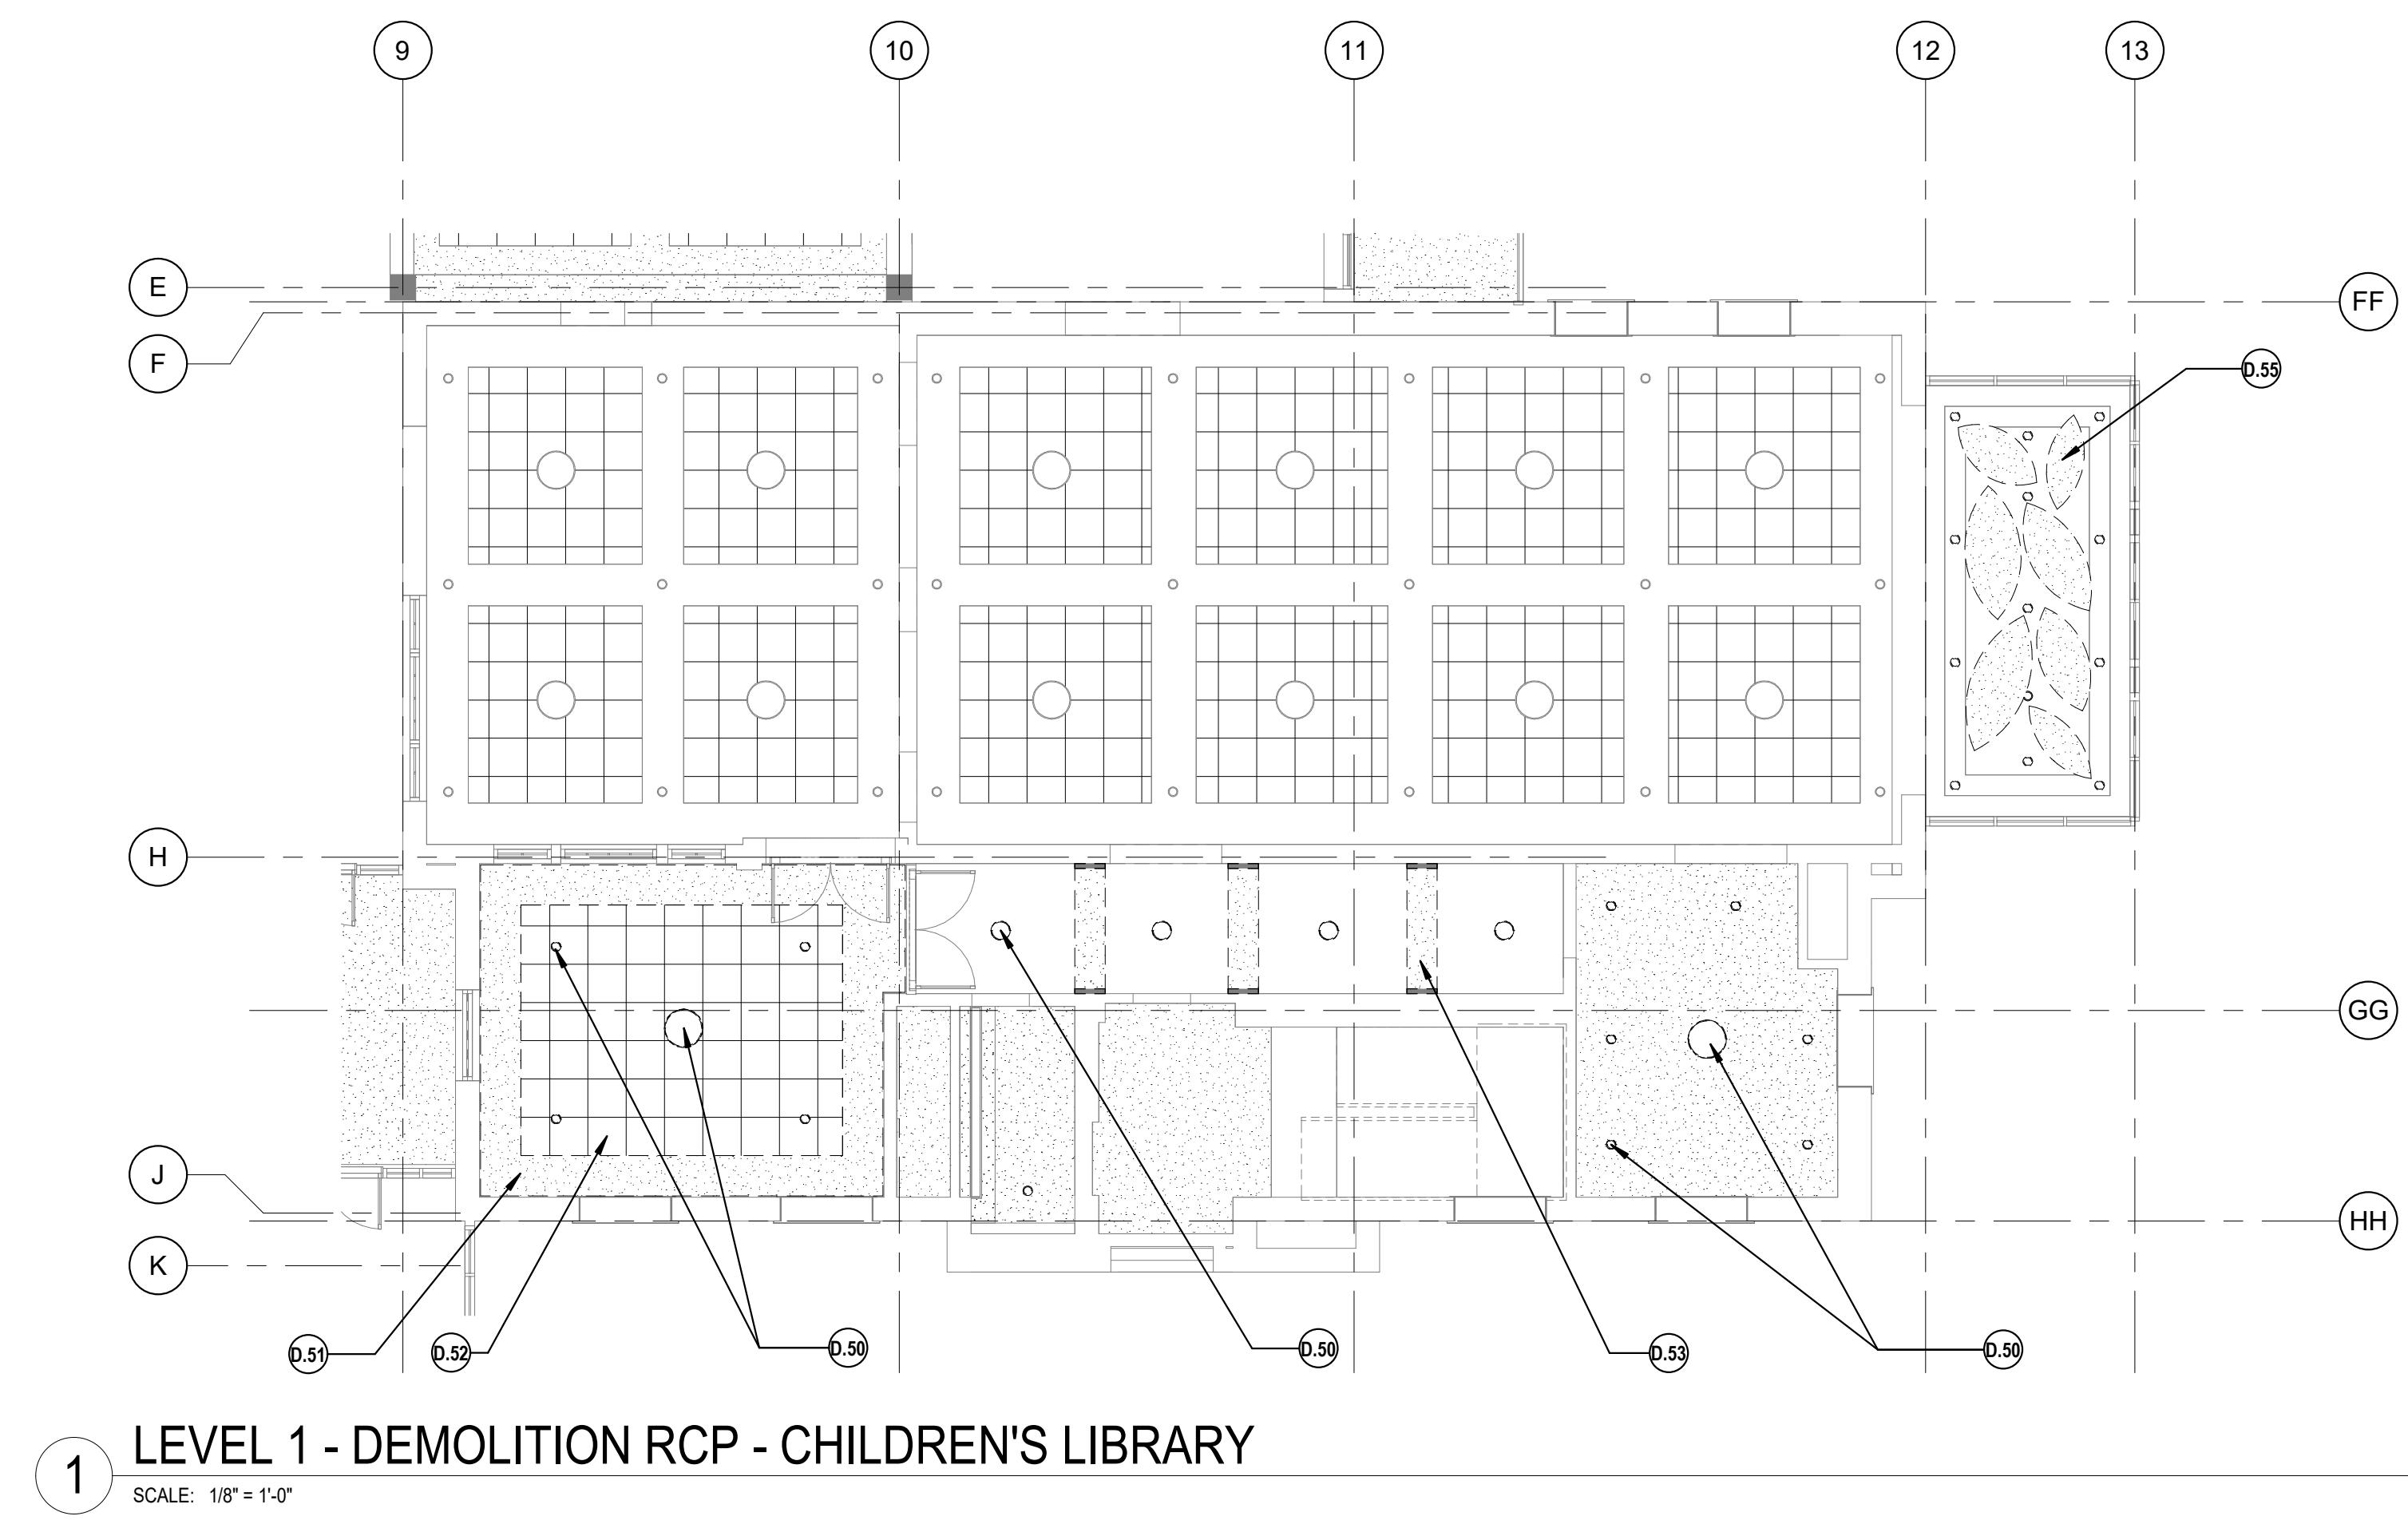
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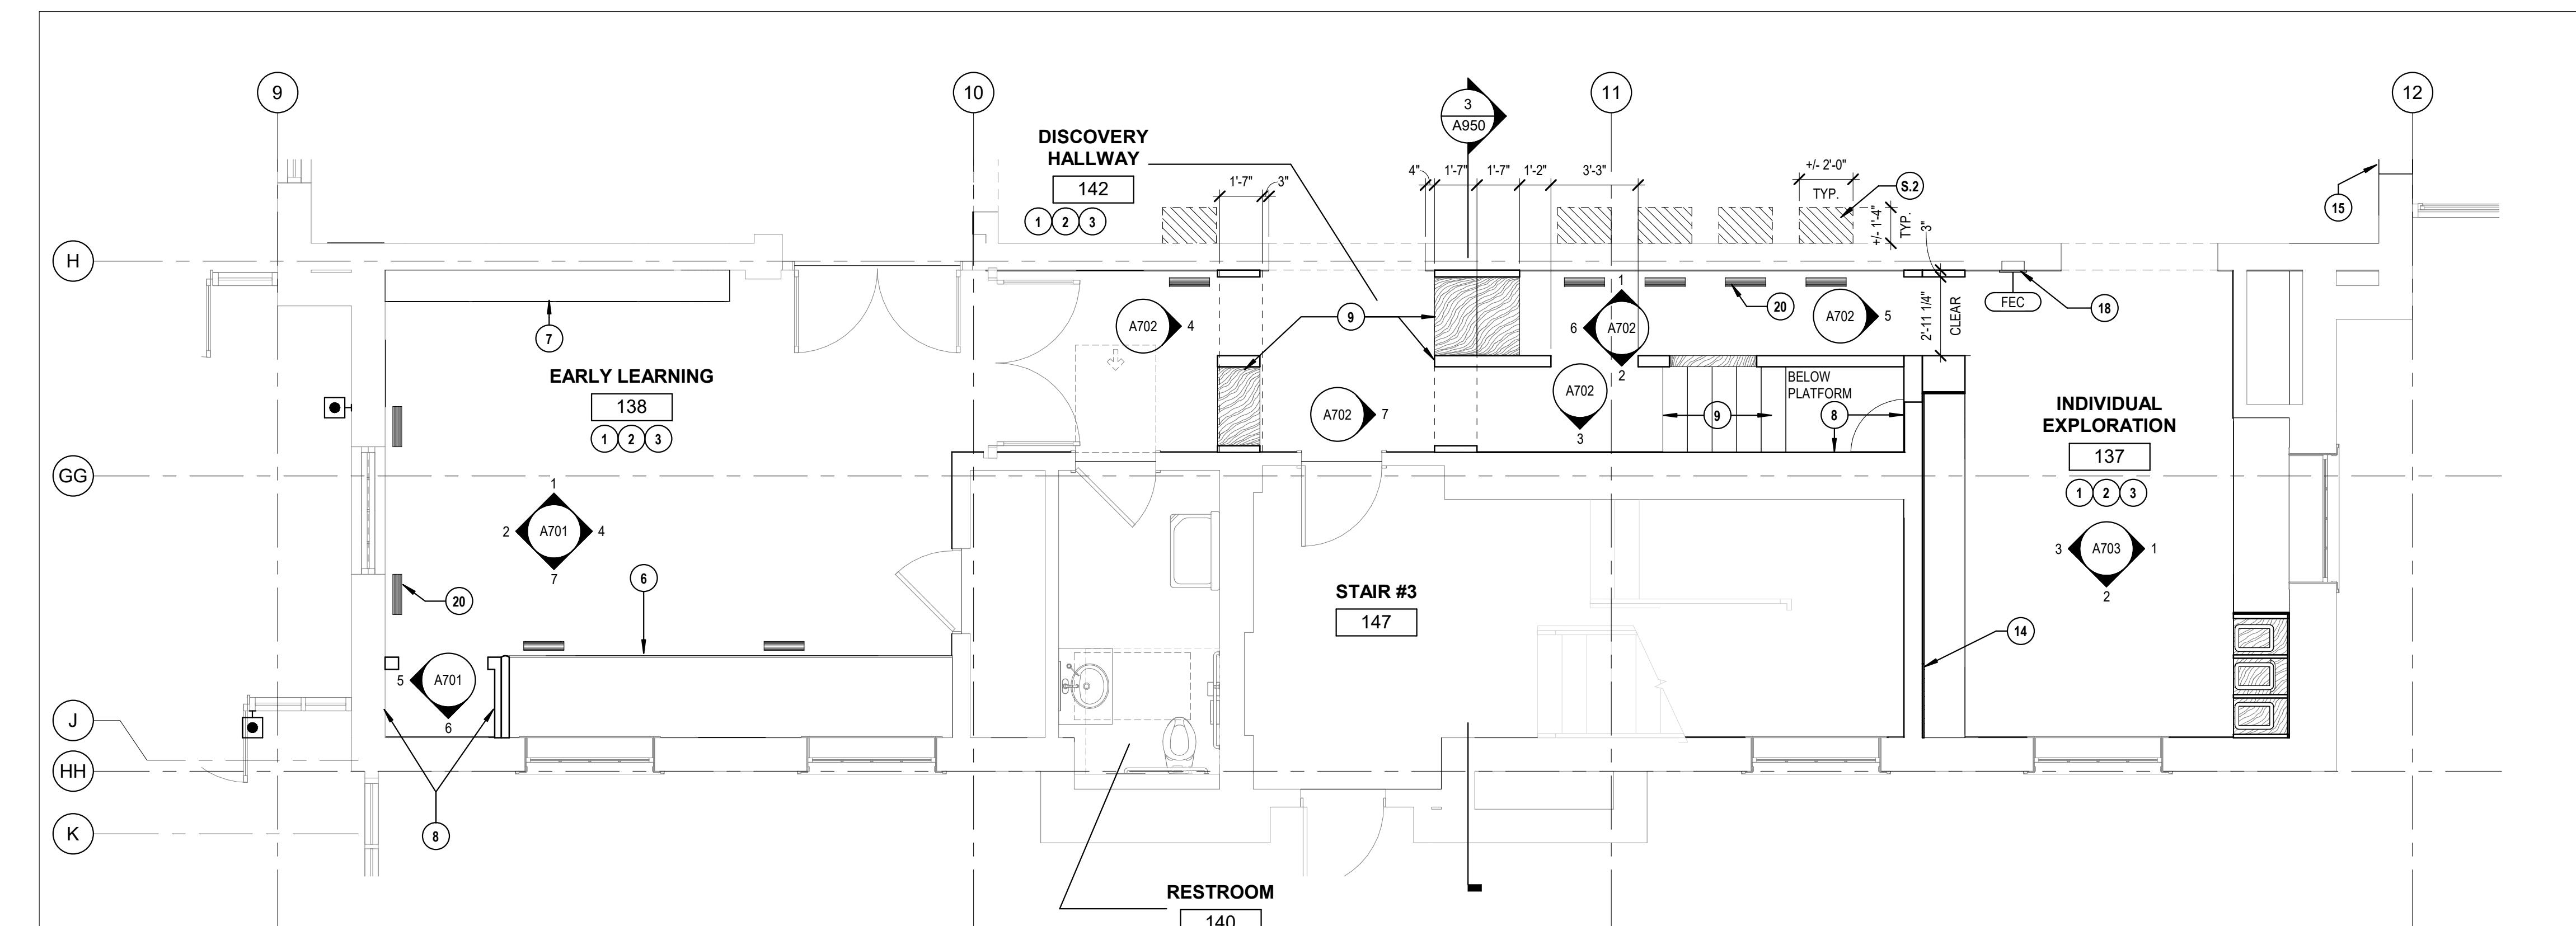
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LEVEL 1 -  
DEMOLITION RCPS

SHEET NO.


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1 LEVEL 1 - FLOOR PLAN - LEARNING HIVE

SCALE: 1/4" = 1'-0"

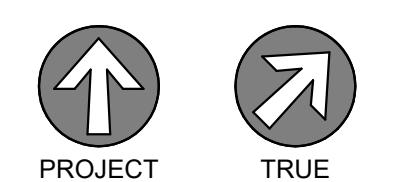

3 LEVEL 1 - FLOOR PLAN - KID LIBRARIAN

SCALE: 1/4" = 1'-0"

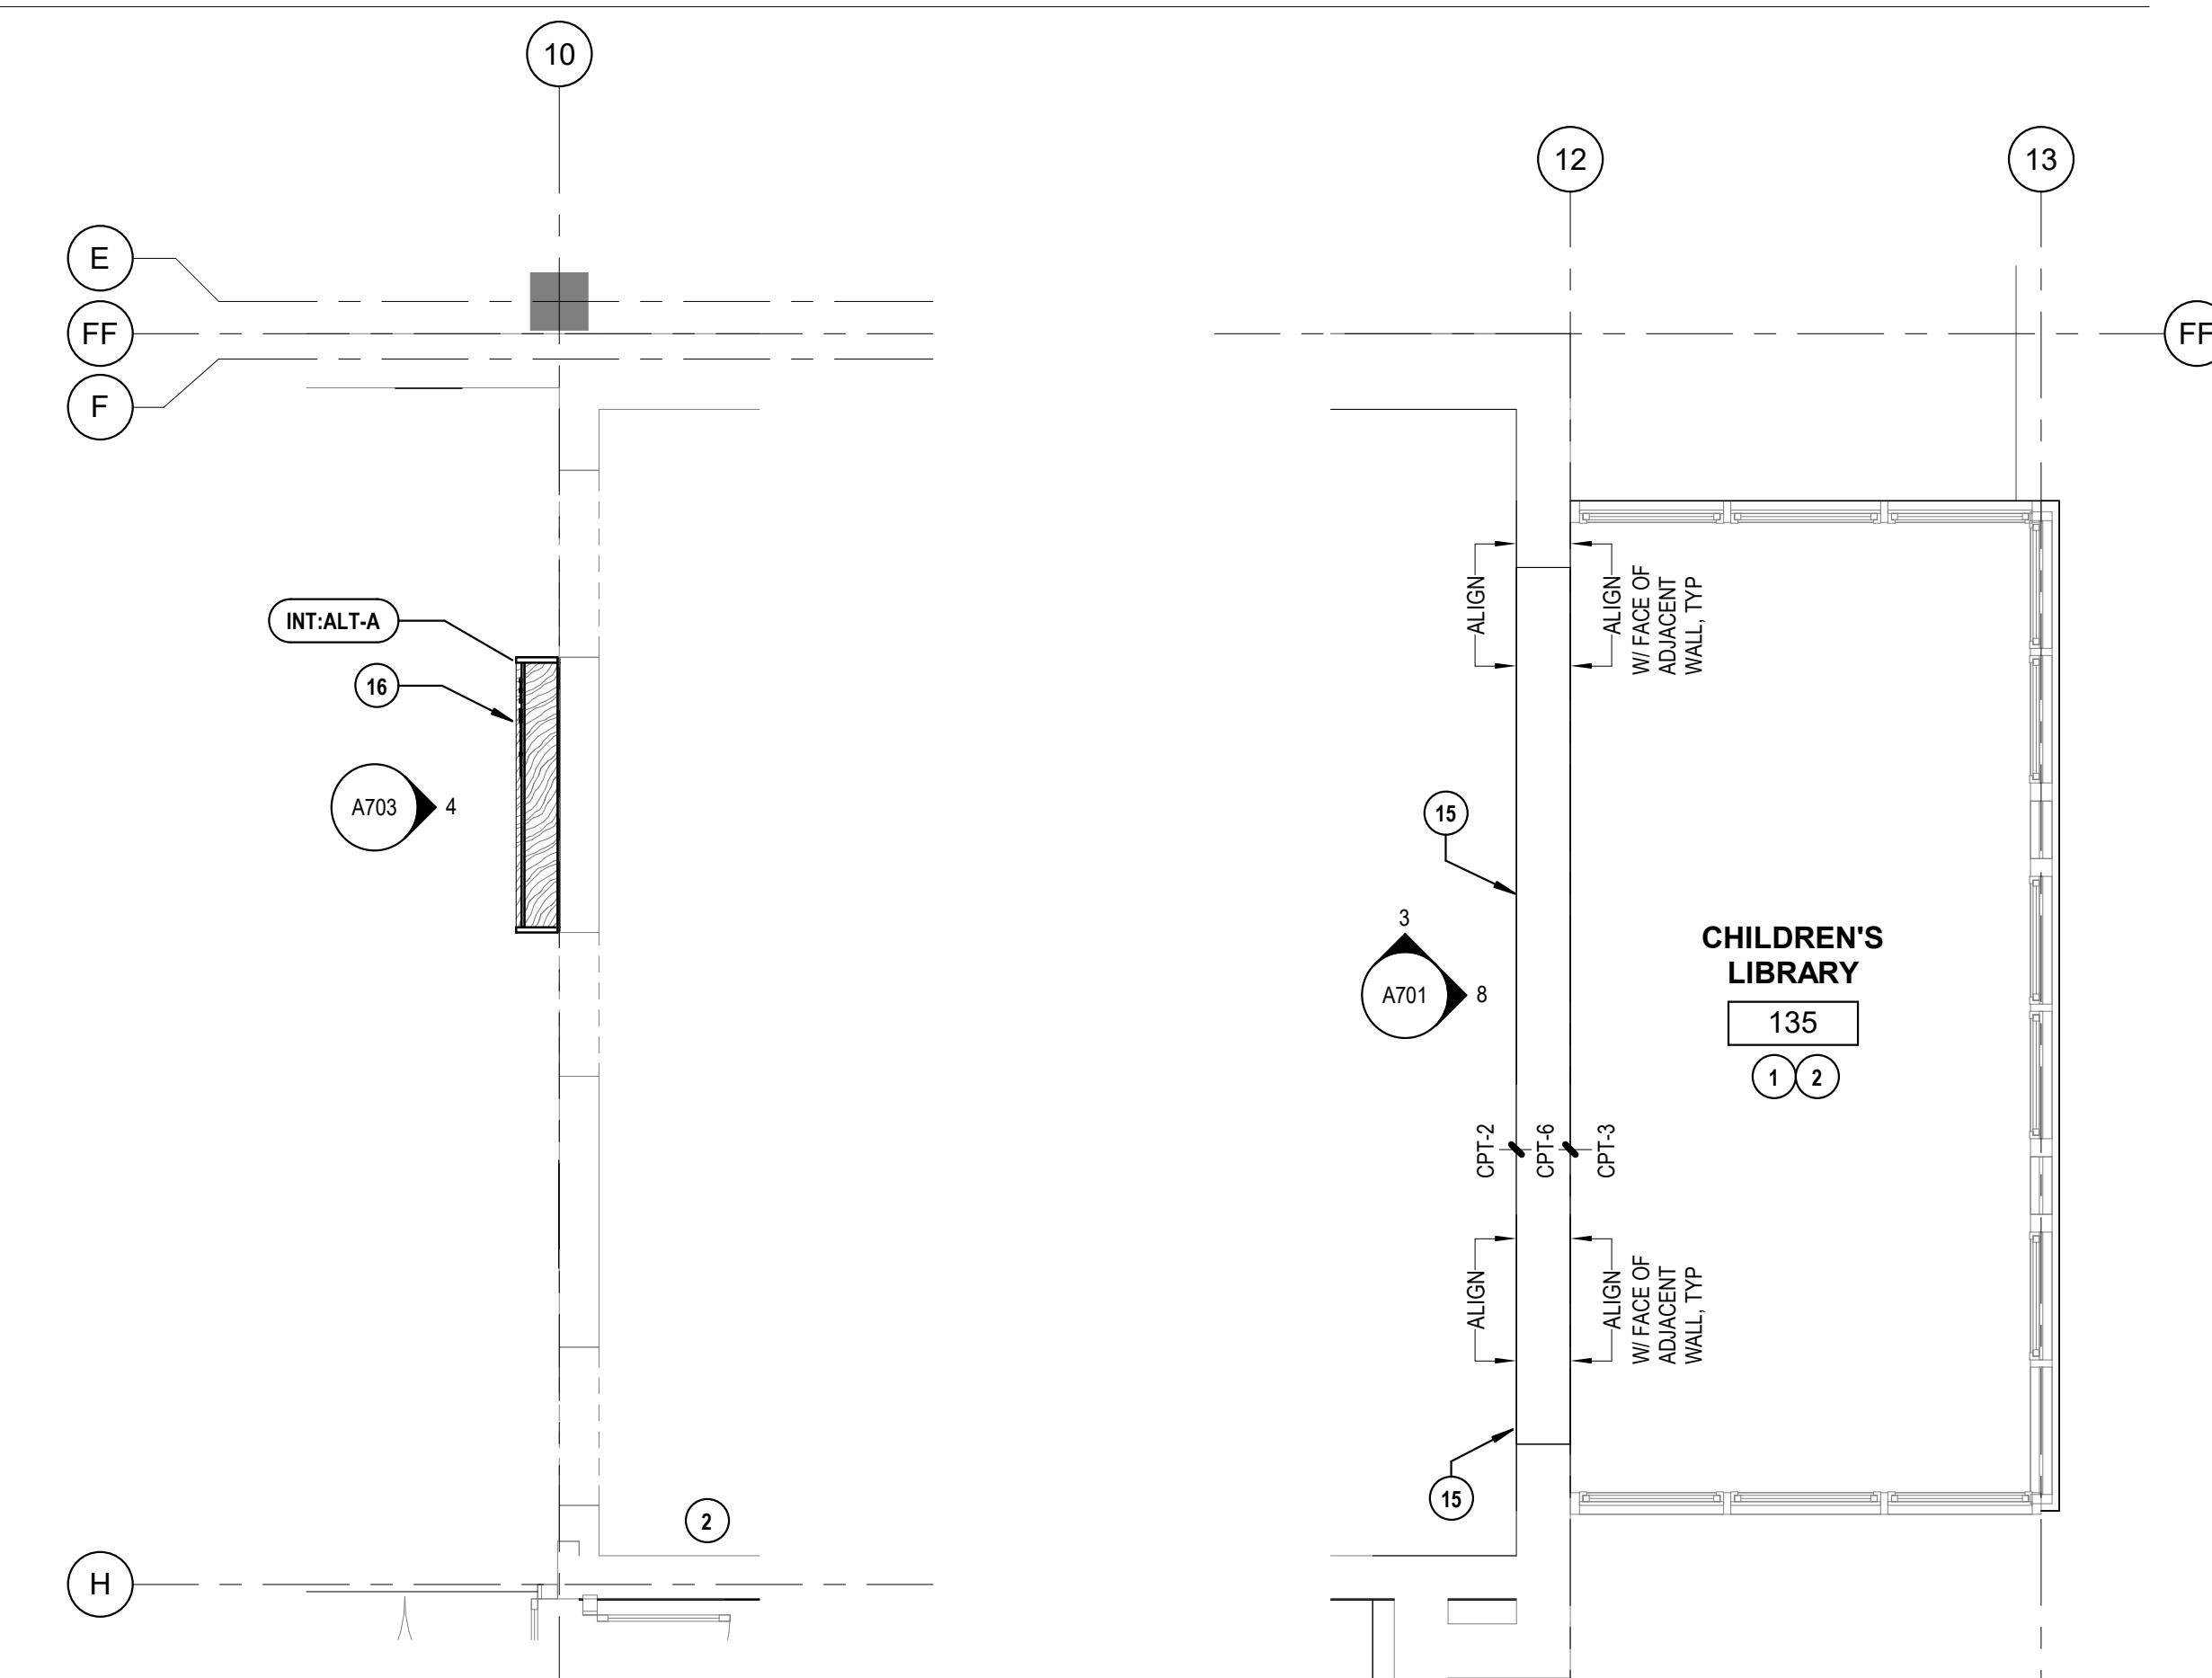2 LEVEL 1 - FLOOR PLAN - COZY READING

SCALE: 1/4" = 1'-0"

#### PLAN GENERAL NOTES

- REFER TO SHEET G001 FOR NOTES APPLICABLE TO ALL PORTIONS OF THE WORK.
- REFER TO G300 SERIES FOR TYPICAL ACCESSIBILITY CLEARANCES AND REQUIREMENTS.
- REFER TO A001 FOR WALL ASSEMBLIES, PATCH AND REPAIR ALL EXISTING WALLS AND NEW WALL INTERSECTIONS TO UNIFORM, LIKE-NEW APPEARANCE; PREPARE TO RECEIVE NEW PAINT AS SCHEDULED.
- MAINTAIN ACOUSTIC AND/OR FIRE RATINGS AROUND RECESSED FIXTURES, PIPING, DUCTWORK, PENETRATIONS AND ALL OBSTRUCTIONS.
- FLOOR TRANSITIONS TO OCCUR CENTERED UNDER DOOR PANEL WHERE NO DOOR OCCURS; ALIGN FINISH TRANSITION WITH FINISHED FACE OF WALL BASE. FINISH TRANSITIONS MARKED WITH ALIGN SHALL ALIGN WITH FACE OF ADJACENT WALL BASE, WHERE OCCURS, UNLESS NOTED OTHERWISE.
- GBW LEVEL OF FINISH SCHEDULE FOR WALLS AND CEILINGS IN THE FOLLOWING LOCATIONS:
  - LEVEL 4 (SMOOTH WALL): ALL AREAS NOT OTHERWISE NOTED.
  - LEVEL 5 (SMOOTH WALL): BEHIND ANY WALLCOVERING LOCATIONS; REFER TO ROOM FINISH SCHEDULE.
- NEW POWER, DATA, AND PLUMBING CONNECTIONS TO BE COORDINATED WITH MEP.

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INT:ALT-A FABRICATION AND INSTALLATION OF KID LIBRARIAN CASEWORK FEATURE  
- CHILDREN'S LIBRARY 143

PROJECT  
TRUE

0' 4' 8'

SHEET TITLE



#### LEVEL 1 - ENLARGED PLANS

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A221

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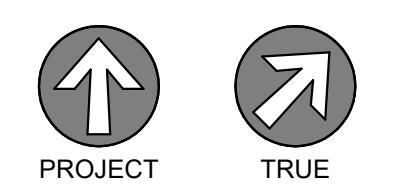
**CEILING TYPE LEGEND****RCP GENERAL NOTES**

- MECHANICAL, ELECTRICAL AND FIRE SAFETY TO BE DESIGN-BUILD. FIXTURE SWITCHING PLAN TO BE REVIEWED BY ARCHITECT PRIOR TO INSTALLATION.
- CEILING HEIGHTS ARE MEASURED VERTICALLY FROM THE FINISHED FACE OF CEILING OR SOFFIT TO FLOOR.
- ADJUST METAL FRAMING SIZE, GAUGE, AND SPACING AT SOFFITS AND CEILINGS TO MEET MANUFACTURER'S PUBLISHED SPAN TABLES AND AS REQUIRED TO SUPPORT GRAVITY AND LATERAL LOADS.
- ALL LIGHT FIXTURES TO BE DIMMABLE WITH OCCUPANCY SENSOR, U.N.O.
- SEE SHEET A910 FOR TYPICAL ACT DETAILS.
- UNLESS OTHERWISE NOTED, ALL ACT GRID IS TO BE CENTERED IN ROOM.
- ALL LIGHT FIXTURES ARE TO BE 3000K COLOR TEMPERATURE, U.N.O.
- COORDINATE MEP SITE WALK WITH ARCHITECT AND OWNER PRIOR TO COVER.

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LEVEL 1 -  
REFLECTED  
CEILING PLAN

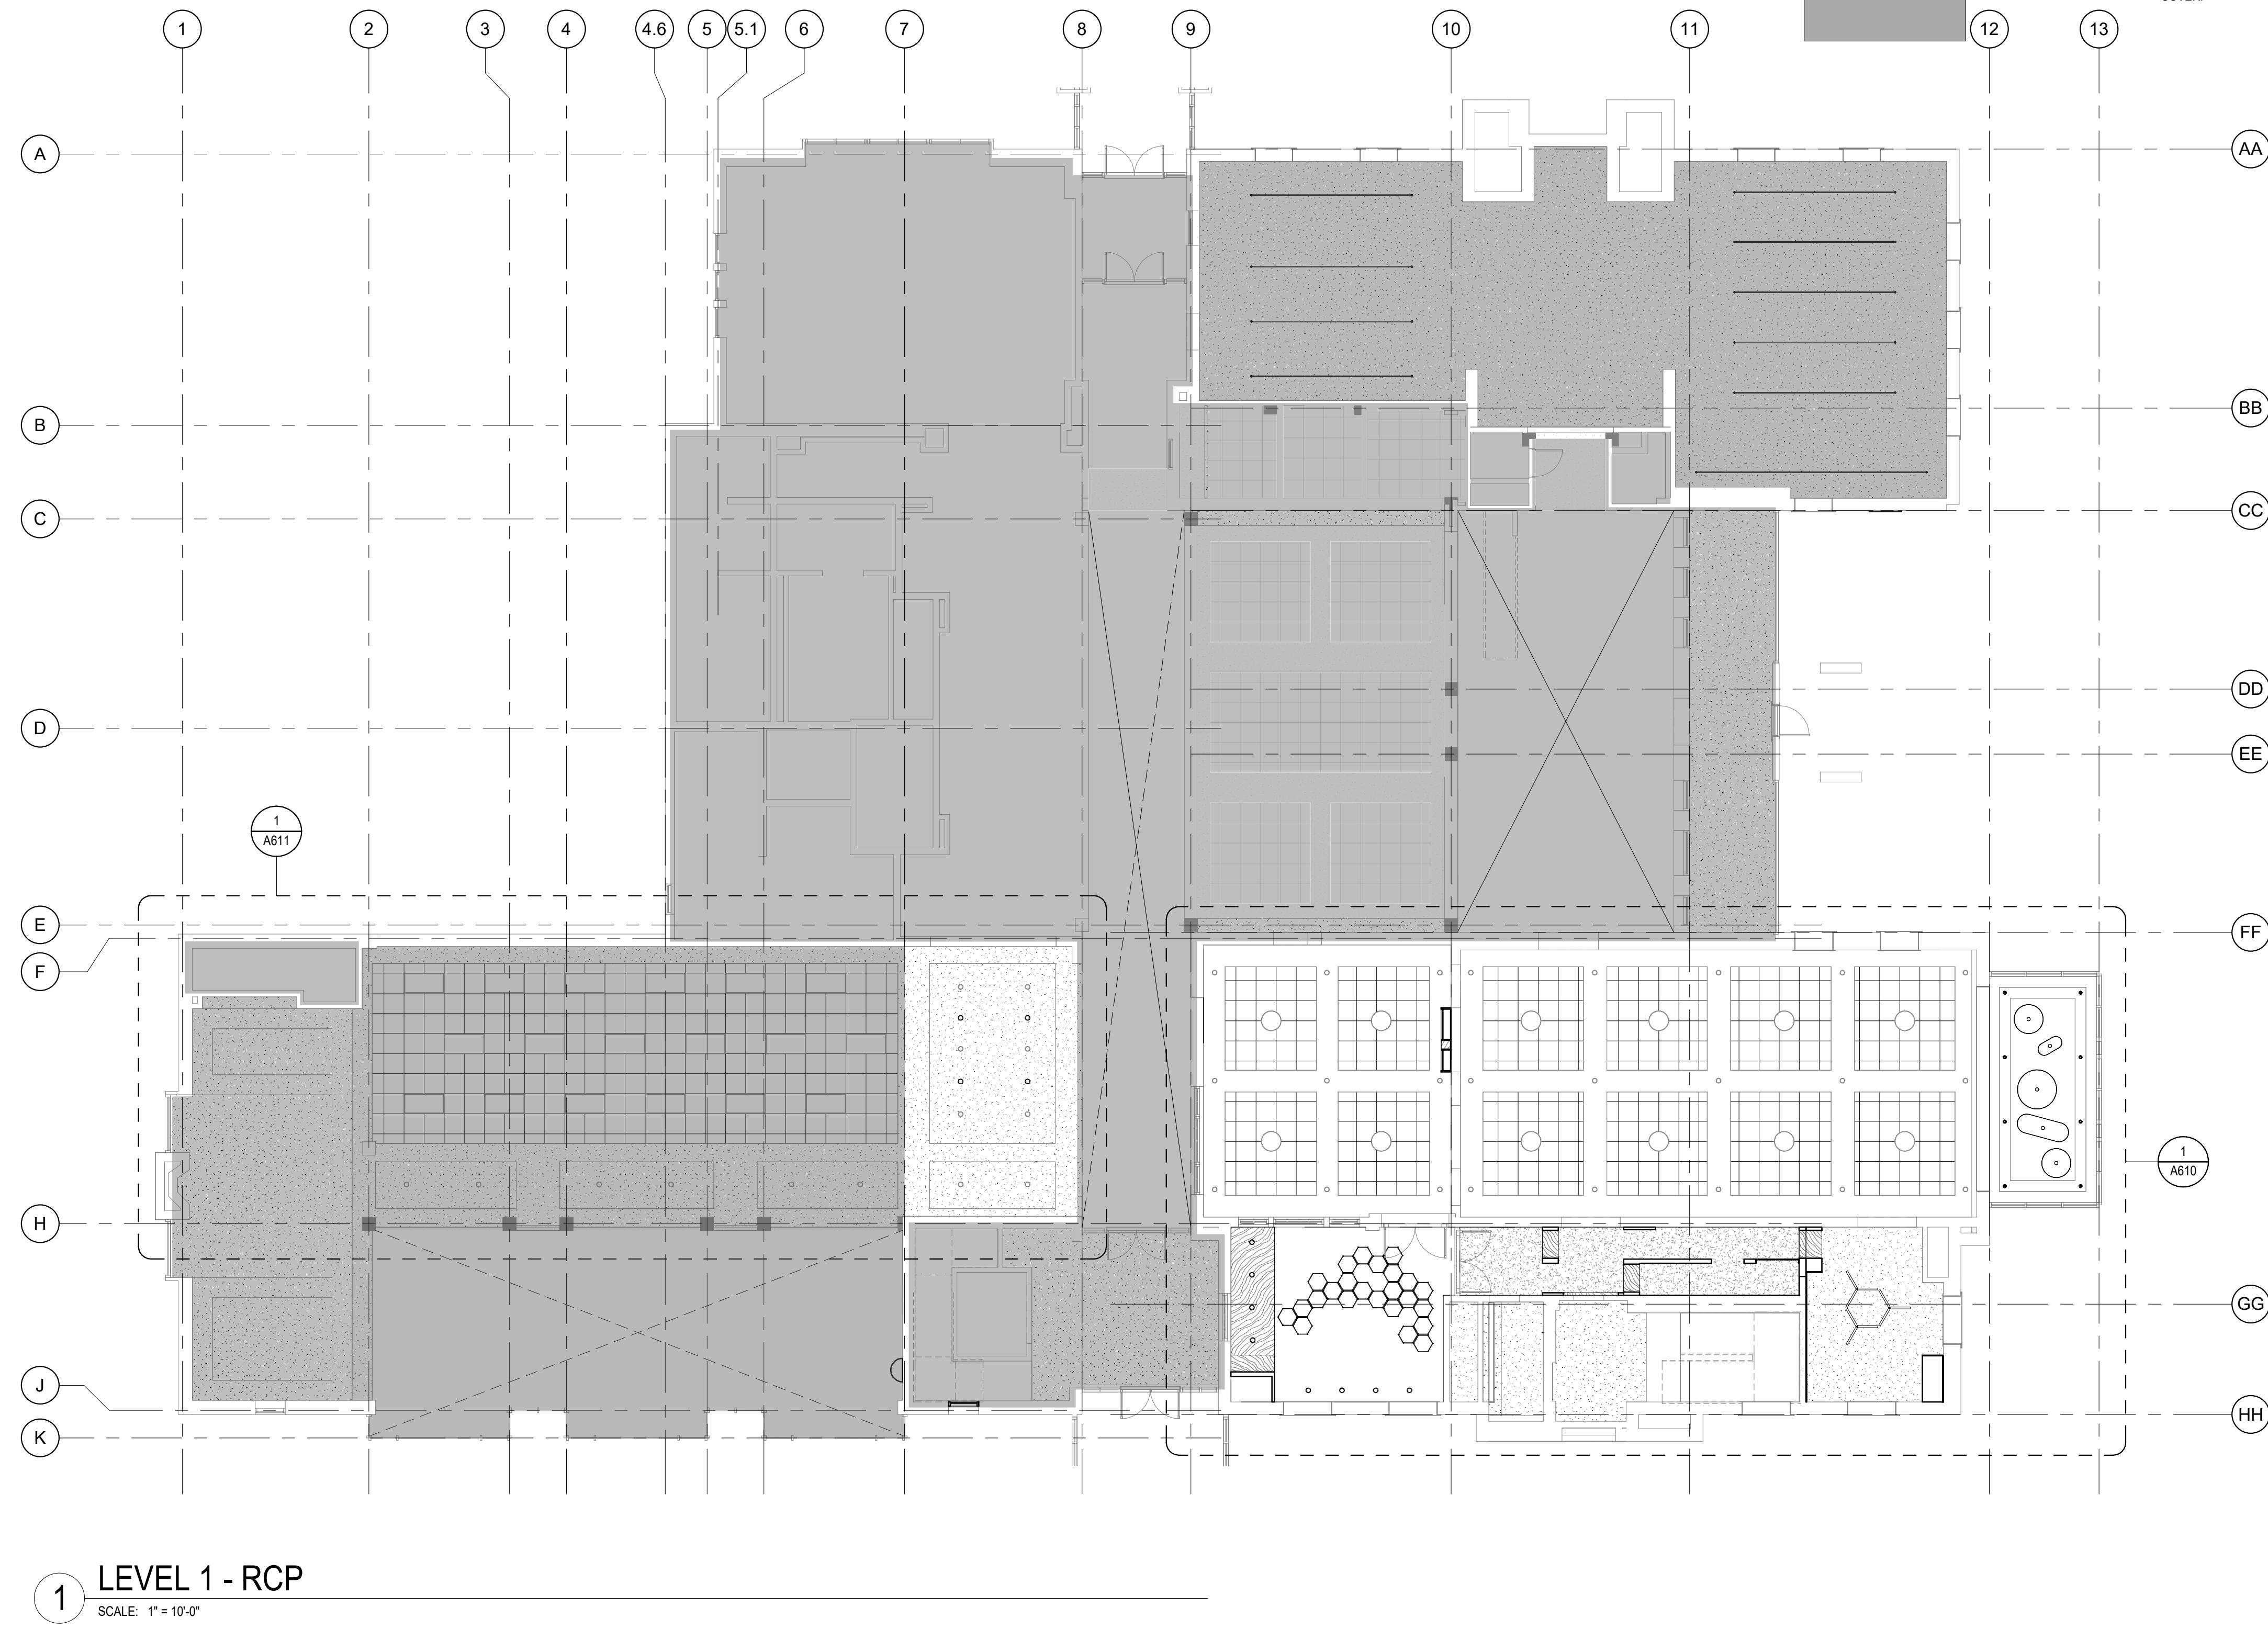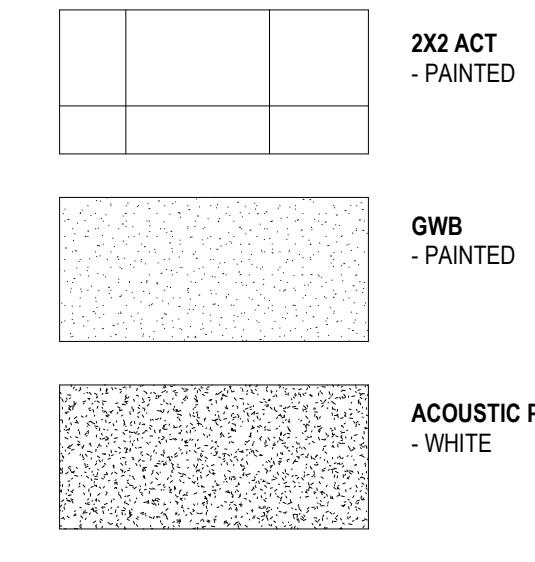SHEET NO.

**A600**


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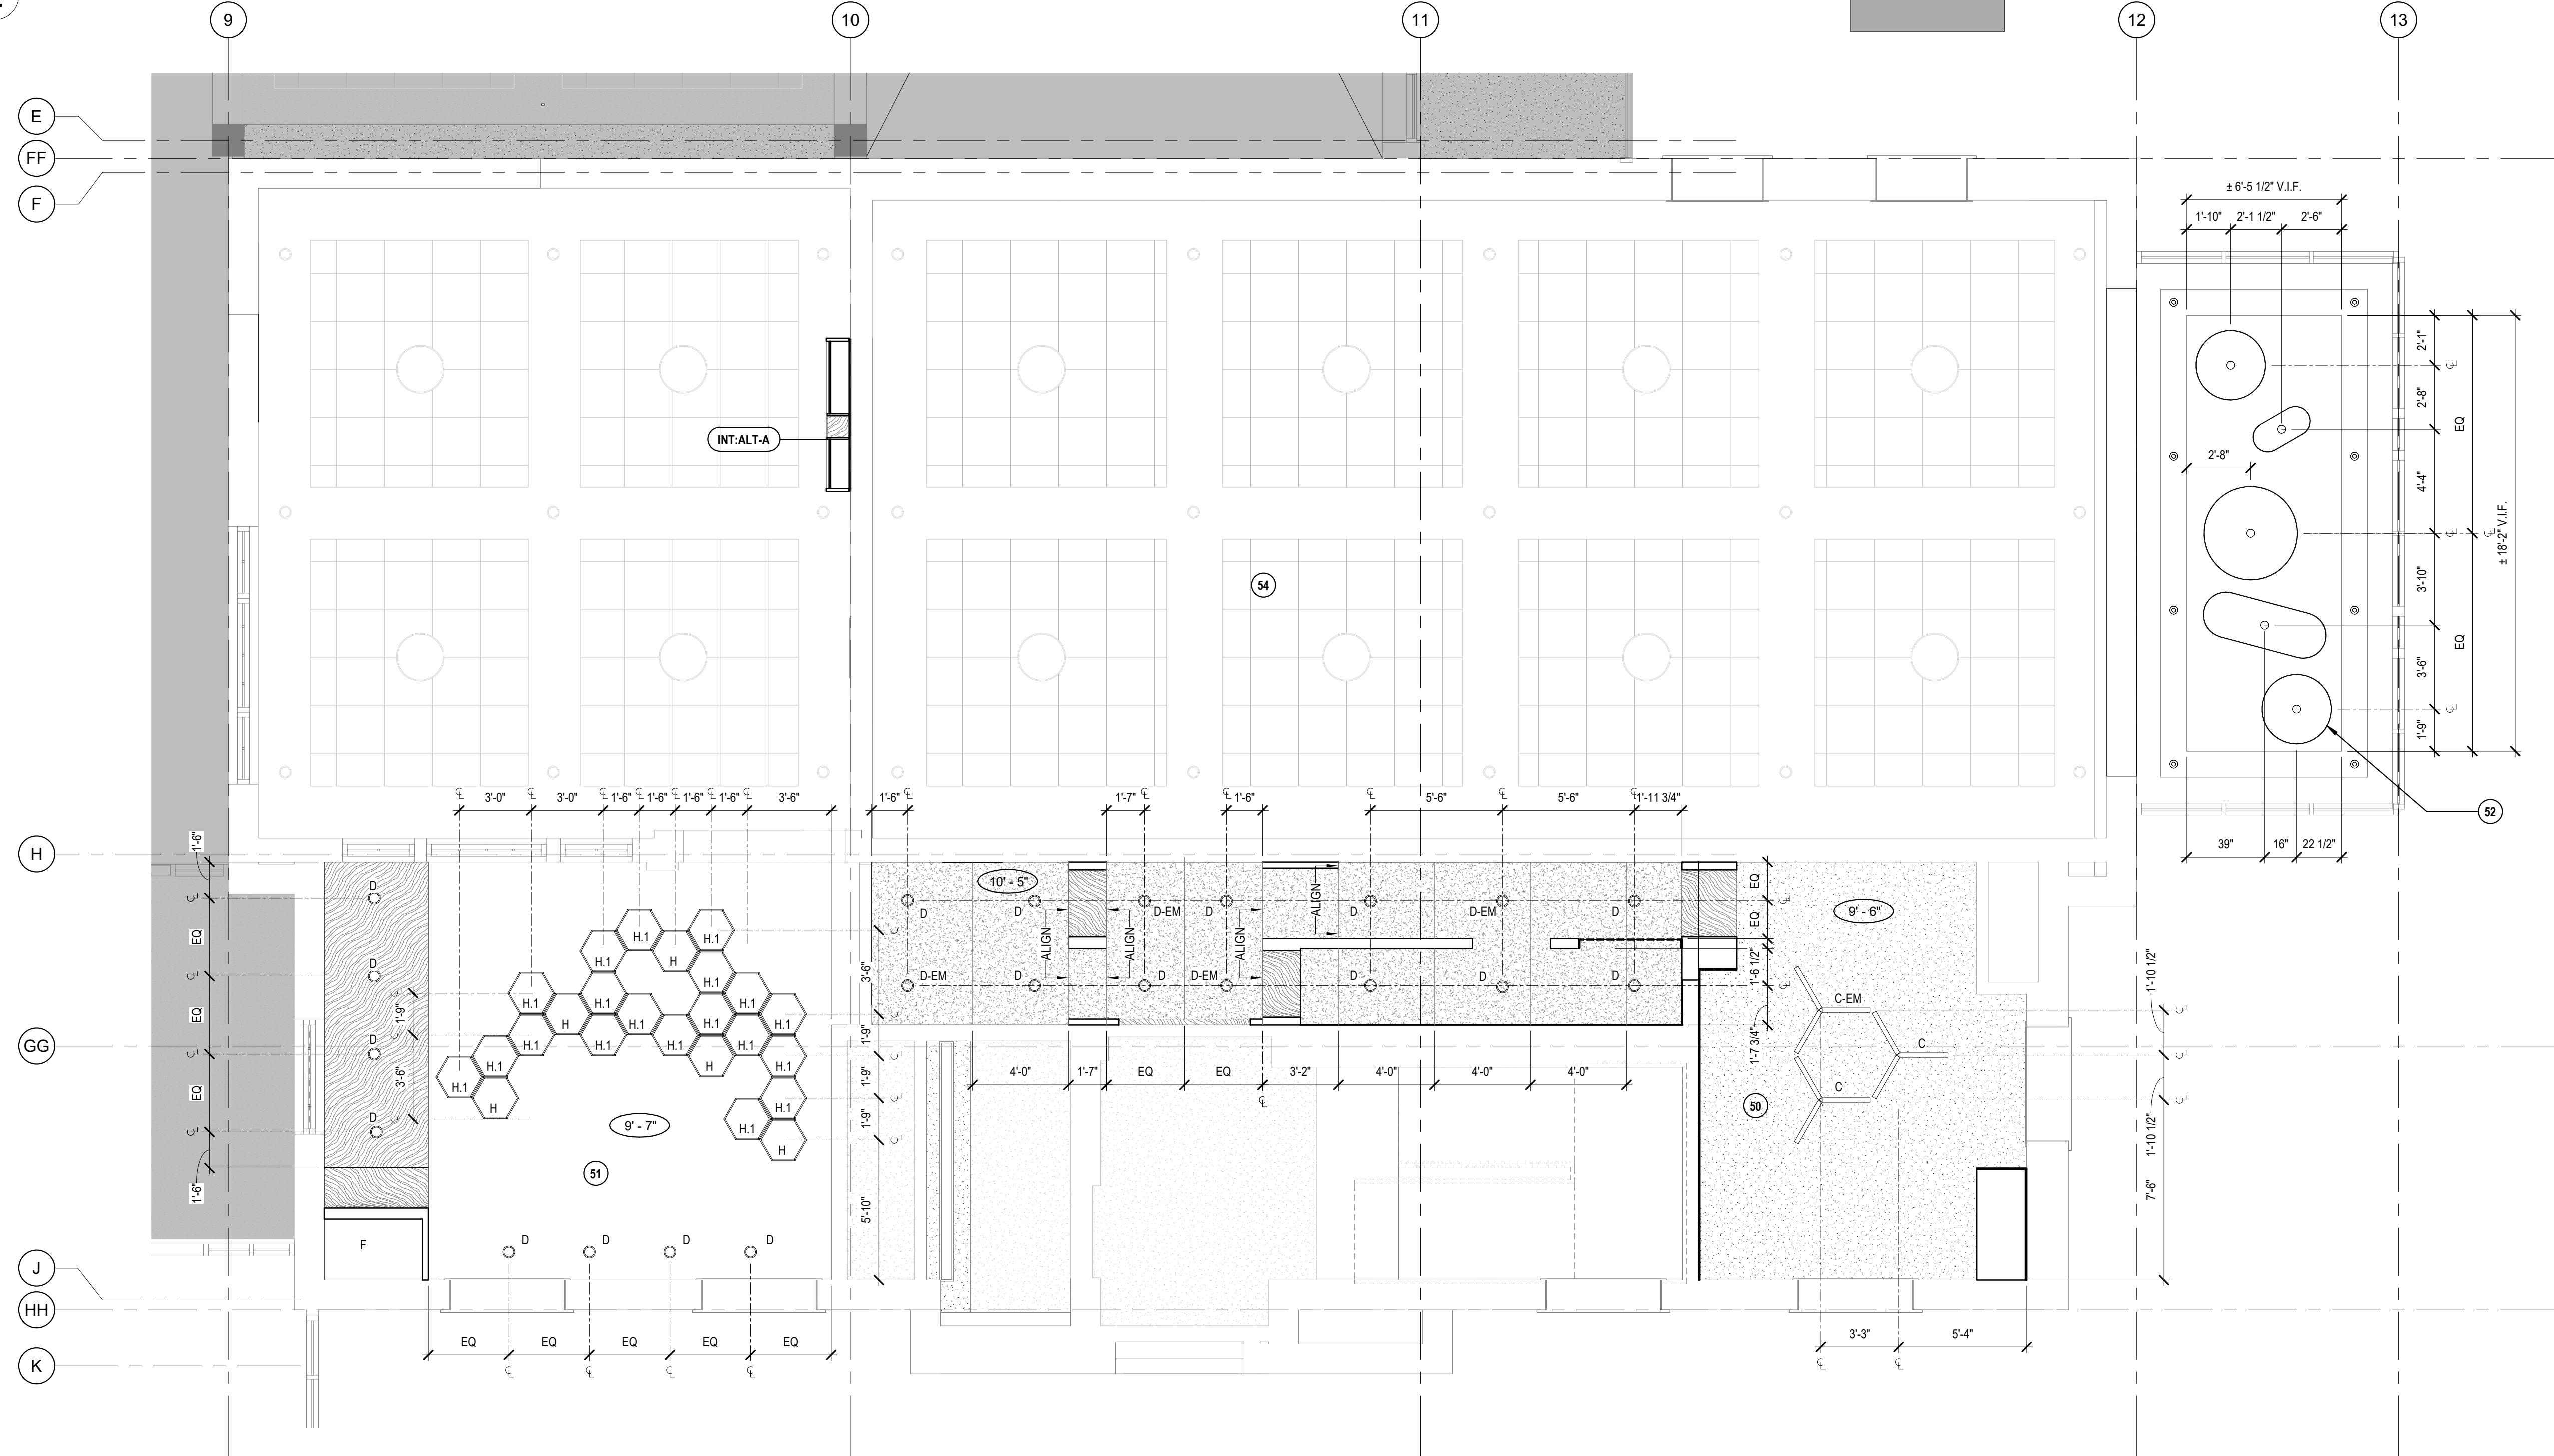
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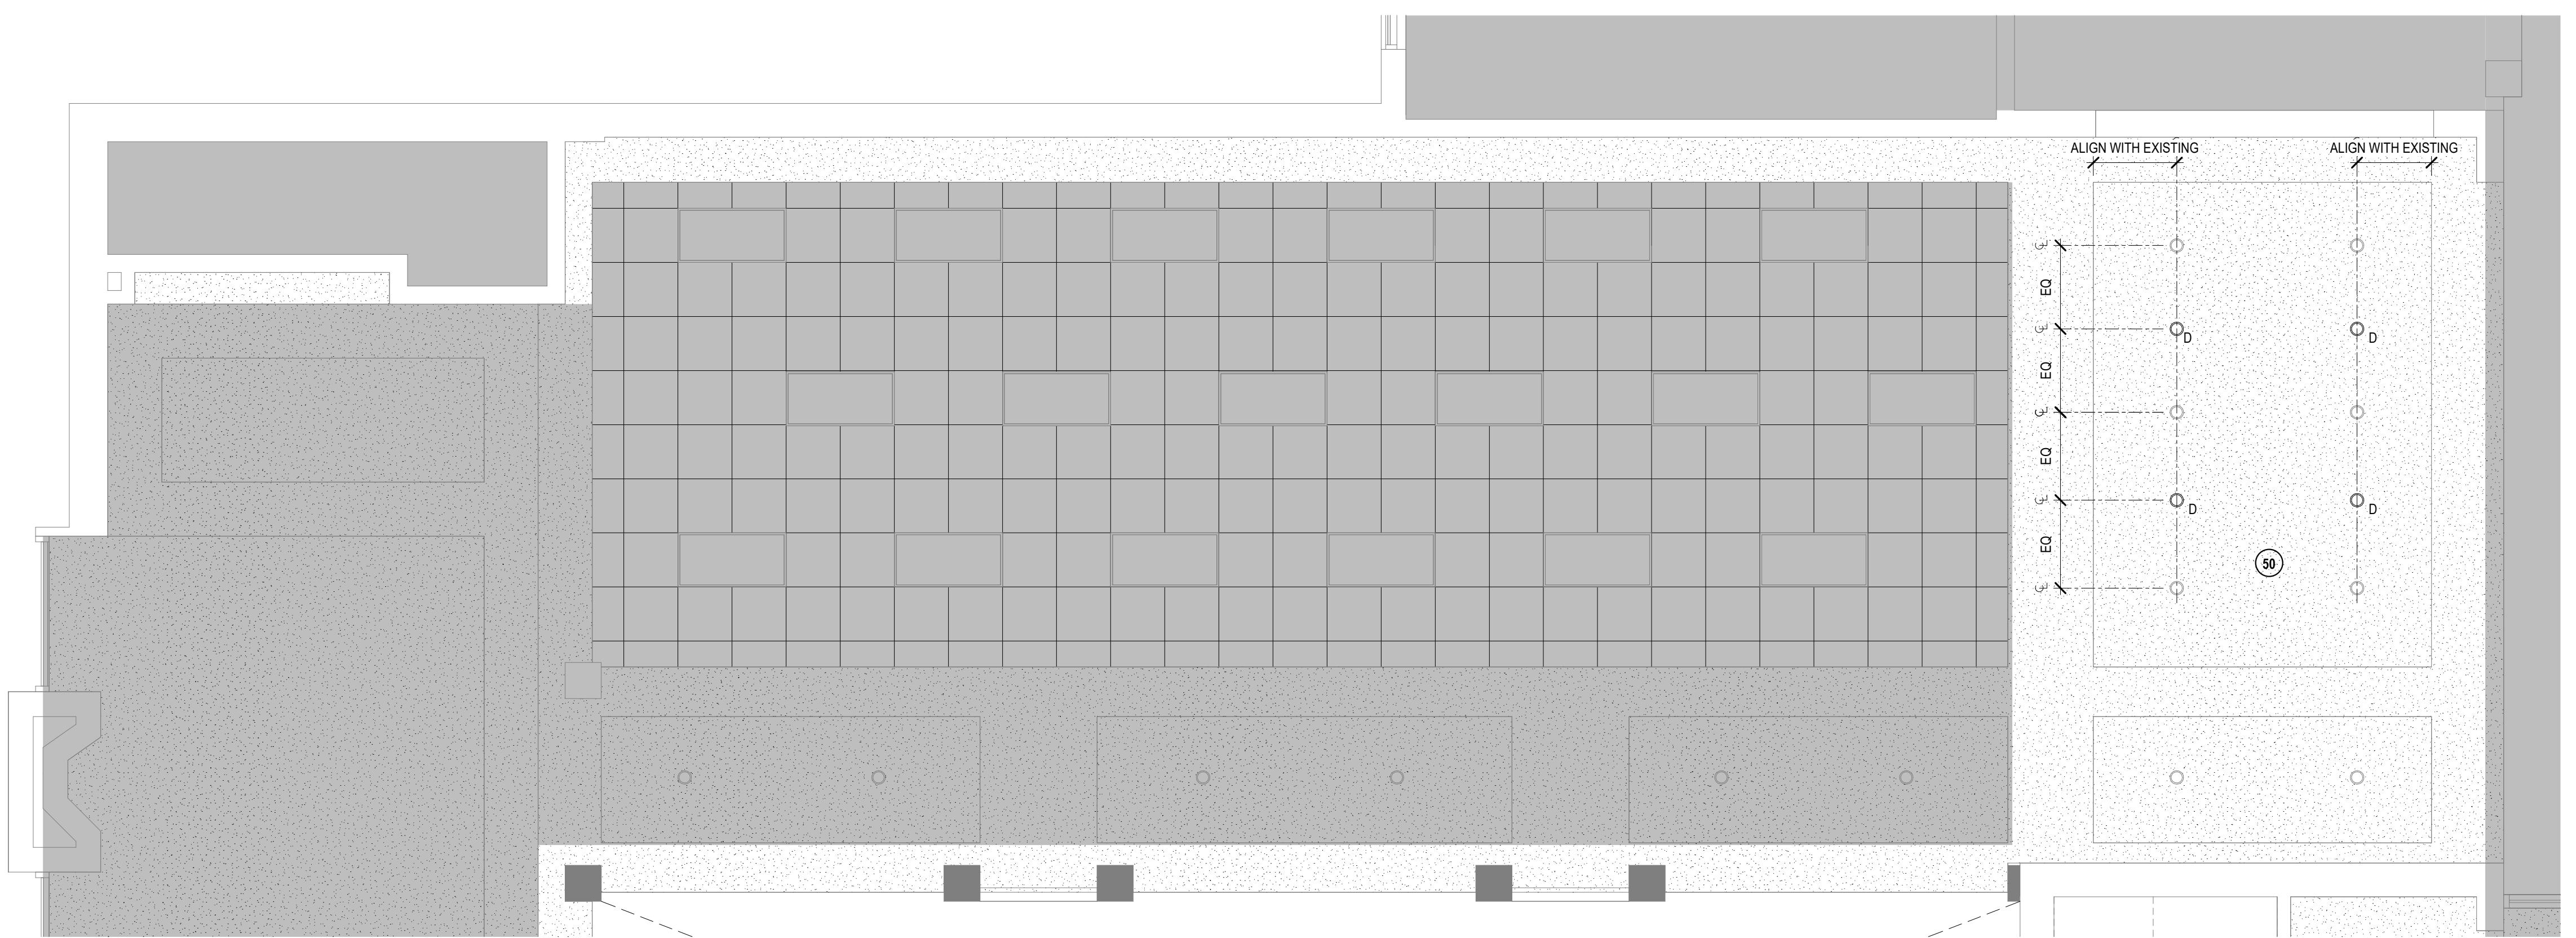


## LEVEL 1 - RCP - CHILDREN'S LIBRARY - FIXTURE 'F'







1 LEVEL 1 - RCP - FICTION

SCALE: 1/4" = 1'-0"

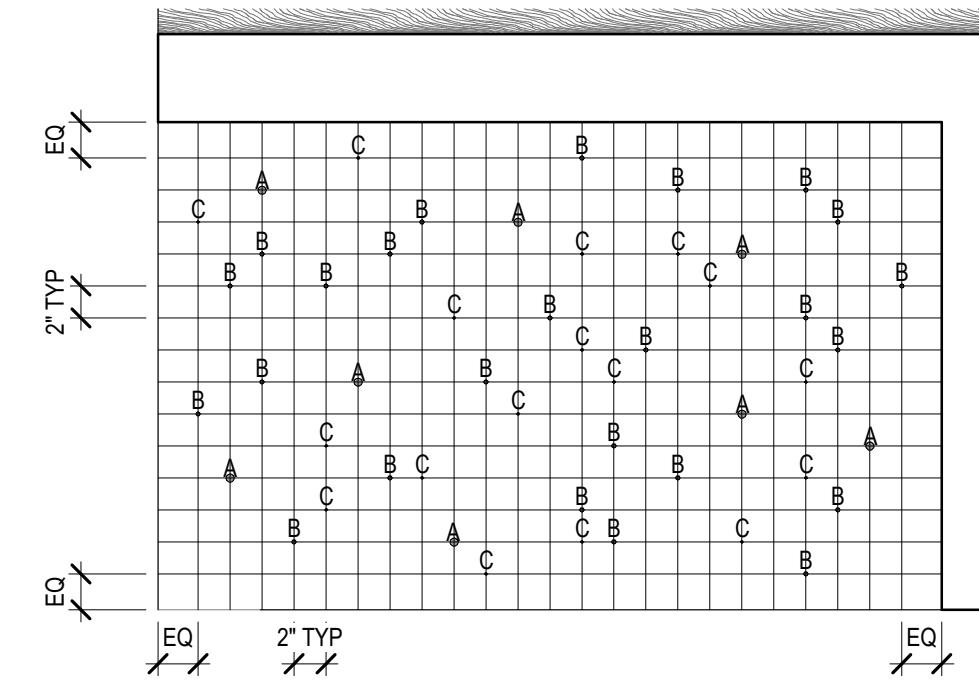

## CEILING TYPE LEGEND

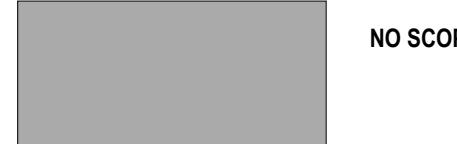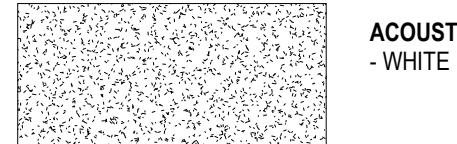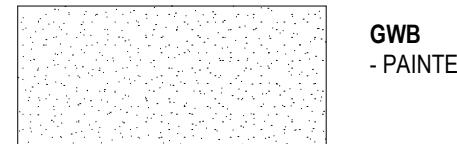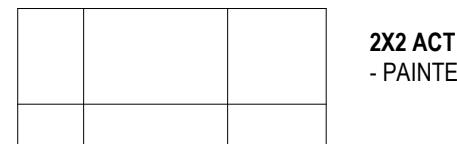

## RCP GENERAL NOTES

- MECHANICAL, ELECTRICAL AND FIRE SAFETY TO BE DESIGN-BUILD. FIXTURE SWITCHING PLAN TO BE REVIEWED BY ARCHITECT PRIOR TO INSTALLATION.
- CEILING HEIGHTS ARE MEASURED VERTICALLY FROM THE FINISHED FACE OF CEILING OR SOFFIT TO FLOOR.
- ADJUST METAL FRAMING SIZE, GAUGE, AND SPACING AT SOFFITS AND CEILINGS TO MEET MANUFACTURER'S PUBLISHED SPAN TABLES AND AS REQUIRED TO SUPPORT GRAVITY AND LATERAL LOADS.
- ALL LIGHT FIXTURES TO BE DIMMABLE WITH OCCUPANCY SENSOR, U.N.O.
- SEE SHEET A910 FOR TYPICAL ACT DETAILS.
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- COORDINATE MEP SITE WALK WITH ARCHITECT AND OWNER PRIOR TO COVER.


## KEYNOTES

50 PROVIDE AND INSTALL NEW RECESSED CAN LIGHTS; PATCH AND REPAIR GWB CEILING TO UNIFORM, LIKE-NEW, FINISH READY CONDITION; RELAMP EXISTING PER ELECTRICAL

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ENLARGED RCPs

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## MATERIALS &amp; FINISHES LEGEND

SPEC. SECTIONS NOTED BELOW FOR REFERENCE
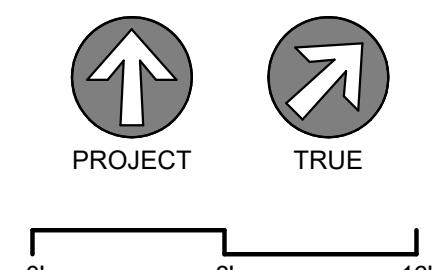
## SECTION 06 41 00 - ARCHITECTURAL WOOD CASEWORK

WOOD CONTROL SAMPLES  
WD-1 DESCRIPTION: VENEERED PLYWOOD  
VENEER SPECIES: BALTIC BIRCH  
CUT: FLAT SAWN  
FINISH: BONA NATURAL SEAL,  
MATCH ARCHITECT CONTROL SAMPLE

WB-1 DESCRIPTION: WOOD WALL BASE  
STYLE: MATCH EXISTING  
FINISH: PAINT, MATCH EXISTING

FABRIC  
F-1 MANUFACTURER: ULTRAFABRICS  
PATTERN: BRISA DISTRESSED  
COLOR: 535-3869 MUSLIN  
CONTENT: 100% POLYURETHANE  
WIDTH: 54"  
REPEAT: 8" X 10.5"  
RAILROADED: NO  
FIRE RESISTANCE: CA TB 117-2013  
CONTACT: LARA BERGSTROM |  
LARA@BENNETTASSOCs.COM

F-2 MANUFACTURER: DESIGNTEX  
PATTERN: MONTREAL CRYPTON  
COLOR: 3102-105  
CONTENT: 100% POLYESTER  
WIDTH: 54"  
REPEAT: NONE  
RAILROADED: NO  
FIRE RESISTANCE: CA TB 117-2013  
CONTACT: LINDSAY WILLINGHAM |  
LWILLINGHAM@DESIGNTEX.COM

F-3 MANUFACTURER: DESIGNTEX  
PATTERN: SALT LAKE CRYPTON  
COLOR: 3110-201 STRAW  
CONTENT: 100% POLYESTER  
WIDTH: 54"  
REPEAT: NONE  
RAILROADED: NO  
FIRE RESISTANCE: CA TB 117-2013  
CONTACT: LINDSAY WILLINGHAM |  
LWILLINGHAM@DESIGNTEX.COM

F-4 MANUFACTURER: DESIGNTEX  
PATTERN: MONTREAL CRYPTON  
COLOR: 3102-201 MARIGOLD  
CONTENT: 100% POLYESTER  
WIDTH: 54"  
REPEAT: NONE  
RAILROADED: NO  
FIRE RESISTANCE: CA TB 117-2013  
CONTACT: LINDSAY WILLINGHAM |  
LWILLINGHAM@DESIGNTEX.COM

F-5 MANUFACTURER: DESIGNTEX  
PATTERN: NAGANO CRYPTON  
COLOR: 3114-201 CANARY  
CONTENT: 100% POLYESTER  
WIDTH: 54"  
REPEAT: NONE  
RAILROADED: NO  
FIRE RESISTANCE: CA TB 117-2013  
CONTACT: LINDSAY WILLINGHAM |  
LWILLINGHAM@DESIGNTEX.COM

F-6 MANUFACTURER: WOLF-GORDON  
PATTERN: BARRINGTON GOH 33089341  
COLOR: CANARY  
CONTENT: 100% POLYESTER  
WIDTH: 54"  
REPEAT: NONE  
RAILROADED: NO  
FIRE RESISTANCE: CAL TB 117-2013  
CONTACT: CASSIE KLIEN |  
CASSIE.KLIEN@WOLFGORDON.COM

## SECTION 09 51 00 - ACOUSTICAL CEILINGS

FELT PANELING  
PET-1 MANUFACTURER: FSRB  
PRODUCT: 1" CEILING PANEL  
COLOR: WHITE #100  
SIZE: 4'0" X 0'0" STANDARD  
INSTALLATION: ACOUSTIC ADHESIVE PER  
MANUFACTURER INSTALLATION

## SECTION 09 65 00 - RESILIENT FLOORING

RESILIENT BASE  
RB-1 MANUFACTURER: ROPPE  
TYPE: CONTOURS PROFILED RUBBER BASE  
STYLE: 1/4" CANDID  
PROFILE: SQUARE  
SIZE: 4'  
COLOR: P161 SNOW

## SECTION 09 68 43 - TILE CARPETING

CPT-1 MANUFACTURER: SHAW CONTRACT  
STYLE: SPOKEN TILE 57406  
COLOR: SCRIPT 05210  
SIZE: 9" X 36"  
DYE METHOD: 100% SOLUTION DYED  
PRIMARY BACKING: SYNTHETIC  
PILE HEIGHT: 0.315"  
INSTALLATION: BRICK  
CONTACT: BRODEN STAPLES |  
BRODEN.STAPLES@SHAWCONTRACT.COM

CPT-2 MANUFACTURER: SHAW CONTRACT  
STYLE: TRANSLATE TILE 57408  
COLOR: SCRIPT 05210  
SIZE: 9" X 36"  
DYE METHOD: 100% SOLUTION DYED  
PRIMARY BACKING: SYNTHETIC  
PILE HEIGHT: 0.266"  
INSTALLATION: BRICK  
CONTACT: BRODEN STAPLES |  
BRODEN.STAPLES@SHAWCONTRACT.COM

CPT-3 MANUFACTURER: FLOR  
STYLE: STONE'S THROW  
COLOR: SEAFOAM  
SIZE: 50CM X 50CM  
DYE METHOD: 100% SOLUTION DYED  
PRIMARY BACKING: GLASBAC  
PILE HEIGHT: 0.16"  
INSTALLATION: MONOLITHIC  
NOTE: FEATHER AT TRANSITION FOR LEVEL SURFACE  
CONTACT: SHELLY STREIBICK |  
SHELLY.STREIBICK@INTERFACE.COM

CPT-4 MANUFACTURER: SHAW CONTRACT  
STYLE: FORM TILE 57136  
COLOR: CONERSTONE COPPER 33555  
SIZE: 24" X 24"  
DYE METHOD: 100% SOLUTION DYED  
PRIMARY BACKING: SYNTHETIC  
INSTALLATION: ASHLAR  
CONTACT: BRODEN STAPLES |  
BRODEN.STAPLES@SHAWCONTRACT.COM

## CPT-5 NOT USED

CPT-6 MANUFACTURER: SHAW CONTRACT  
STYLE: TRU COLORS EW24- 59368  
COLOR: NORDIC - 68447  
SIZE: 24" X 24"  
DYE METHOD: 100% SOLUTION DYED  
PRIMARY BACKING: ECOWORX  
PILE HEIGHT: 0.93"  
INSTALLATION: MONOLITHIC  
CONTACT: BRODEN STAPLES |  
BRODEN.STAPLES@SHAWCONTRACT.COM

## SECTION 09 72 00 - WALL COVERINGS

WC-1 MANUFACTURER: SPOONFLOWER  
DESIGN NAME: CUTE FOREST ANIMALS WALLPAPER  
DESIGN NUMBER: #16422652  
SUBSTRATE: NON-PASTED TRADITIONAL PEBBLE  
CONTENT: TYPE II PVC-FREE  
FIRE RATING: CLASS A  
CONTACT: MARCY SULLIVAN |  
MARCY.SULLIVAN@SPOONFLOWER.COM

## WC-2 MANUFACTURER: SPOONFLOWER

DESIGN NAME: SHIBORI STARS ON DARK INDIGO  
(LARGE SCALE)  
DESIGN NUMBER: #12300607  
SUBSTRATE: NON-PASTED TRADITIONAL PEBBLE  
CONTENT: TYPE II PVC-FREE  
FIRE RATING: CLASS A  
CONTACT: MARCY SULLIVAN |  
MARCY.SULLIVAN@SPOONFLOWER.COM

## SECTION 09 77 00 - STRETCHED FABRIC

AWC-1 MANUFACTURER: SNAPTEX  
PROFILE: 3/4" SQUARE TOP LOAD  
SUBSTRATE: MICORE TACKABLE FIBERBOARD  
CONTACT: KEN HUBER | KEN@SNAPTEX.COM  
TEXTILE: F-6, SEE SECTION 06 41 00

## SECTION 09 91 23 - INTERIOR PAINTING

INTERIOR PAINT  
P-1 MANUFACTURER: BENJAMIN MOORE  
COLOR: OC-65 CHANTILLY LACE  
SHEEN: EGGSHELL  
P-1A MANUFACTURER: BENJAMIN MOORE  
COLOR: OC-65 CHANTILLY LACE  
SHEEN: SEMI-GLOSS  
P-2 MANUFACTURER: SHERWIN WILLIAMS  
COLOR: SW 6902 DECISIVE YELLOW  
SHEEN: EGGSHELL  
P-3 MANUFACTURER: SHERWIN WILLIAMS  
COLOR: SW 0048 BUNGLEHOUSE BLUE  
SHEEN: EGGSHELL

MAGNETIC DRY-ERASE PAINT  
P-1B MANUFACTURER: IDEAPAIN OR EQUAL  
PRIMER: MAGNETIC PRIMER  
COLOR LAYER: P-1  
TOPCOAT: IDEAPAIN CREATE CLEAR INTERIOR DRY  
ERASE PAINT

## SECTION 12 36 00 - COUNTERTOPS

SOLID SURFACE  
SS-1 MANUFACTURER: FORMICA  
PRODUCT: EVERFORM SOLID SURFACE  
PATTERN: 601 BLEACHED CONCRETE  
SIZE: 30" X 14" X 0.48" THICK

## ROOM FINISH SCHEDULE

RM.#	NAME	FLOOR	BASE	WALL FINISH			CASEWORK	COUNTERTOP	CEILING	NOTES
				NORTH	EAST	SOUTH				
LEVEL 1										
106	FICTION	-	-	-	-	-	-	-	MATCH EXISTING	1
121	NON-FICTION	CPT-4	WB-1	-	-	-	-	-	-	4
122	NON-FICTION	CPT-4	WB-1	-	-	-	-	-	-	4
123	NON-FICTION	CPT-4	WB-1	-	-	-	-	-	-	4
135	CHILDREN'S LIBRARY	CPT-2/CPT-3/CPT-6	RB-1	P-1	P-1/P-3	P-1	P-1	P-3/F-7	-	P-1 6.14
137	INDIVIDUAL EXPLORATION	CPT-1	RB-1	P-1	P-1/P-1B	P-1	P-2/AWC-1	WD-1/P-2	SS-1	P-1 7.8
138	EARLY LEARNING	CPT-1	RB-1	P-1	P-1	P-1	WD-1/F-1/F-2/F-3/F-4/F-5	WD-1/P-1	SS-1	P-1 9.10
142	DISCOVERY HALLWAY	CPT-1	RB-1	P-1	WD-1	P-1	P-1	WD-1/CPT-1	-	P-1 11.13
143	CHILDREN'S LIBRARY	CPT-2	RB-2	P-1	P-1	P-1	P-1	WD-1/P-2	-	P-1 12

## FINISH SCHEDULE COMMENTS:

1. NO FINISH UPDATES; SEE RCP FOR EXTENT OF SCOPE.
2. EXISTING WOOD WALL PANELING TO REMAIN AS-IS; PAINT SCOPE AT EXISTING PAINTED GBW WALLS ONLY.
3. P-1 CEILING PAINT TO TERMINATE AT INSIDE CORNER OF SOFFIT HEIGHT TRANSITION.
4. ABATE LEAD PAINT AT WOOD BASE.
5. P-1 CEILING PAINT AT EXISTING GBW SOFFITS ONLY. EXISTING ACOUSTIC CEILING TILE & GRID TO REMAIN AS-IS.
6. CPT-3 TRANSITION TO ALIGN WITH FACES OF ADJACENT WALLS AT TRANSITION TO COZY READING AREA; CPT-6 TO BE IN COZY READING AREA; SEE A221 FOR TRANSITION LOCATIONS.
7. P-1B MARKERBOARD PAINT EXTENTS PER ELEVATIONS. TERMINATE PAINT AT INSIDE CORNERS.
8. P-2 FINISH AT OVERSIZED PEGBOARD ONLY. SEE ELEVATION FOR EXTENTS.
9. F-2 UPHOLSTERY FABRIC AT BANQUETTE SEAT, EXTENTS AS ELEVATED.
10. NOT USED
11. NOT USED
12. P-2 PAINTED BACKS AT FEATURE CASEWORK; SEE ELEVATIONS AND DETAILS FOR EXTENTS OF FINISHES.

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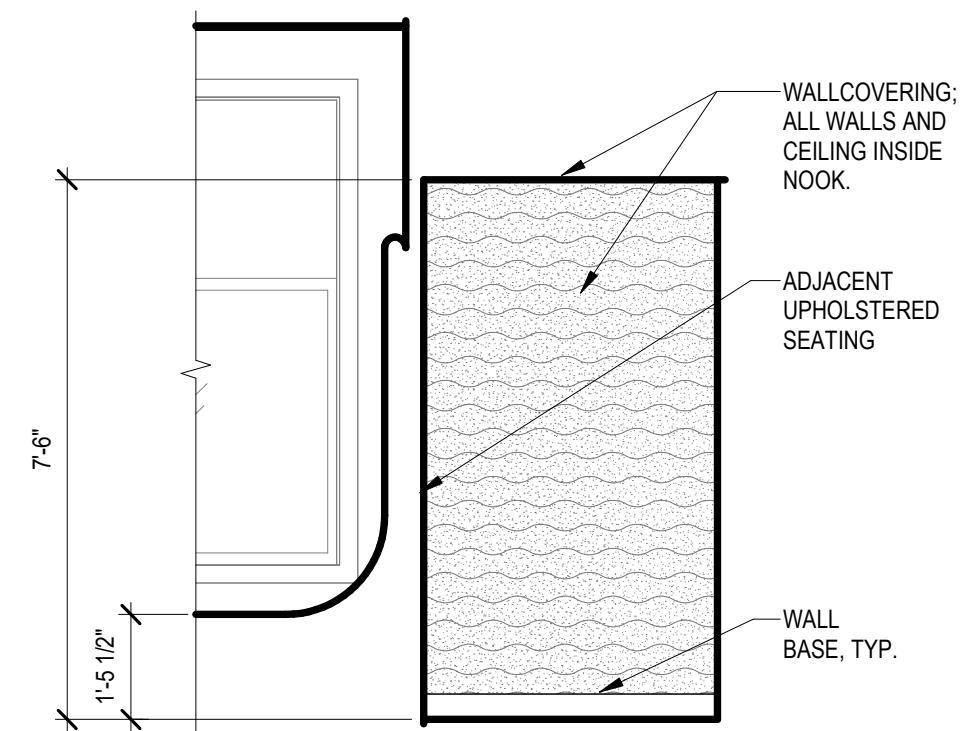
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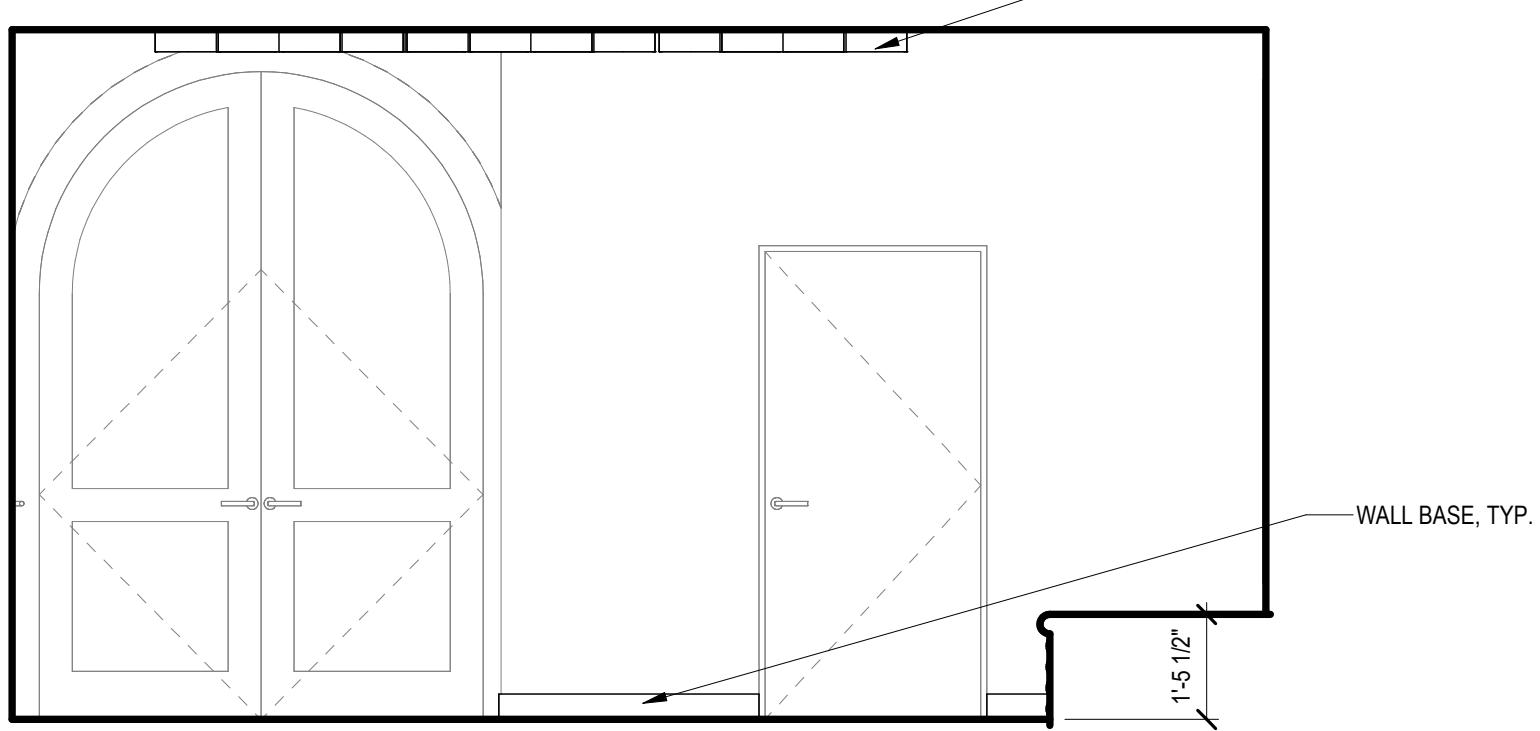
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SHEET NO.  
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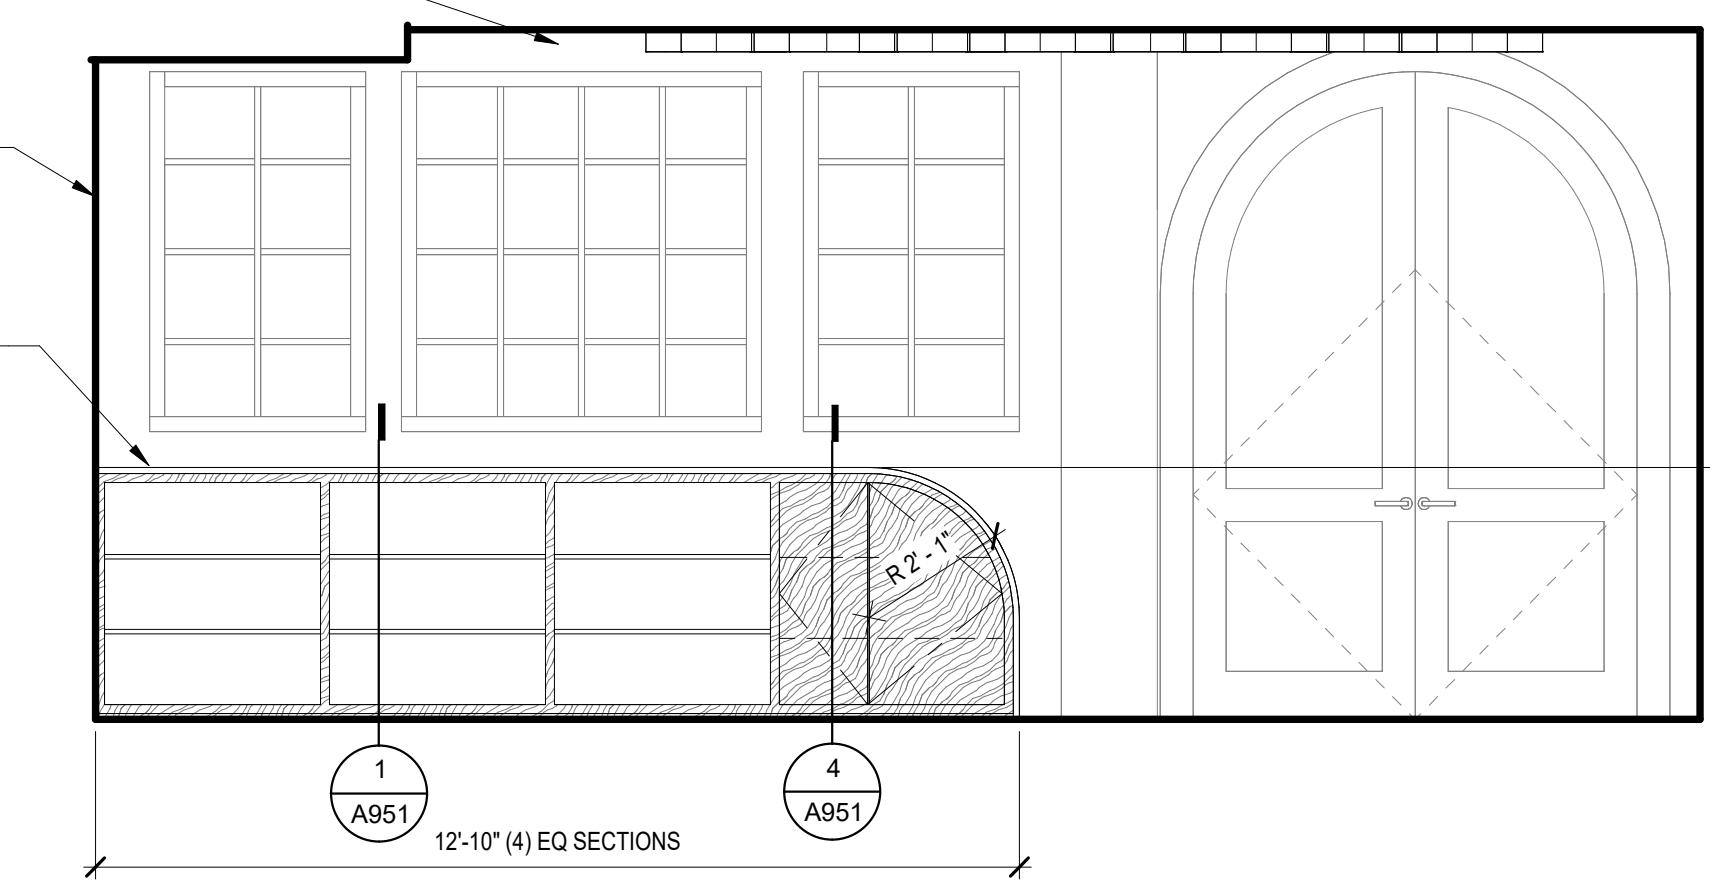
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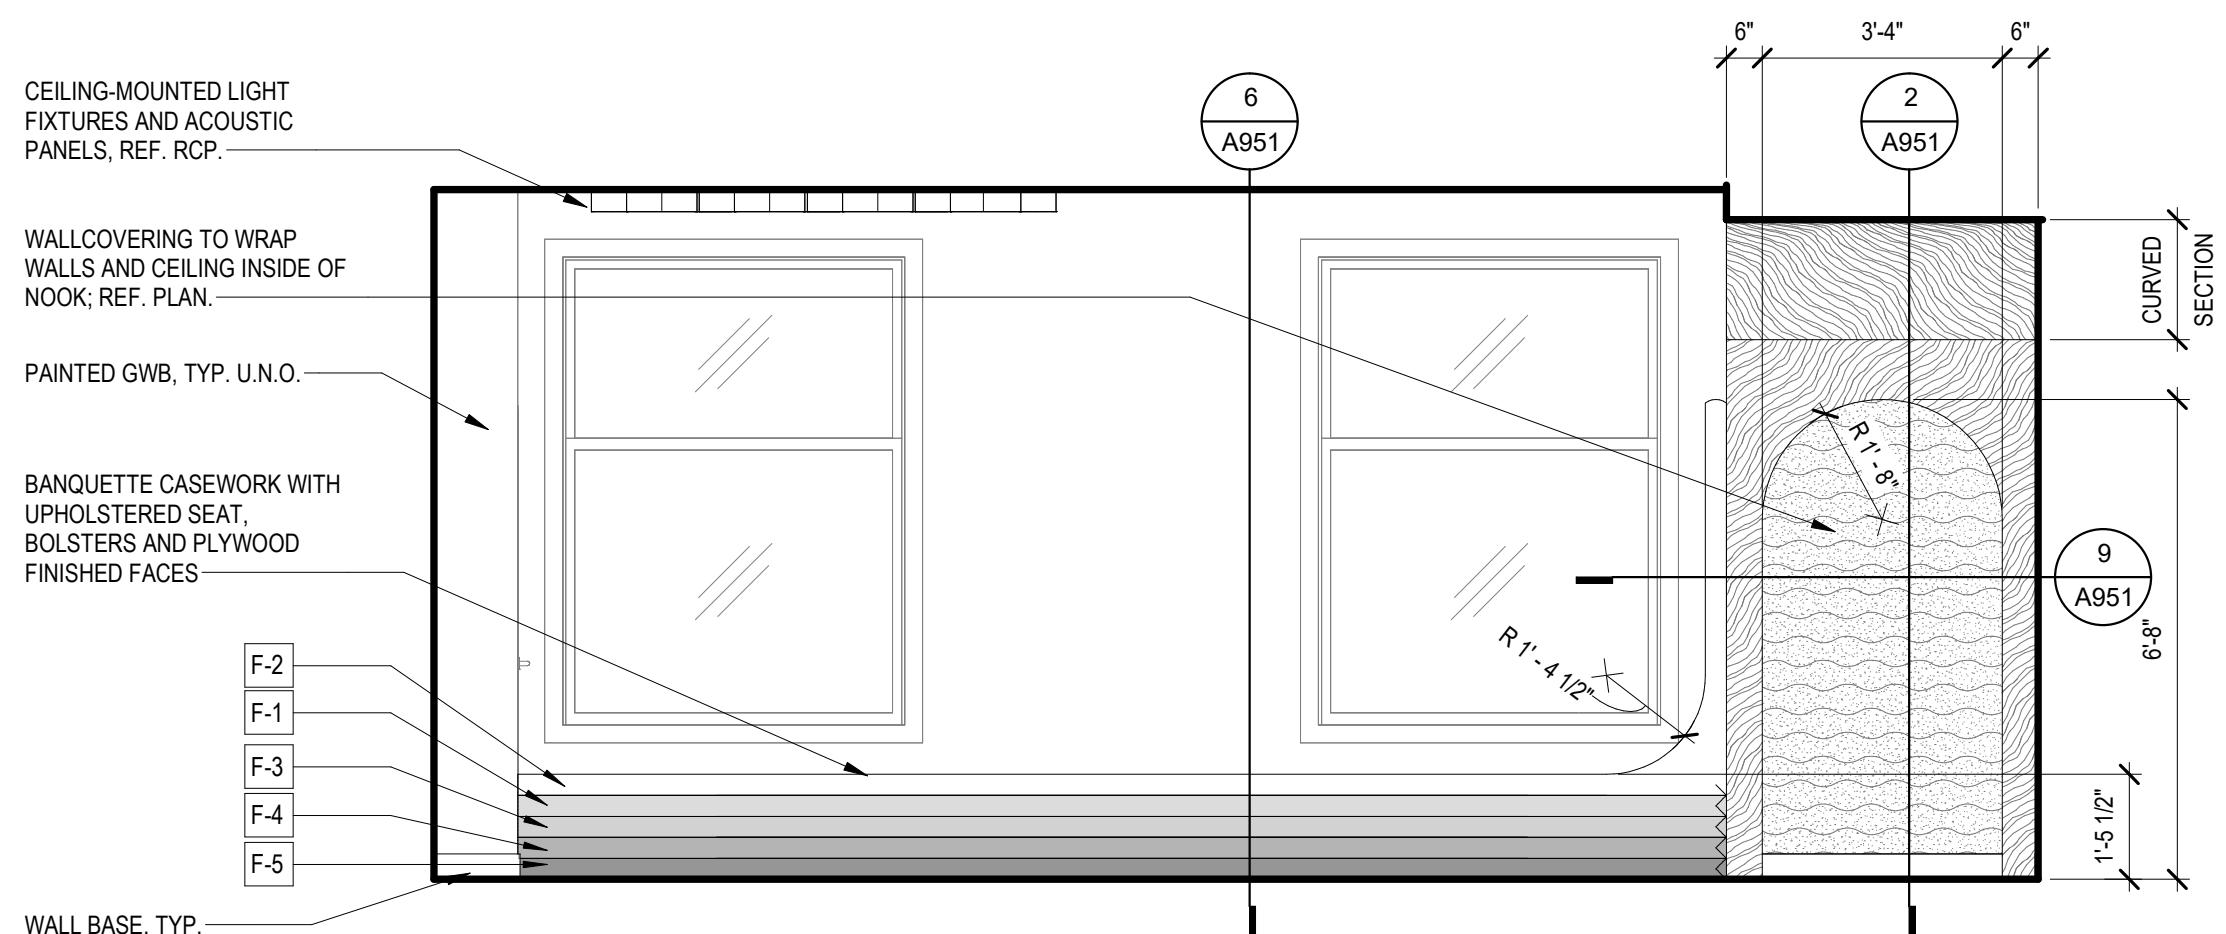
6 138 - NOOK - SOUTH  
SCALE: 3/8" = 1'-0"




4 138 - EARLY LEARNING - EAST  
SCALE: 3/8" = 1'-0"




1 138 - EARLY LEARNING - NORTH  
SCALE: 3/8" = 1'-0"




7 138 - EARLY LEARNING - SOUTH  
SCALE: 3/8" = 1'-0"

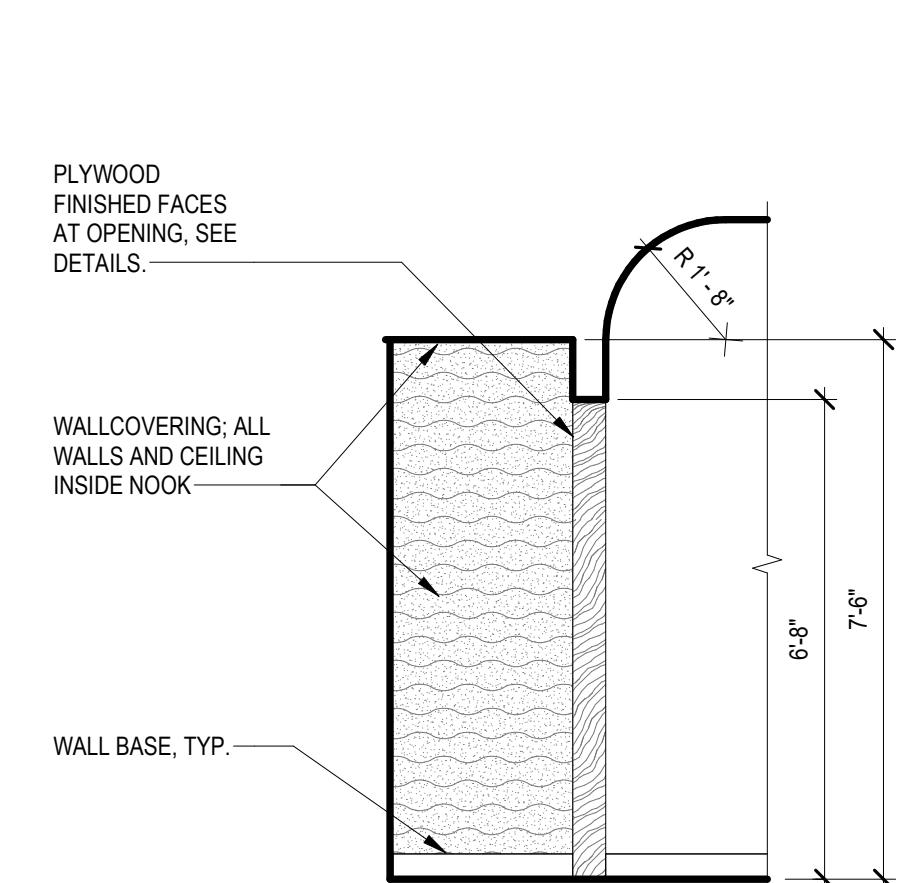


5 138 - NOOK - WEST  
SCALE: 3/8" = 1'-0"

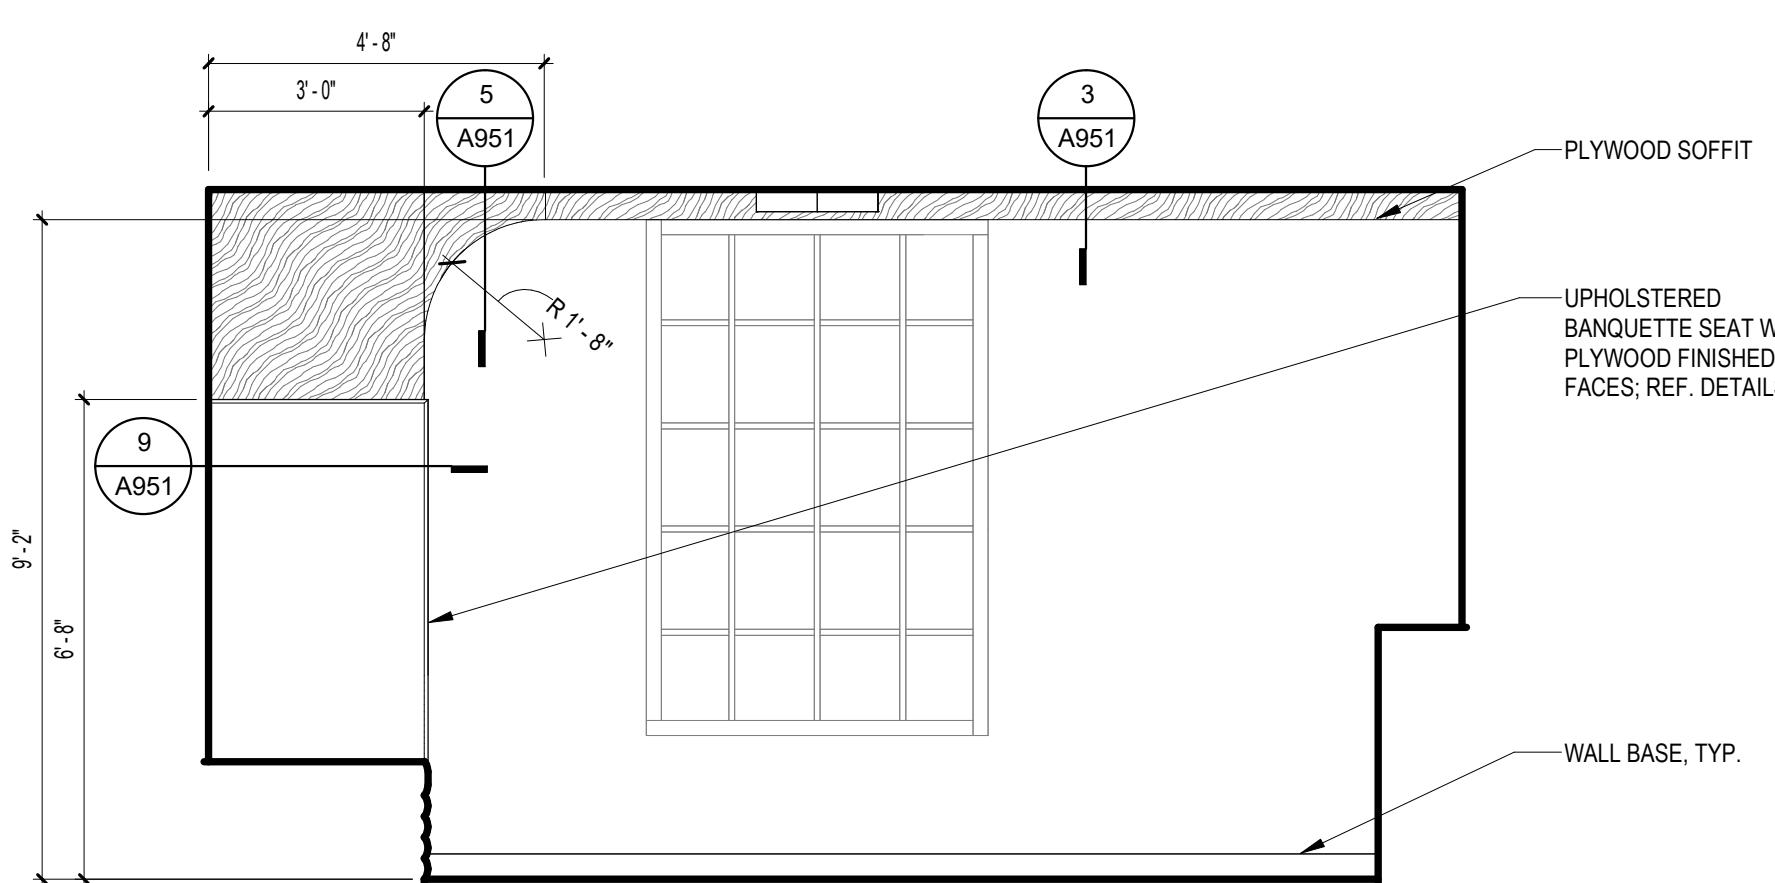

2 138 - EARLY LEARNING - WEST  
SCALE: 3/8" = 1'-0"

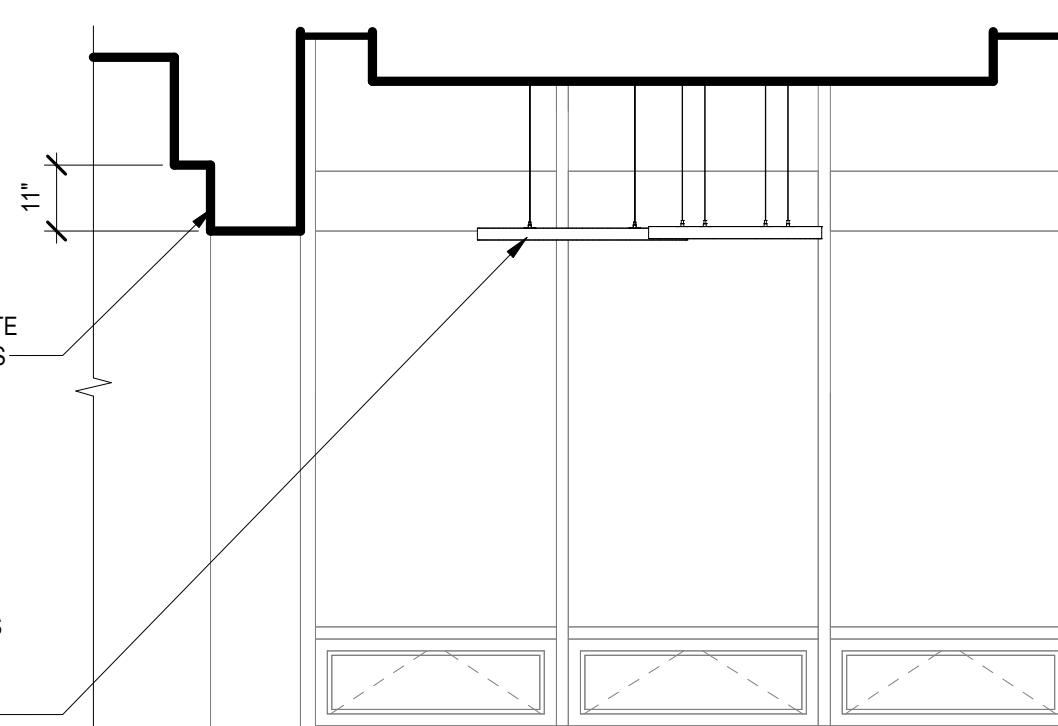

3 135 - CHILDREN'S COZY READING - NORTH  
SCALE: 3/8" = 1'-0"

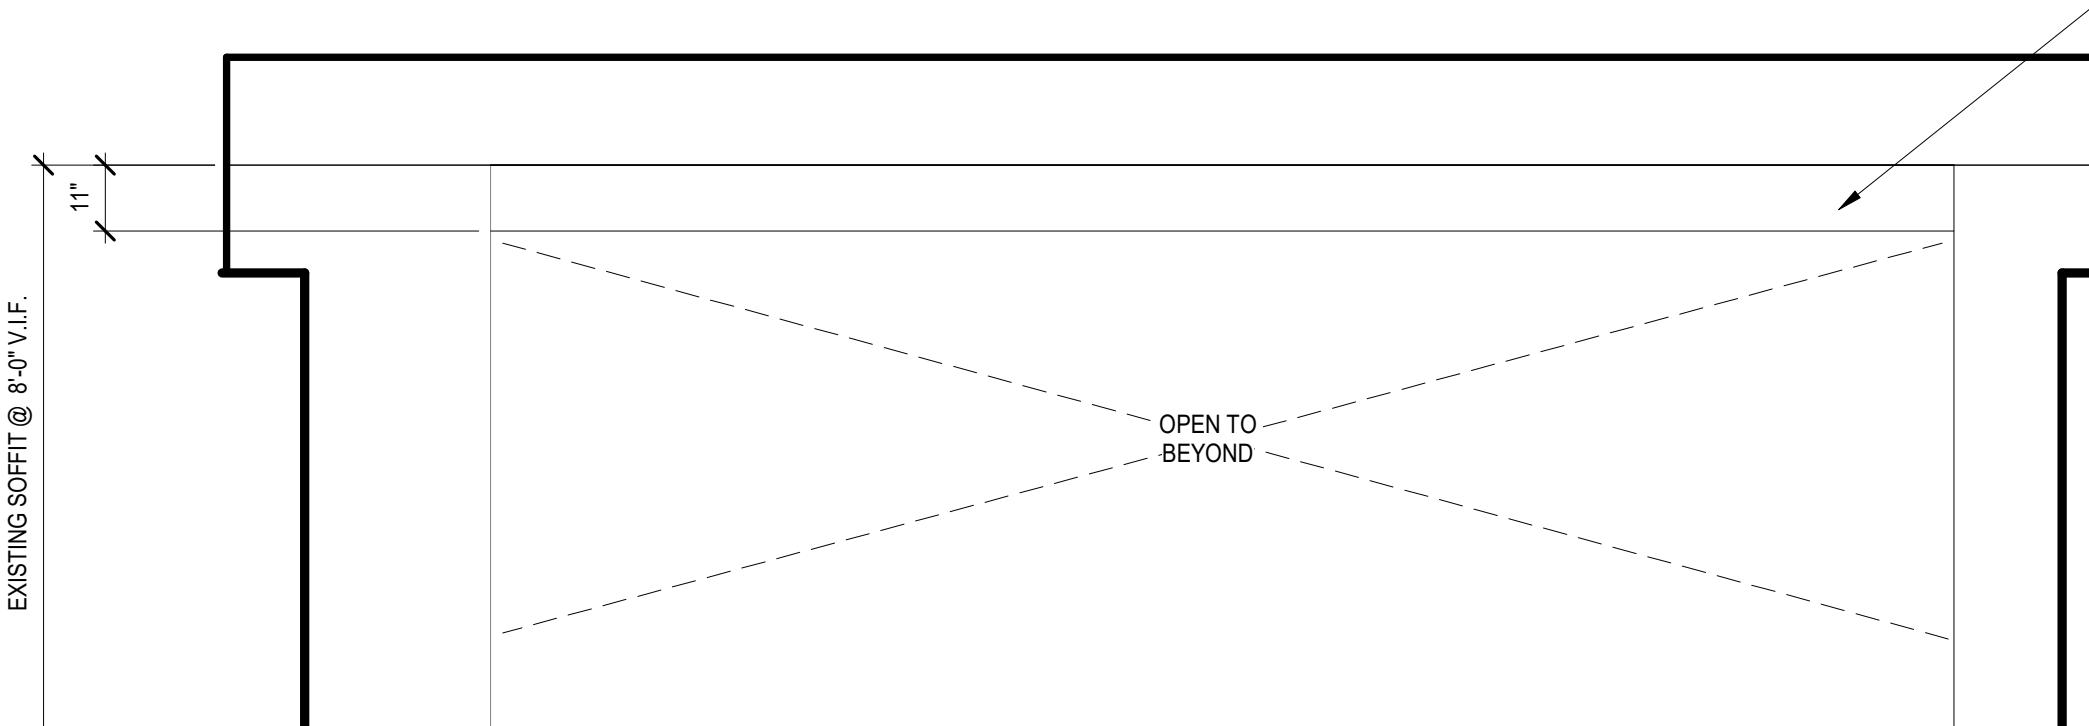

8 135 - CHILDREN'S COZY READING  
SCALE: 3/8" = 1'-0"



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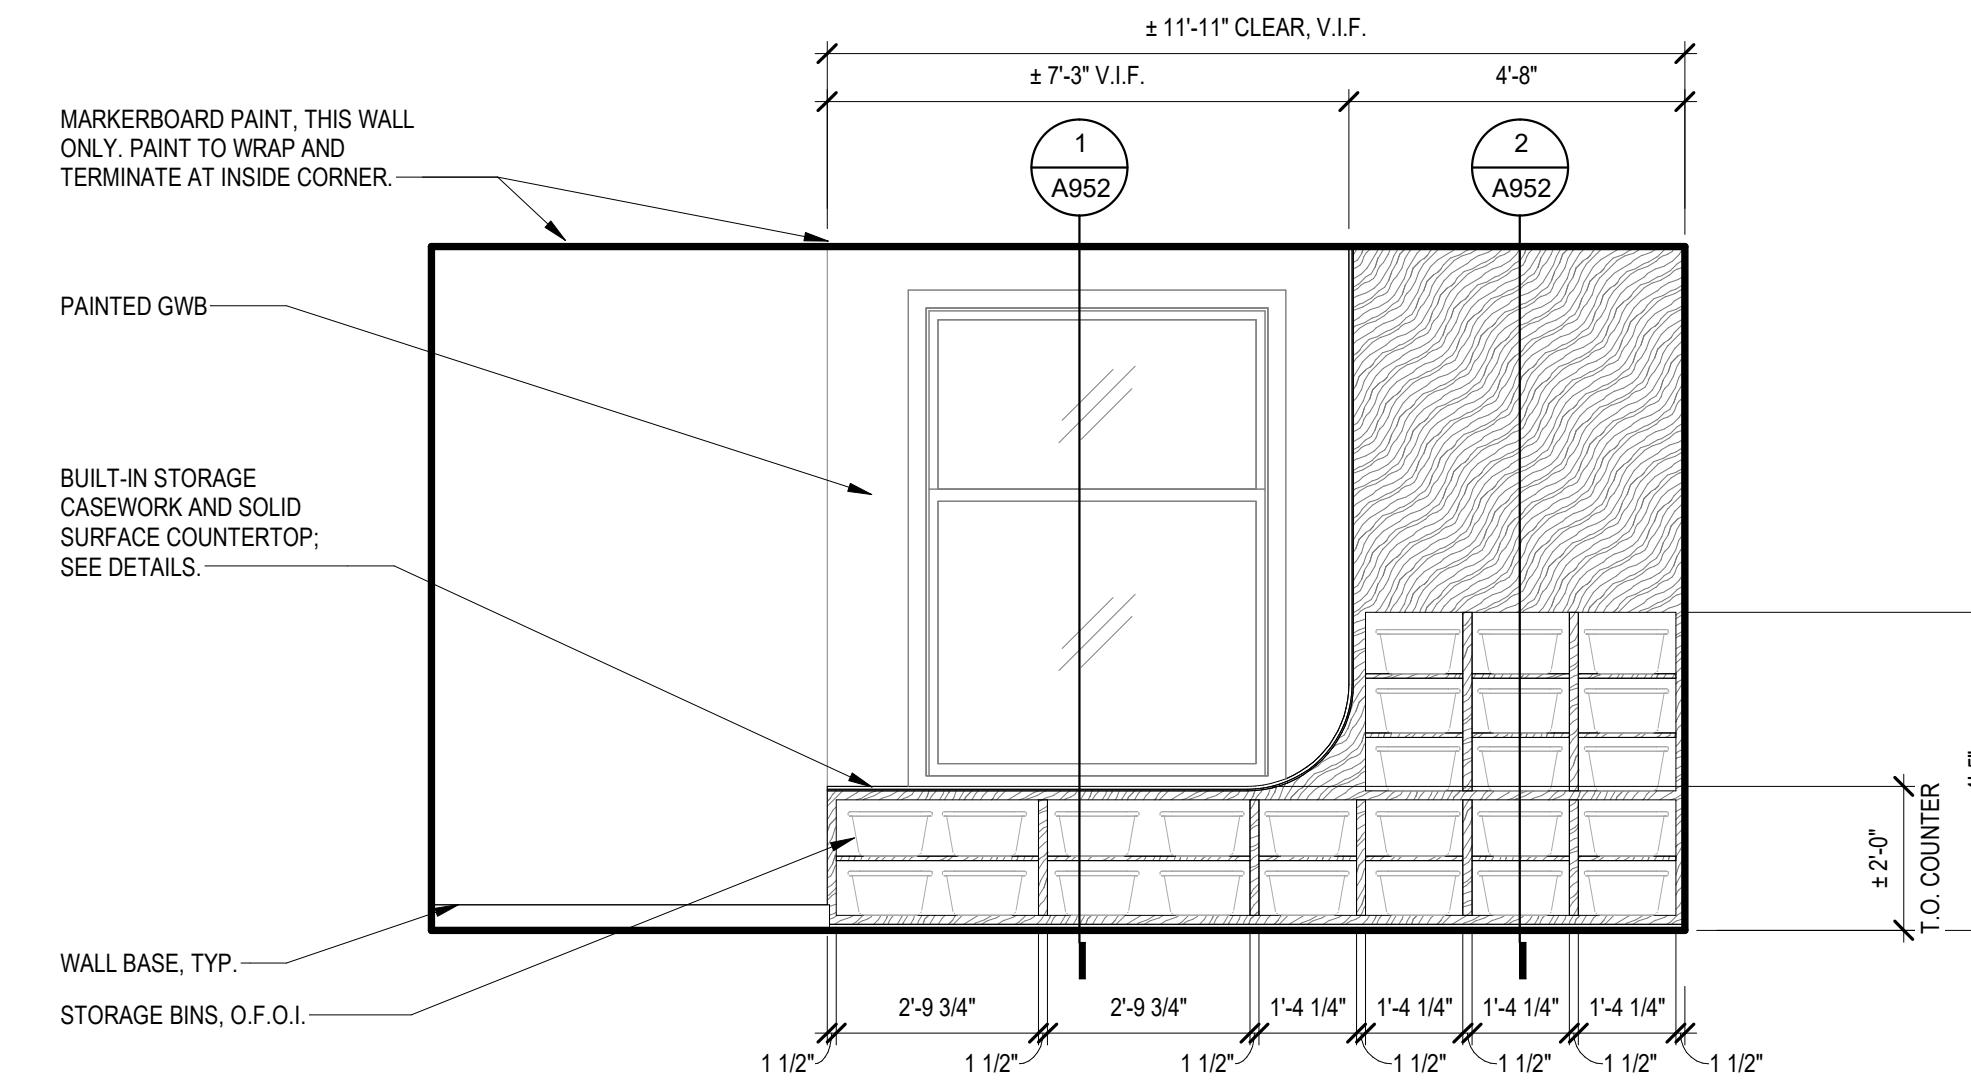
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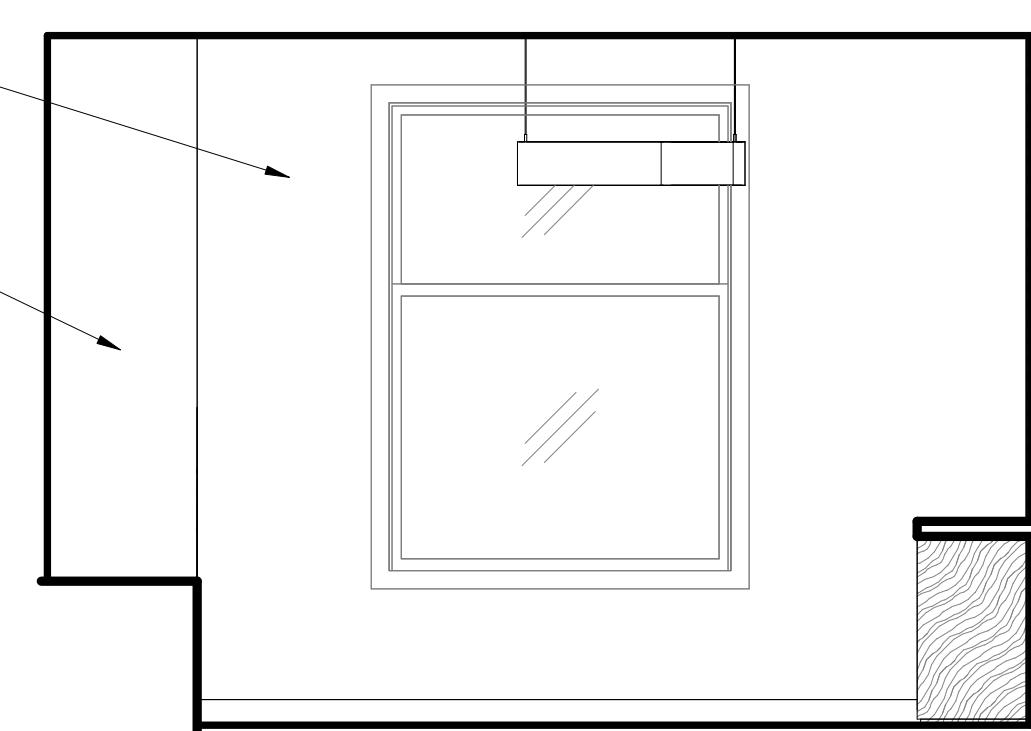
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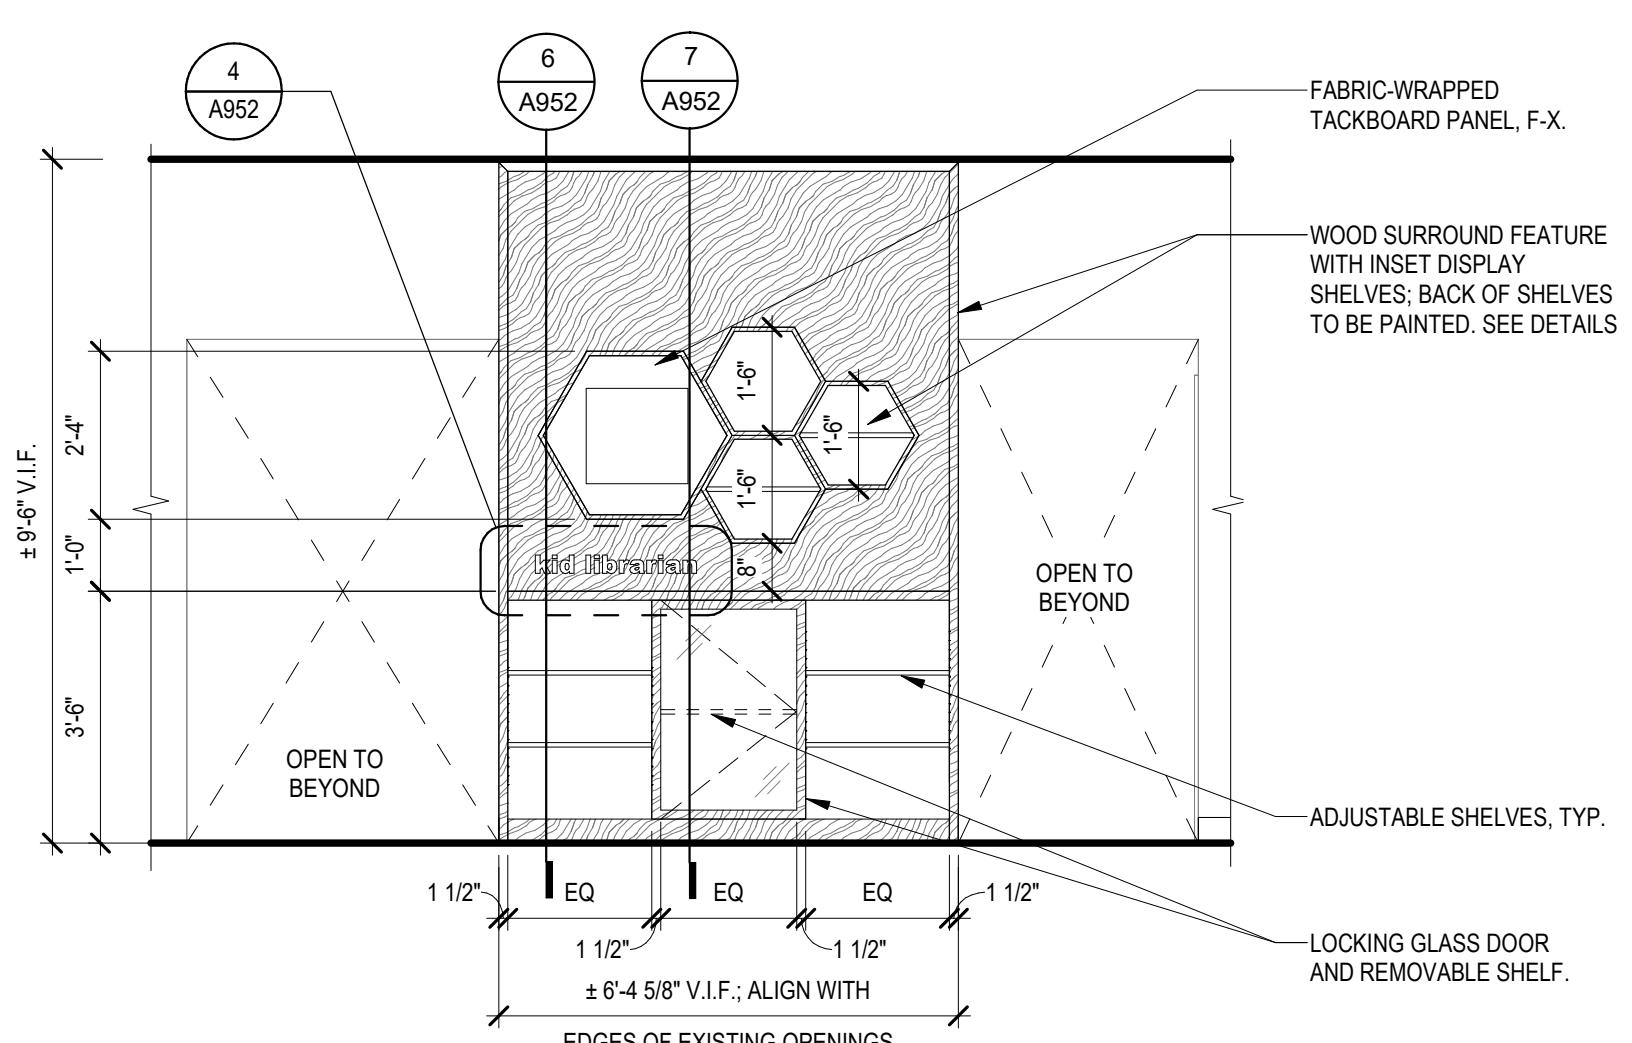
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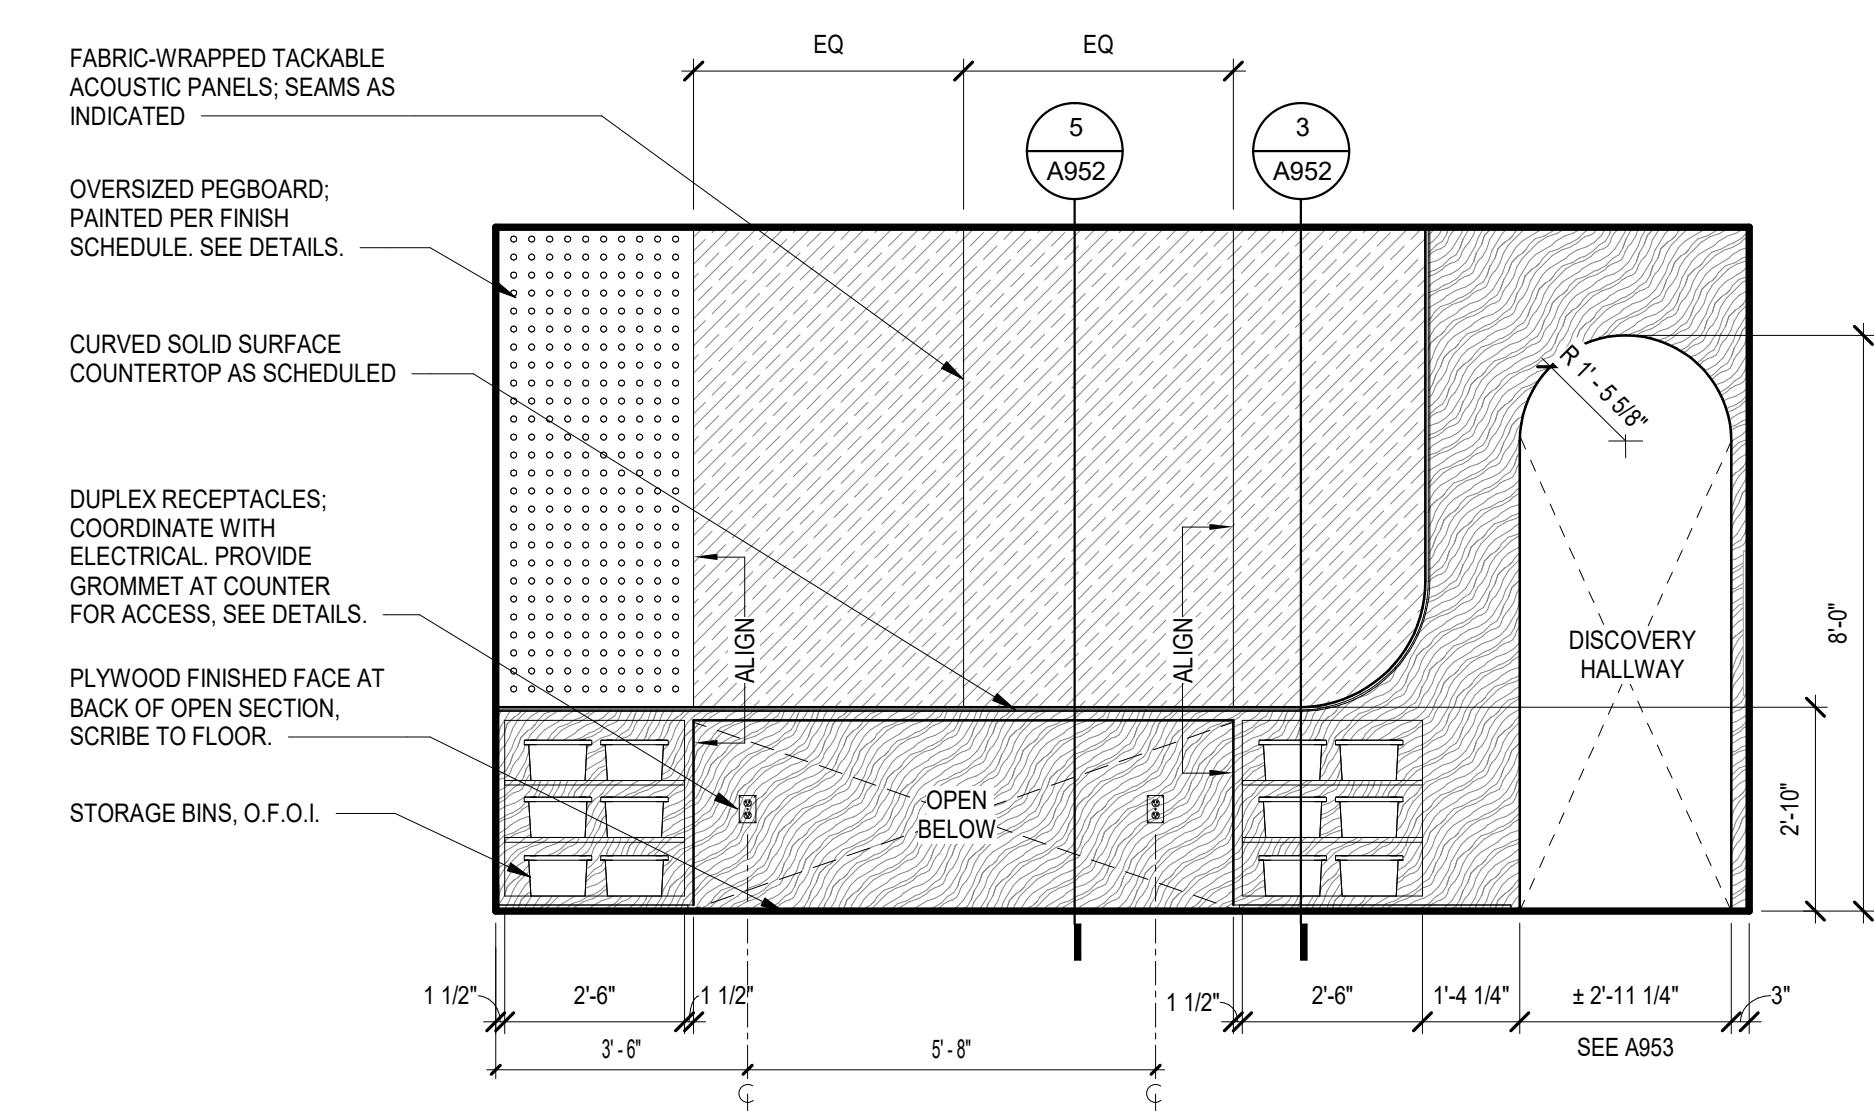
1 137 - INDIVIDUAL EXPLORATION - EAST  
SCALE: 3/8" = 1'-0"



2 137 - INDIVIDUAL EXPLORATION - SOUTH  
SCALE: 3/8" = 1'-0"



4 KID LIBRARIAN - EAST  
SCALE: 3/8" = 1'-0"



3 137 - INDIVIDUAL EXPLORATION - WEST  
SCALE: 3/8" = 1'-0"

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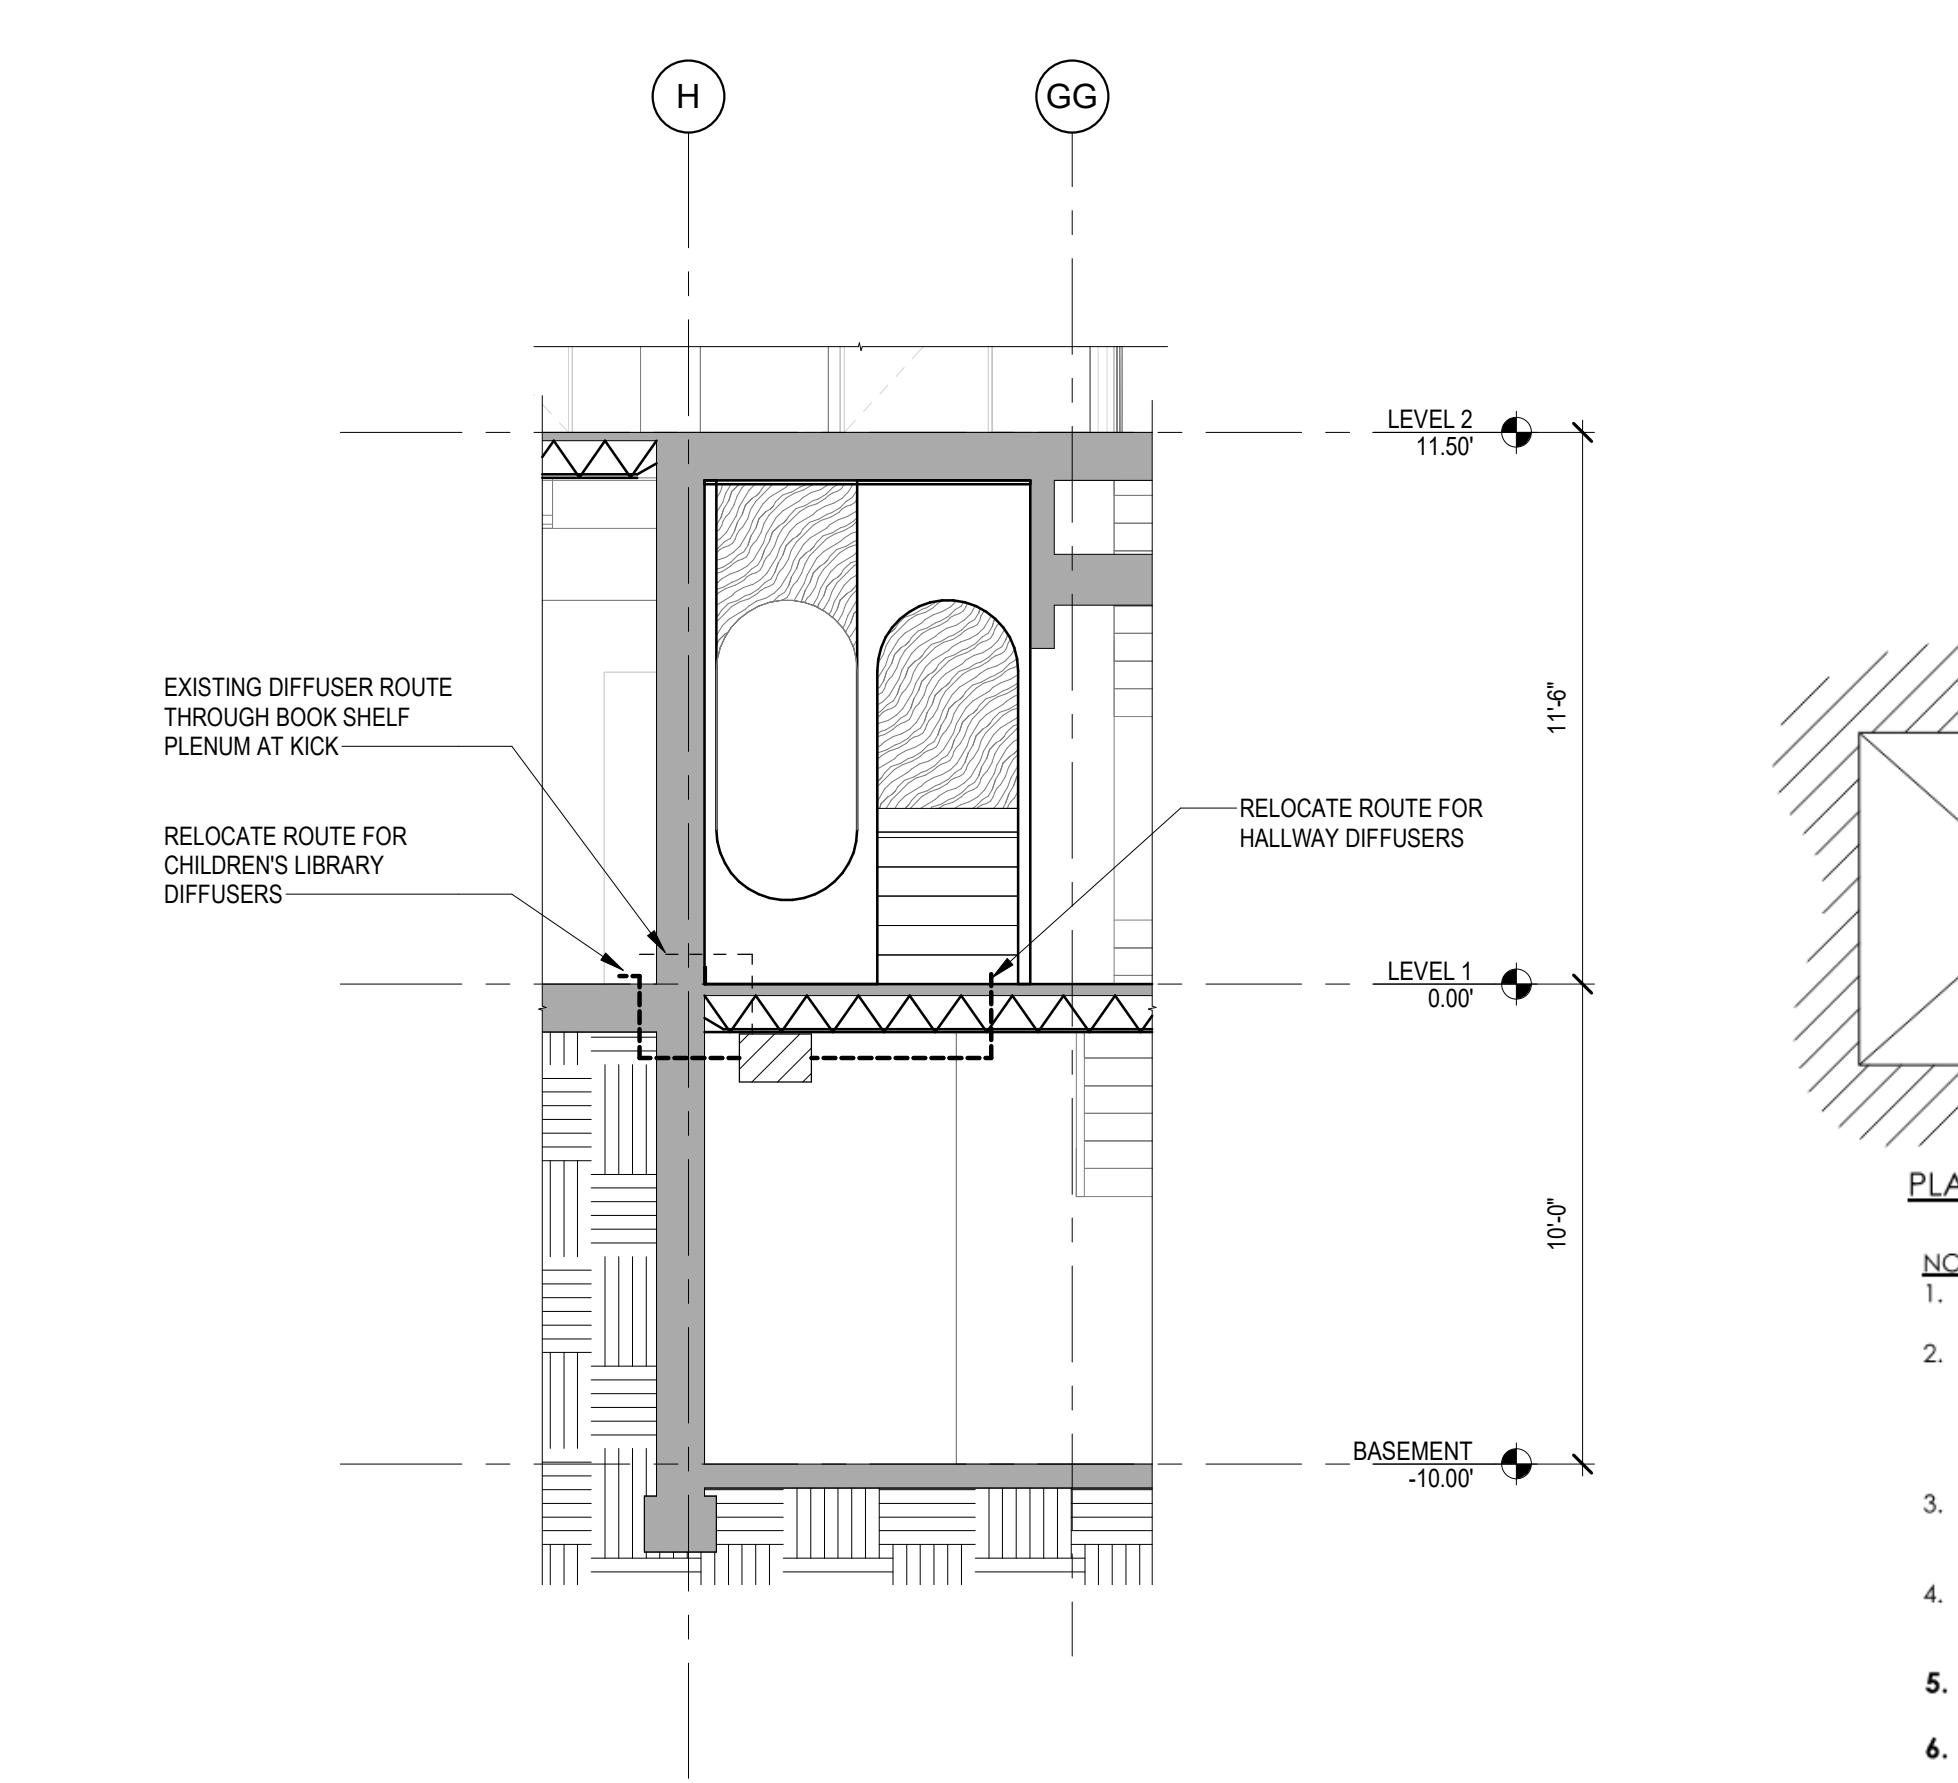
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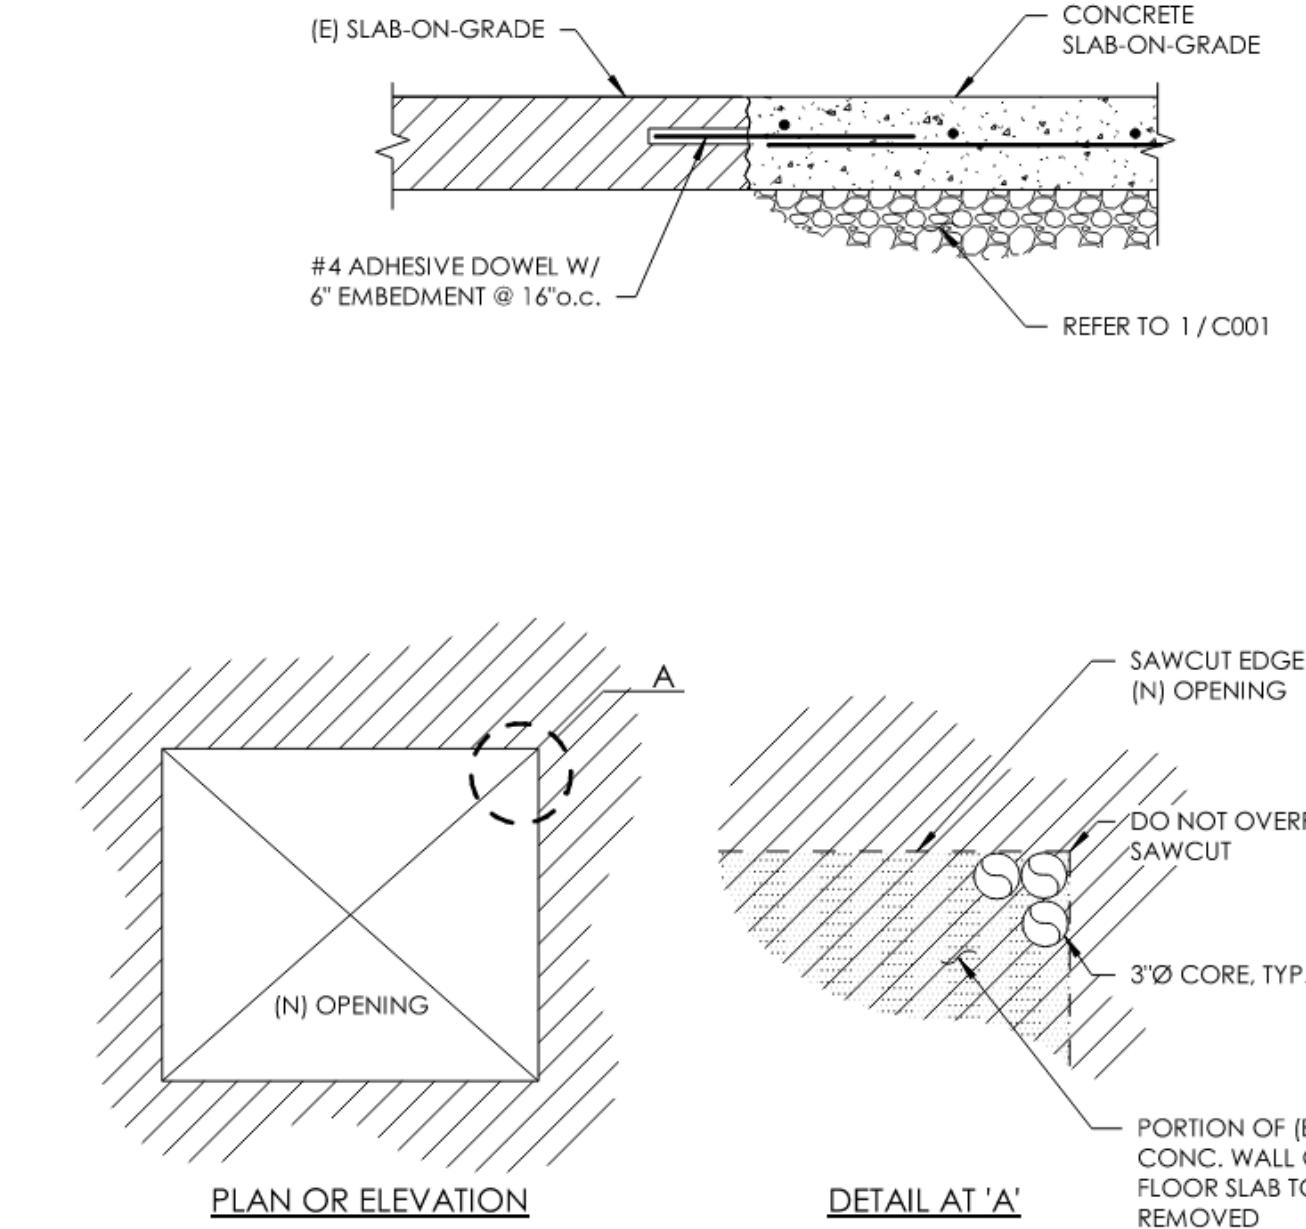
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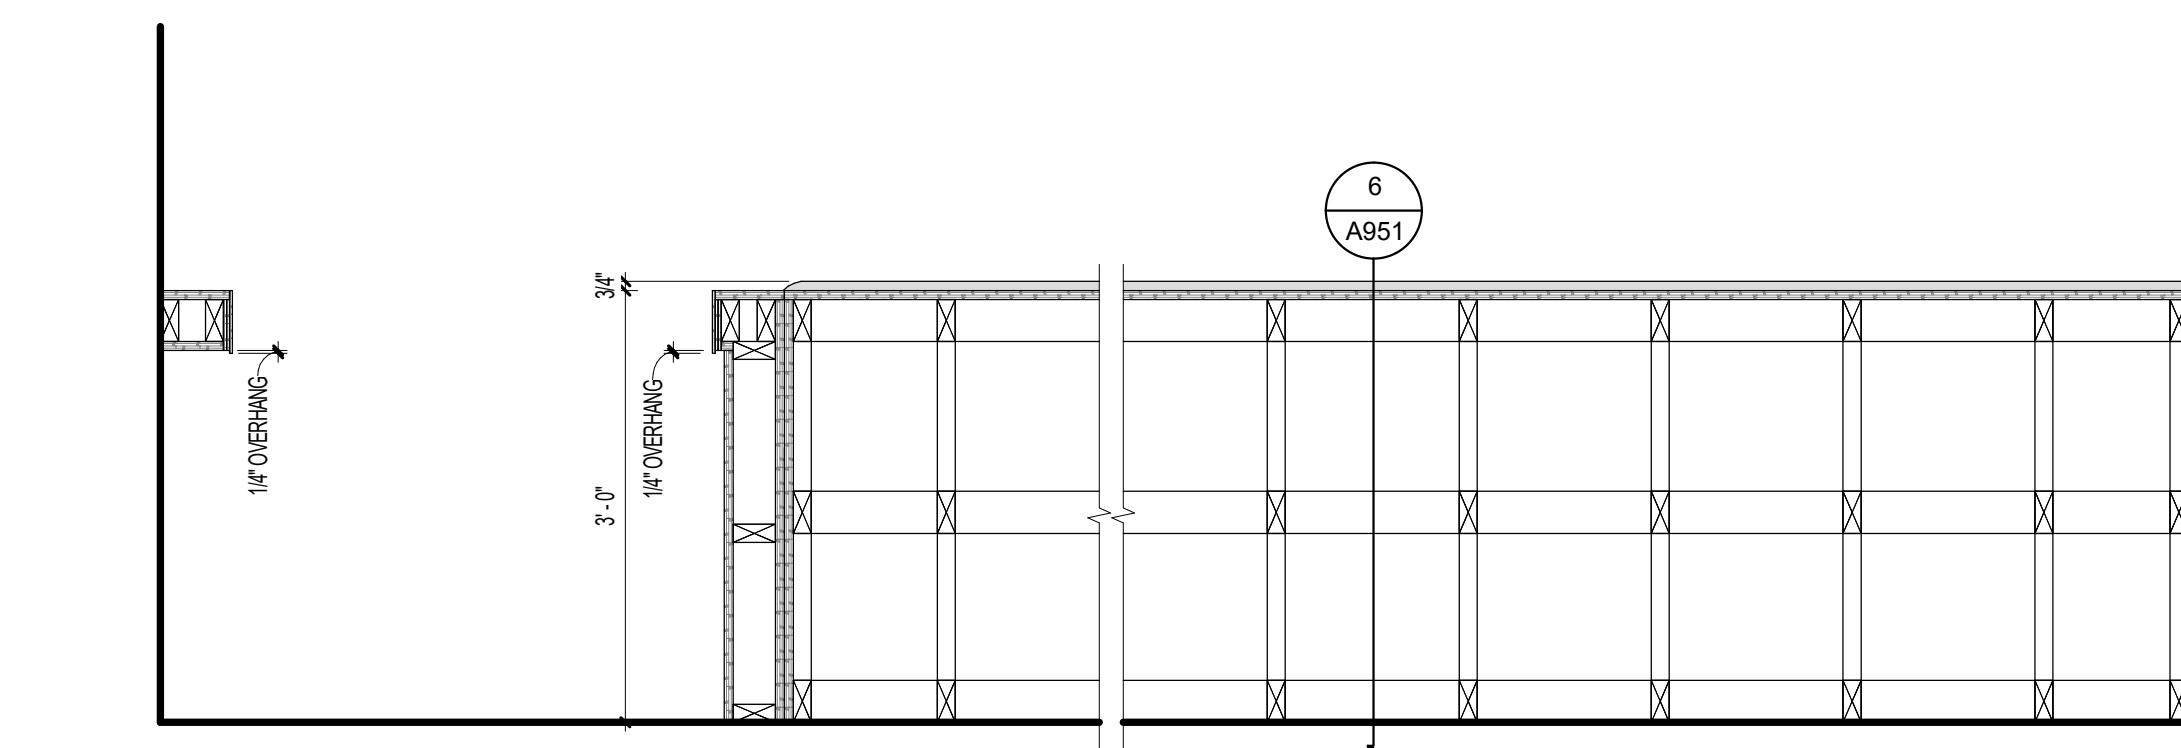
**3** N/S SECTION - MECHANICAL DIFFUSER LOCATION  
SCALE: 1/4" = 1'-0"



**2** (N) OPENINGS AND INFILL AT (E) CONCRETE WALL

**NOTES:**

1. CUT OPENINGS IN (E) CONCRETE ONLY AS INDICATED IN THE STRUCTURAL DRAWINGS.
2. CUT NEW OPENINGS AS FOLLOWS:
  - A. CORE HOLES AT EACH CORNER;
  - B. SAWCUT BETWEEN CORNERS;
  - C. CHIP AWAY REMAINING CONCRETE AT CORED HOLES.
3. WHERE CUT REINFORCING WILL BE EXPOSED TO EARTH OR WEATHER, CHIP AWAY CONCRETE AROUND BAR TO 3/4" DEPTH ALL AROUND. CUT REINFORCING AND FILL HOLE WITH EPOXY.
4. DO NOT CUT NEW OPENINGS THROUGH (E) BEAMS, JOISTS, COLUMNS, OR PILASTERS, UNLESS SPECIFICALLY SHOWN AND NOTED ON THE STRUCTURAL DRAWINGS.
5. CONCRETE COMPRESSIVE STRENGTH,  $f_c = 3,000$  PSI MINIMUM.
6. REINFORCING STEEL MINIMUM YIELD STRENGTH,  $f_y = 60,000$  PSI MINIMUM
7. SPECIAL INSPECTION OF ADHESIVE DOWEL INSTALLATION REQUIRED.





11 138 - EARLY LEARNING - PLAN SECTION

SCALE: 3/4" = 1'-0"


9 138 - EARLY LEARNING - BANQUETTE 2

SCALE: 1" = 1'-0"

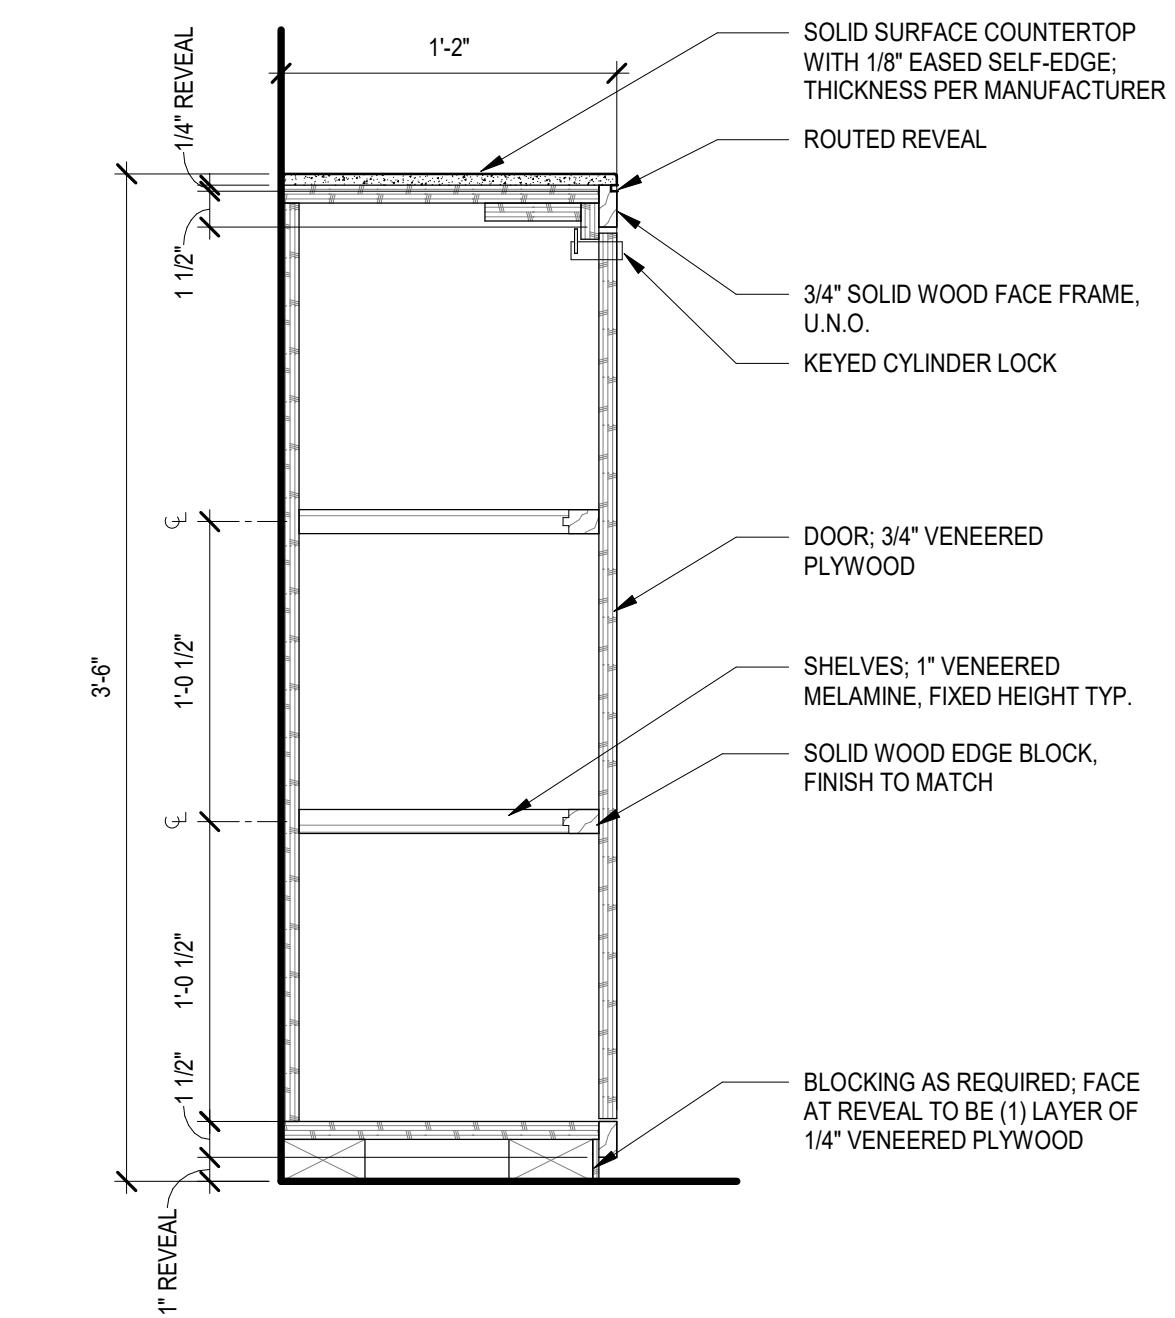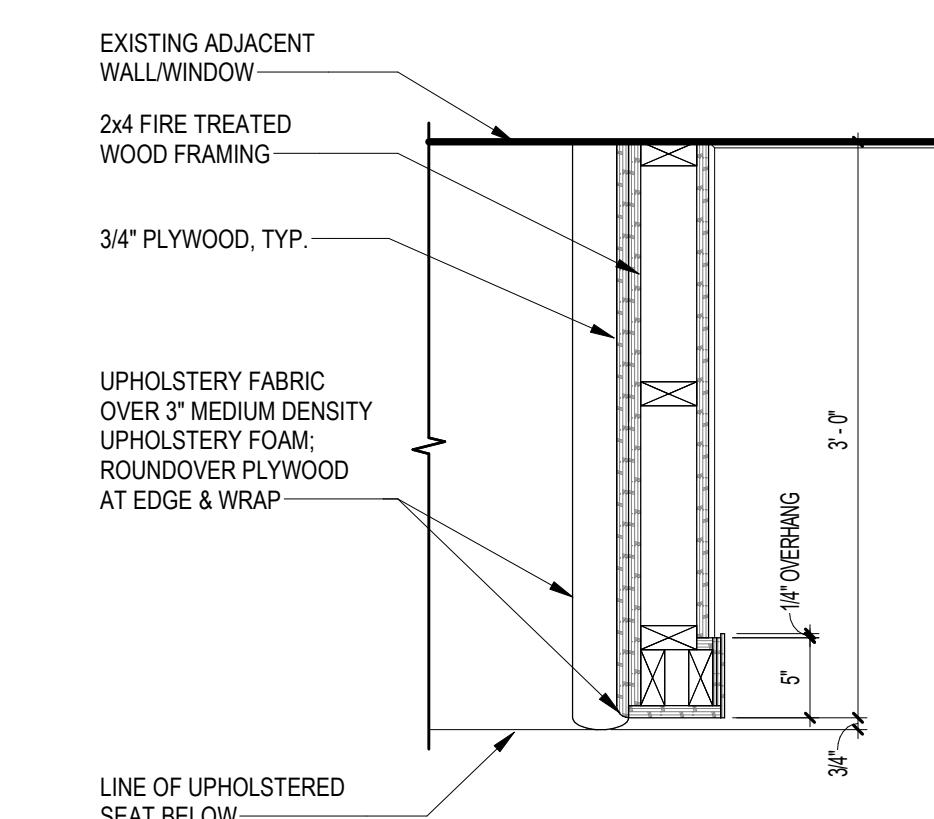


4 138 - EARLY LEARNING - LOCKING CABINET

SCALE: 1 1/2" = 1'-0"

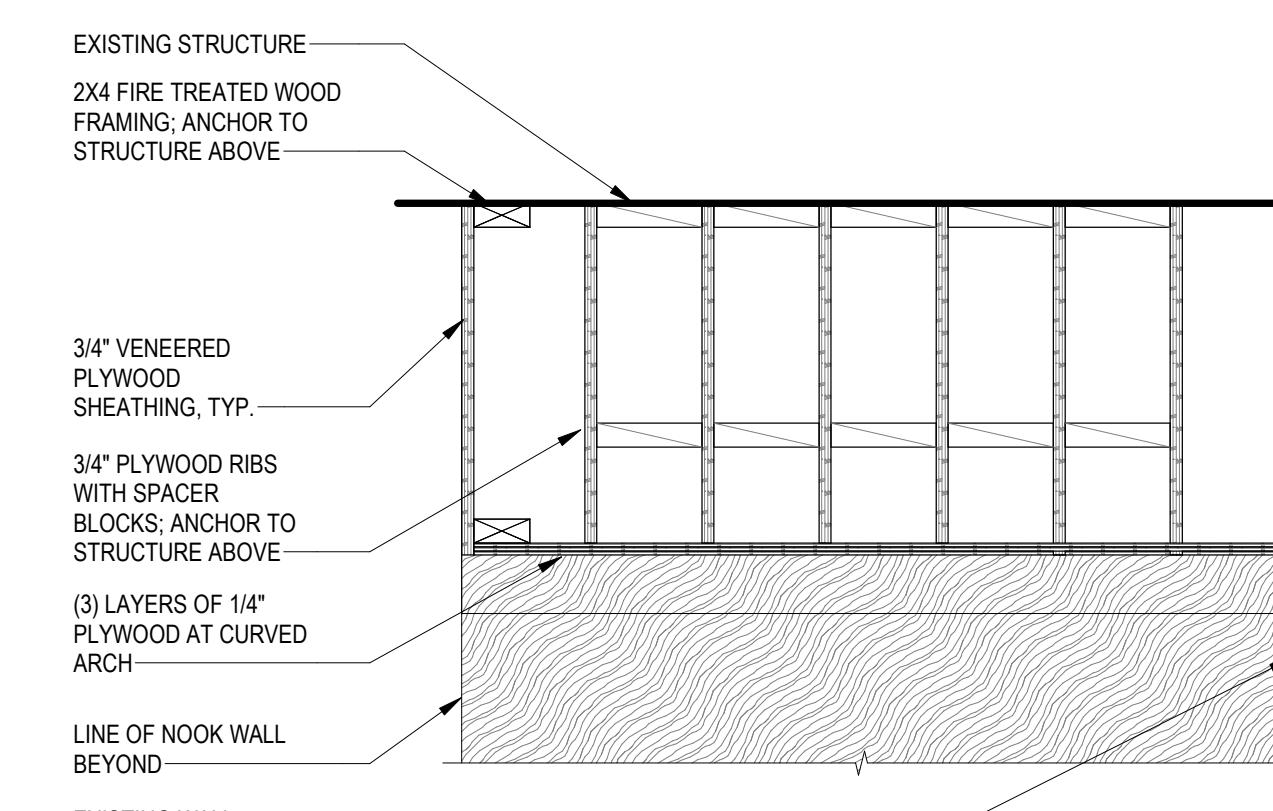


5 138 - PLYWOOD SOFFIT @ ARCH

SCALE: 1" = 1'-0"

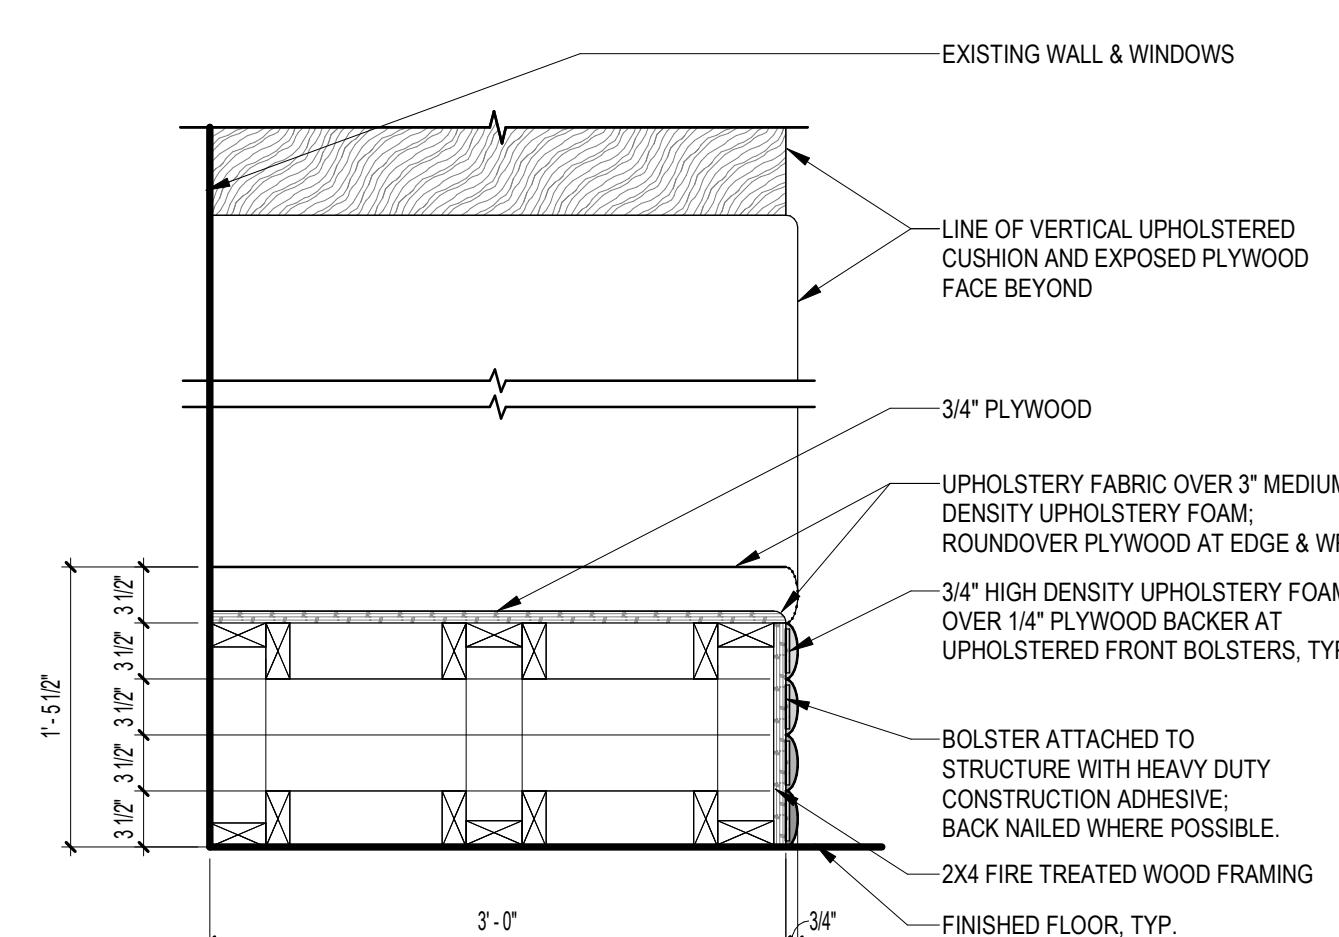


6 138 - EARLY LEARNING - BANQUETTE 1

SCALE: 1" = 1'-0"

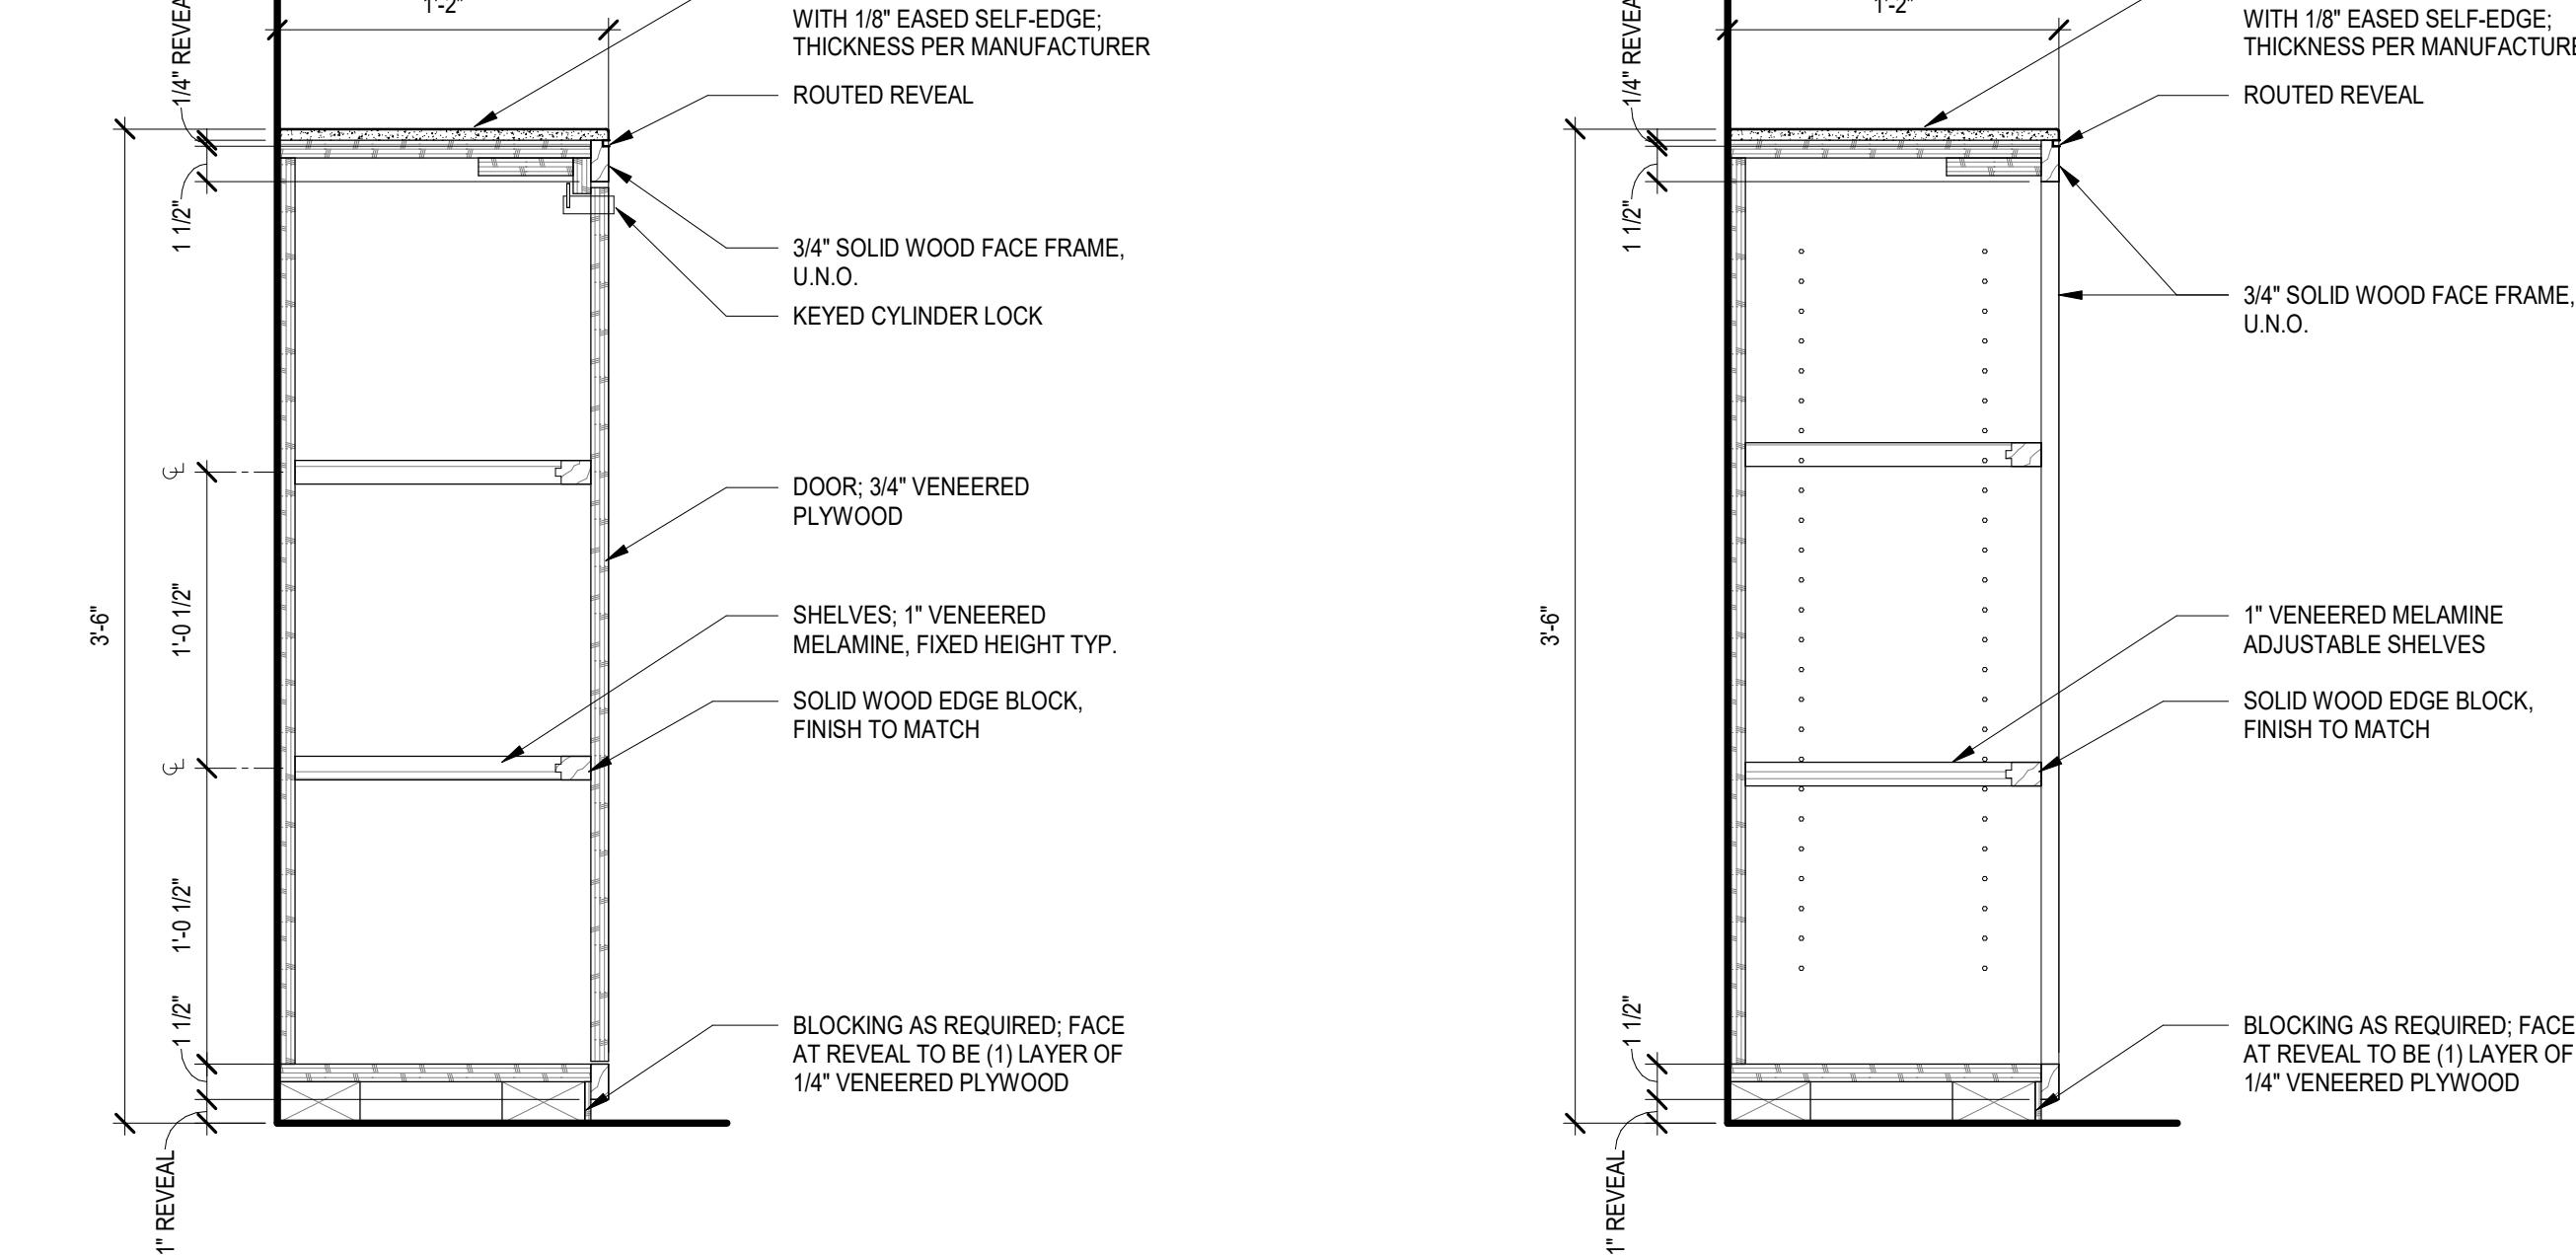


1 138 - EARLY LEARNING - OPEN SHELVES

SCALE: 1 1/2" = 1'-0"

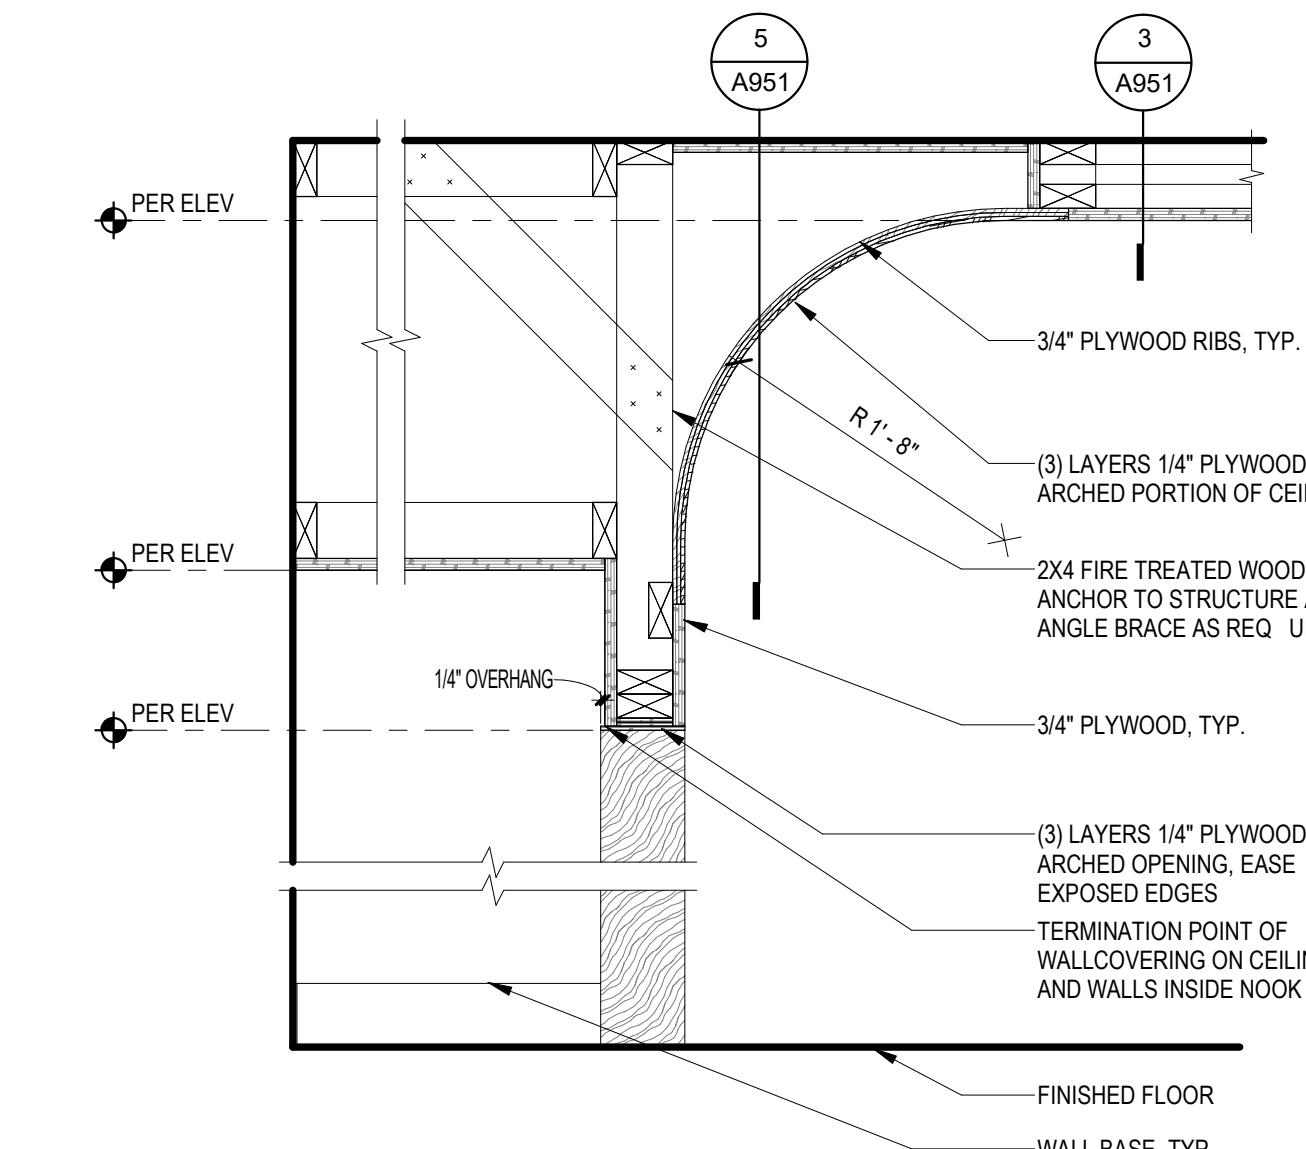

2 138 - EARLY LEARNING - SOFFIT @ NOOK

SCALE: 1" = 1'-0"

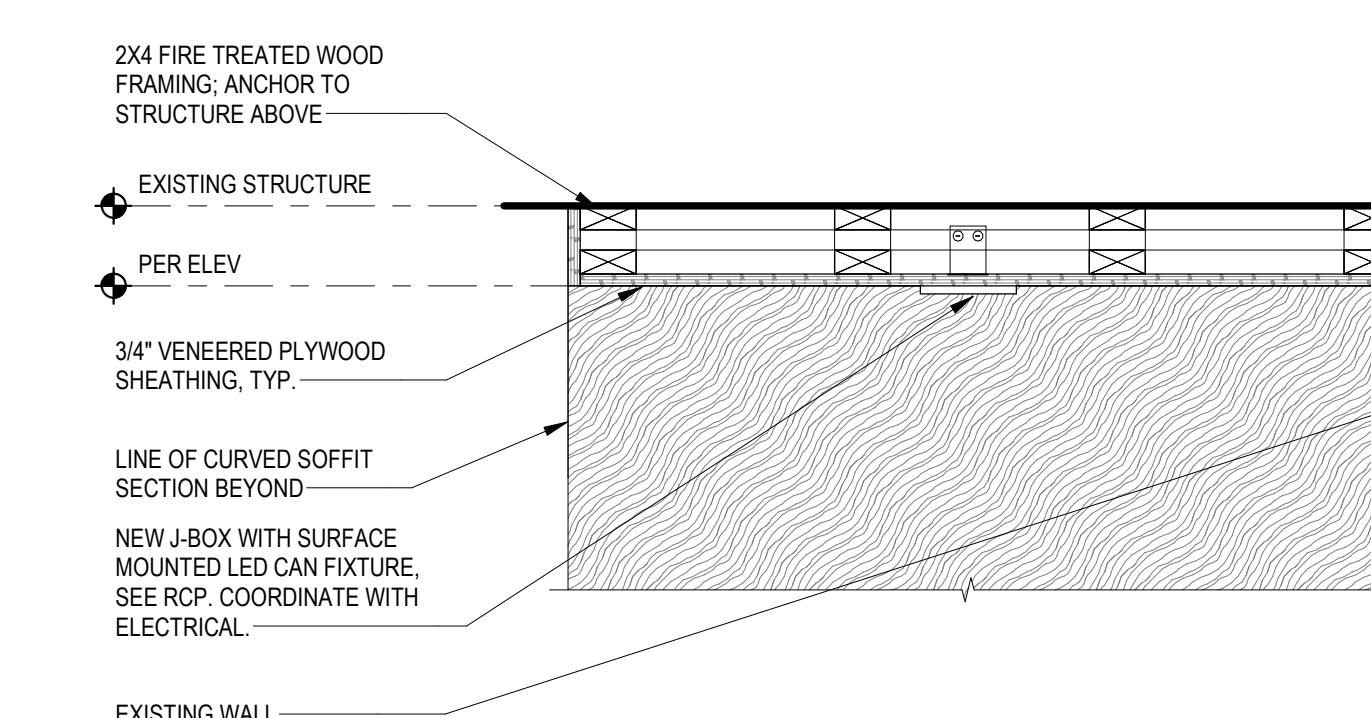

3 138 - EARLY LEARNING - PLYWOOD SOFFIT

SCALE: 1" = 1'-0"

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INTERIOR DETAILS

SHEET NO.


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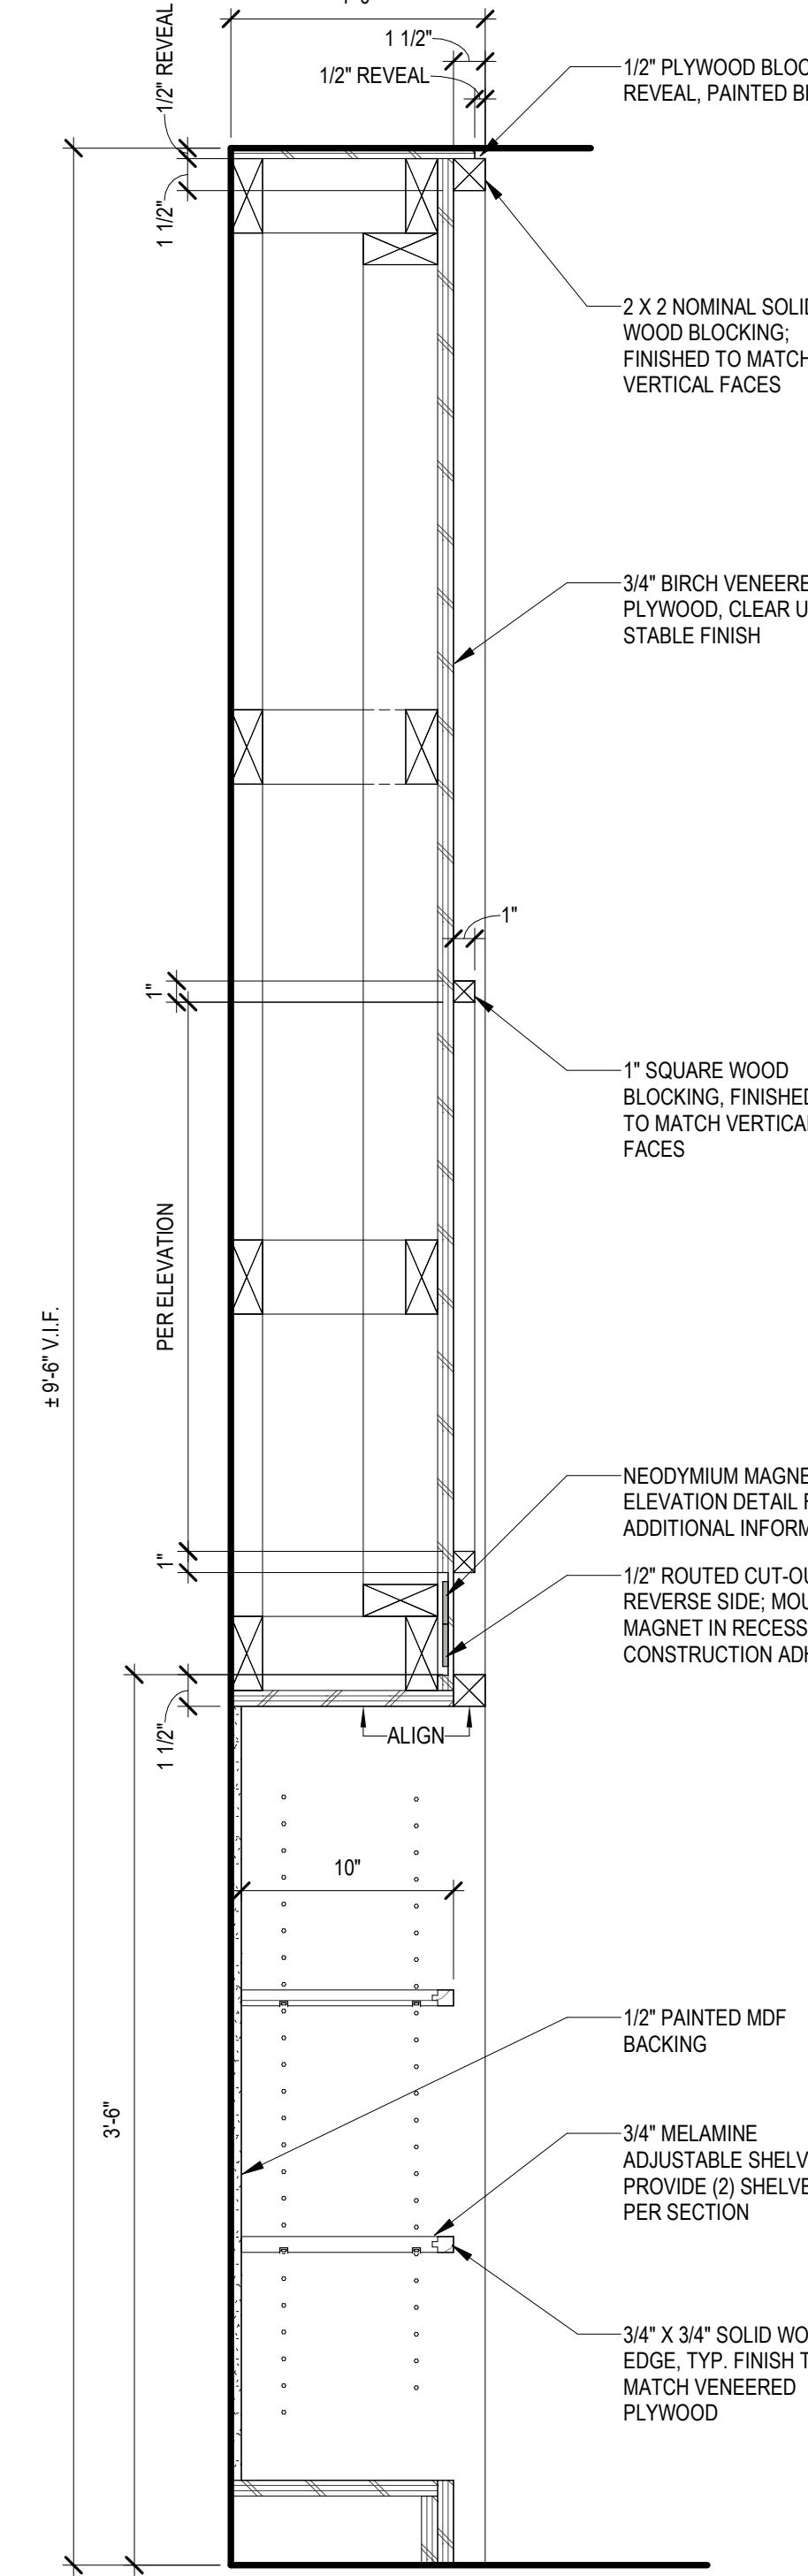
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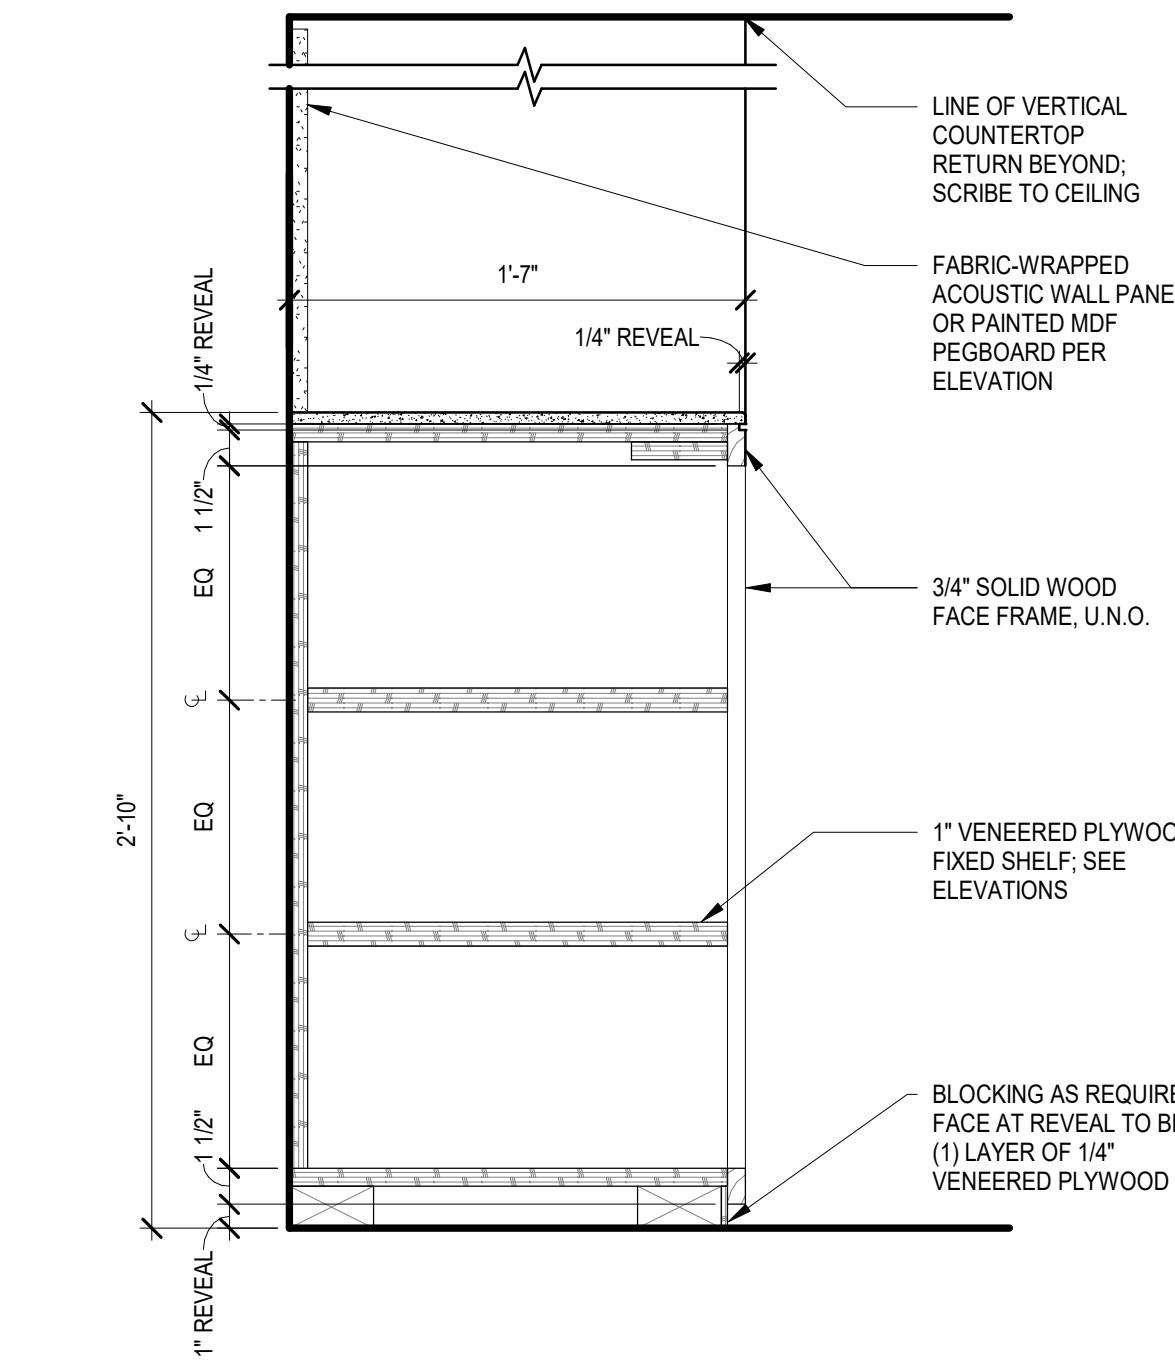
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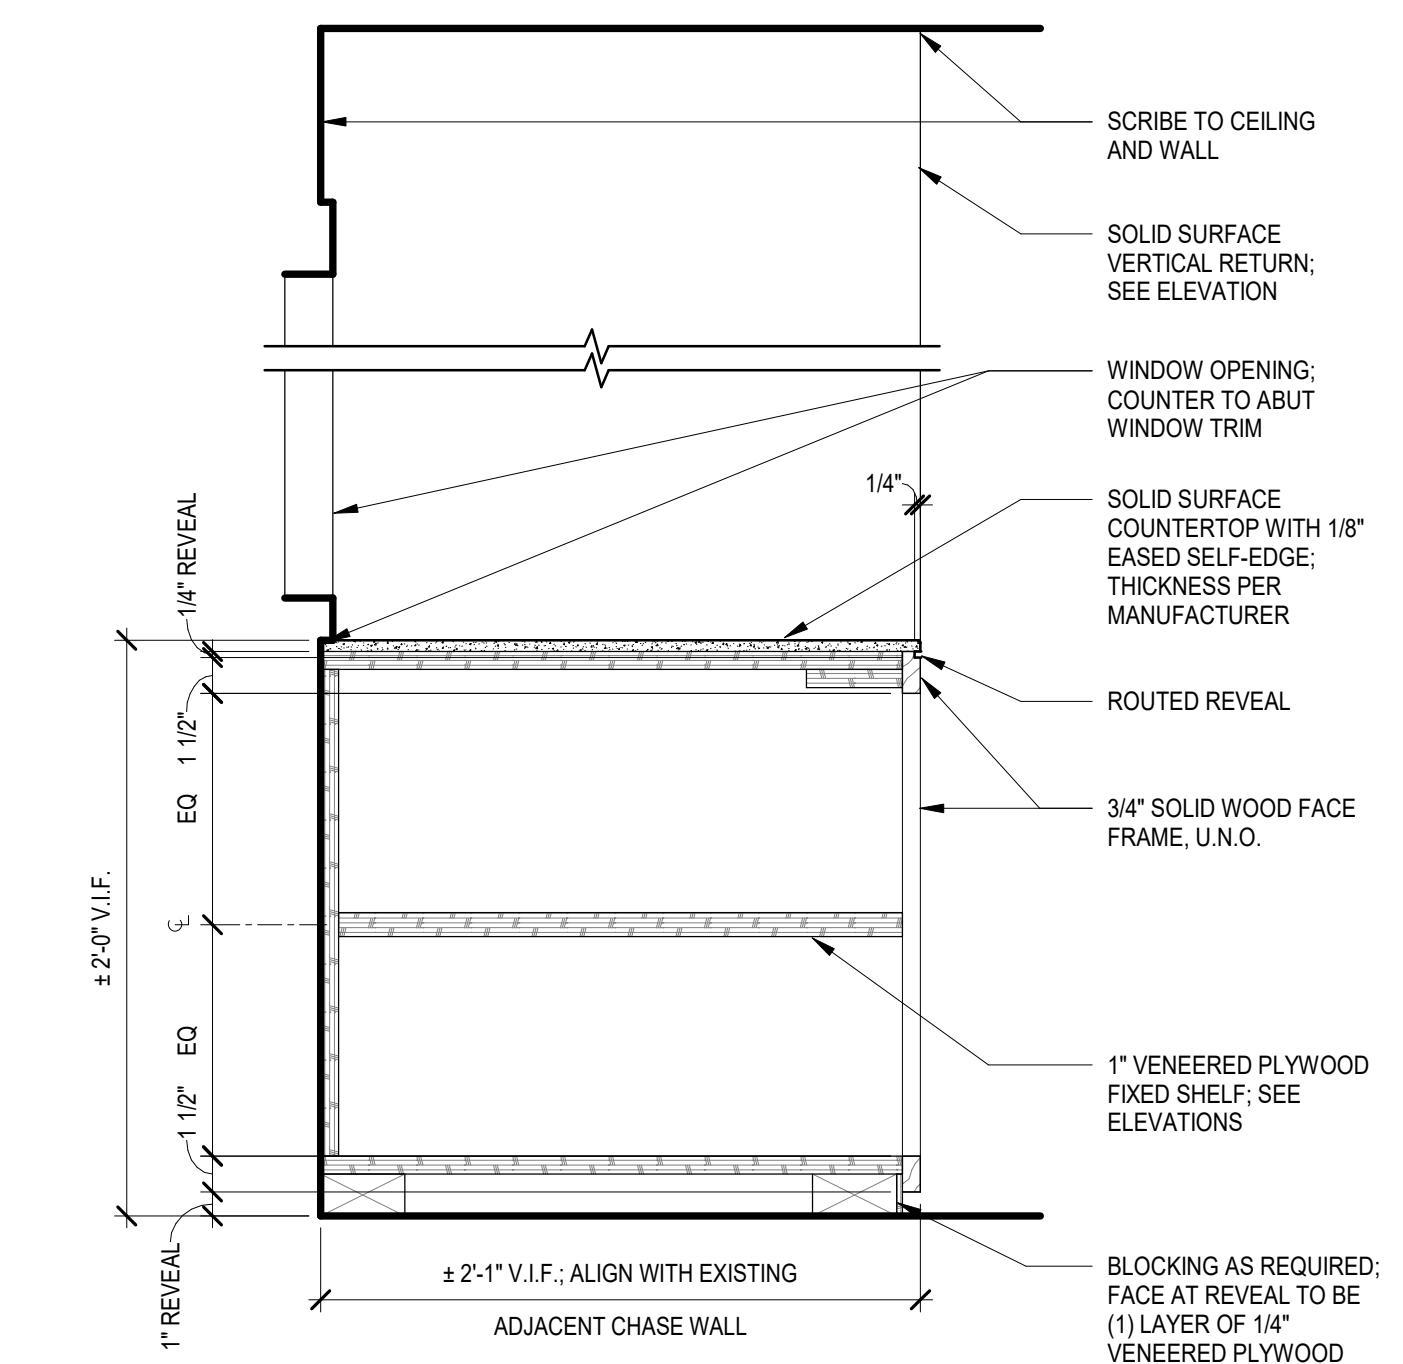
7 143 - KID LIBRARIAN - LOCKING CABINET




**6 143 - KID LIBRARIAN - OPEN SHELVES**




3 137 - WEST WALL STORAGE  
SCALE: 1 1/2" = 1'-0"

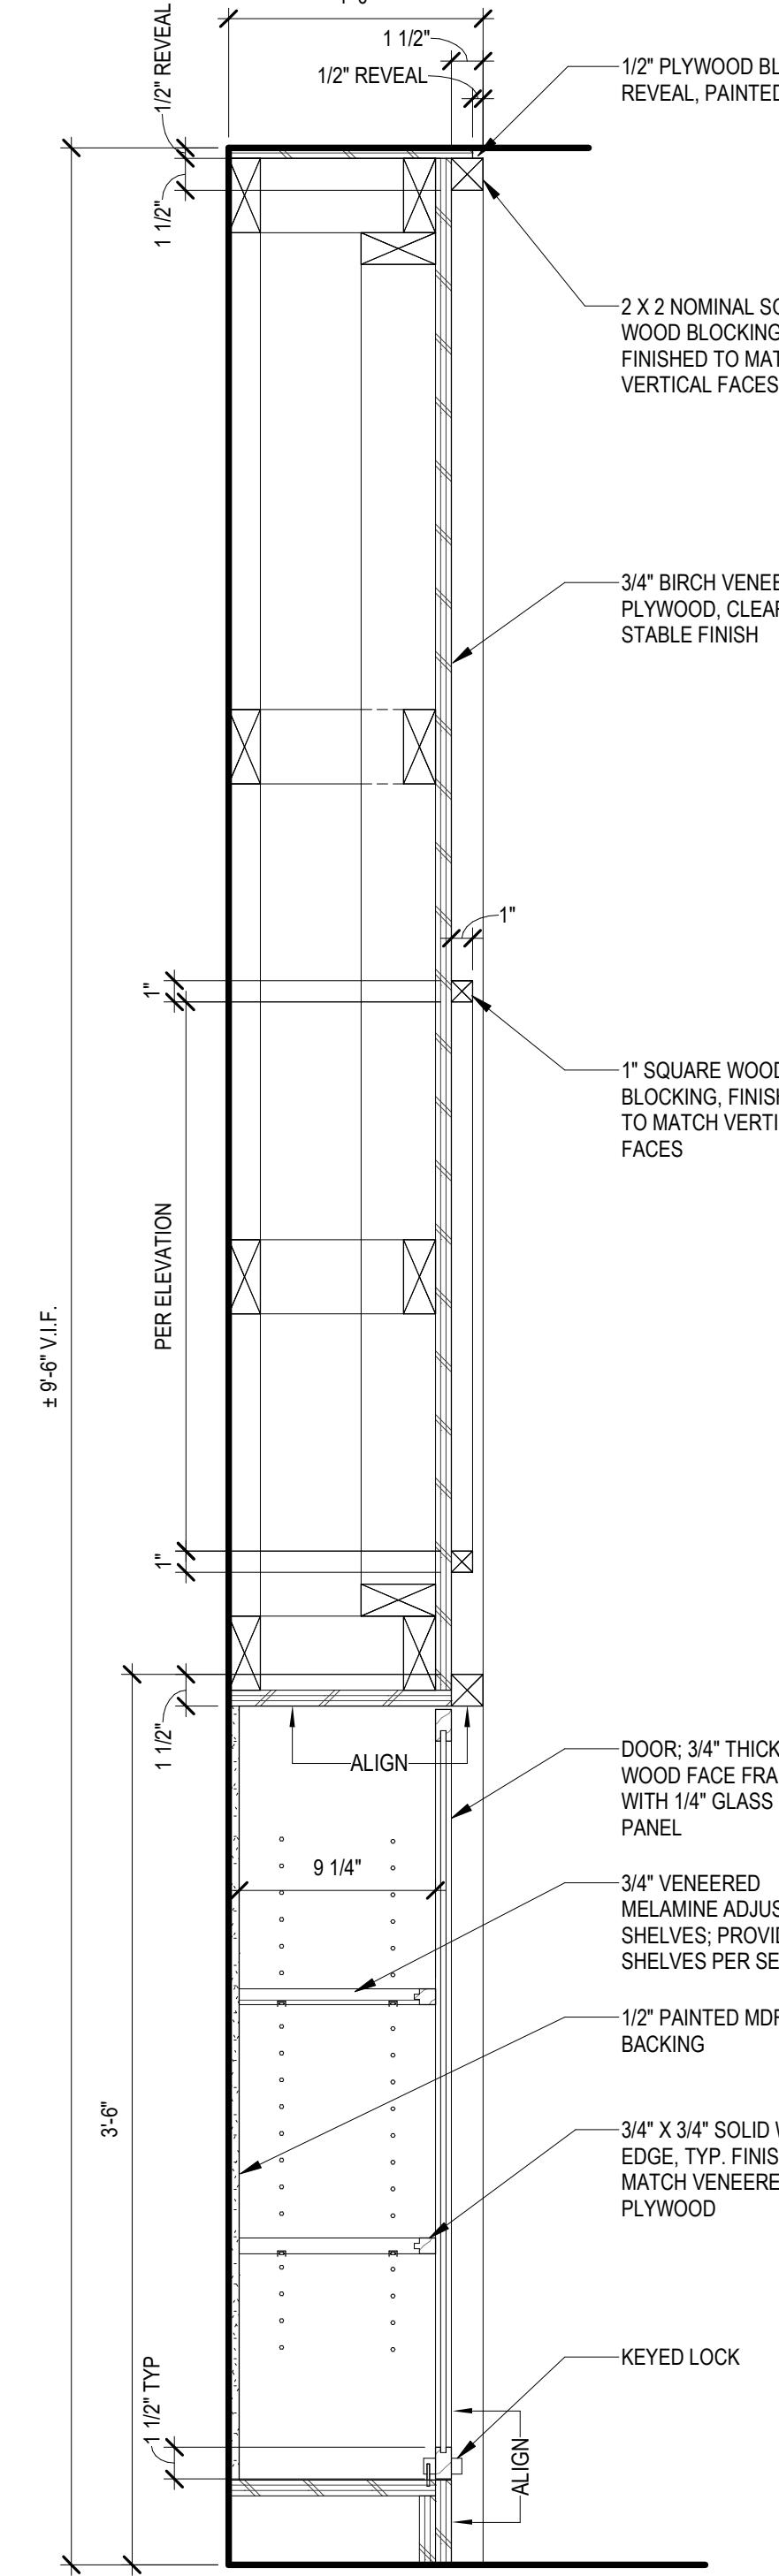


1 137 - EAST STORAGE, BELOW WINDOW

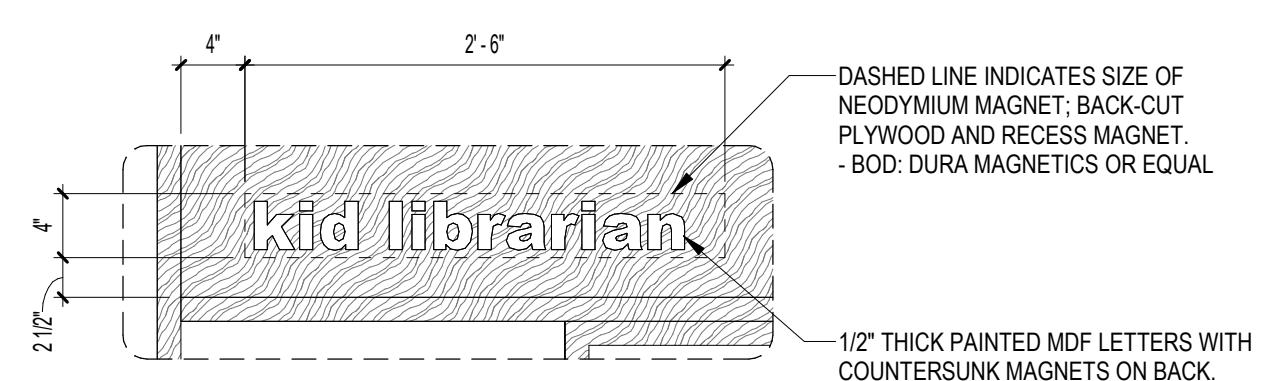

# 4 143 - KID LIBRARIAN - SIGNAGE DETAIL

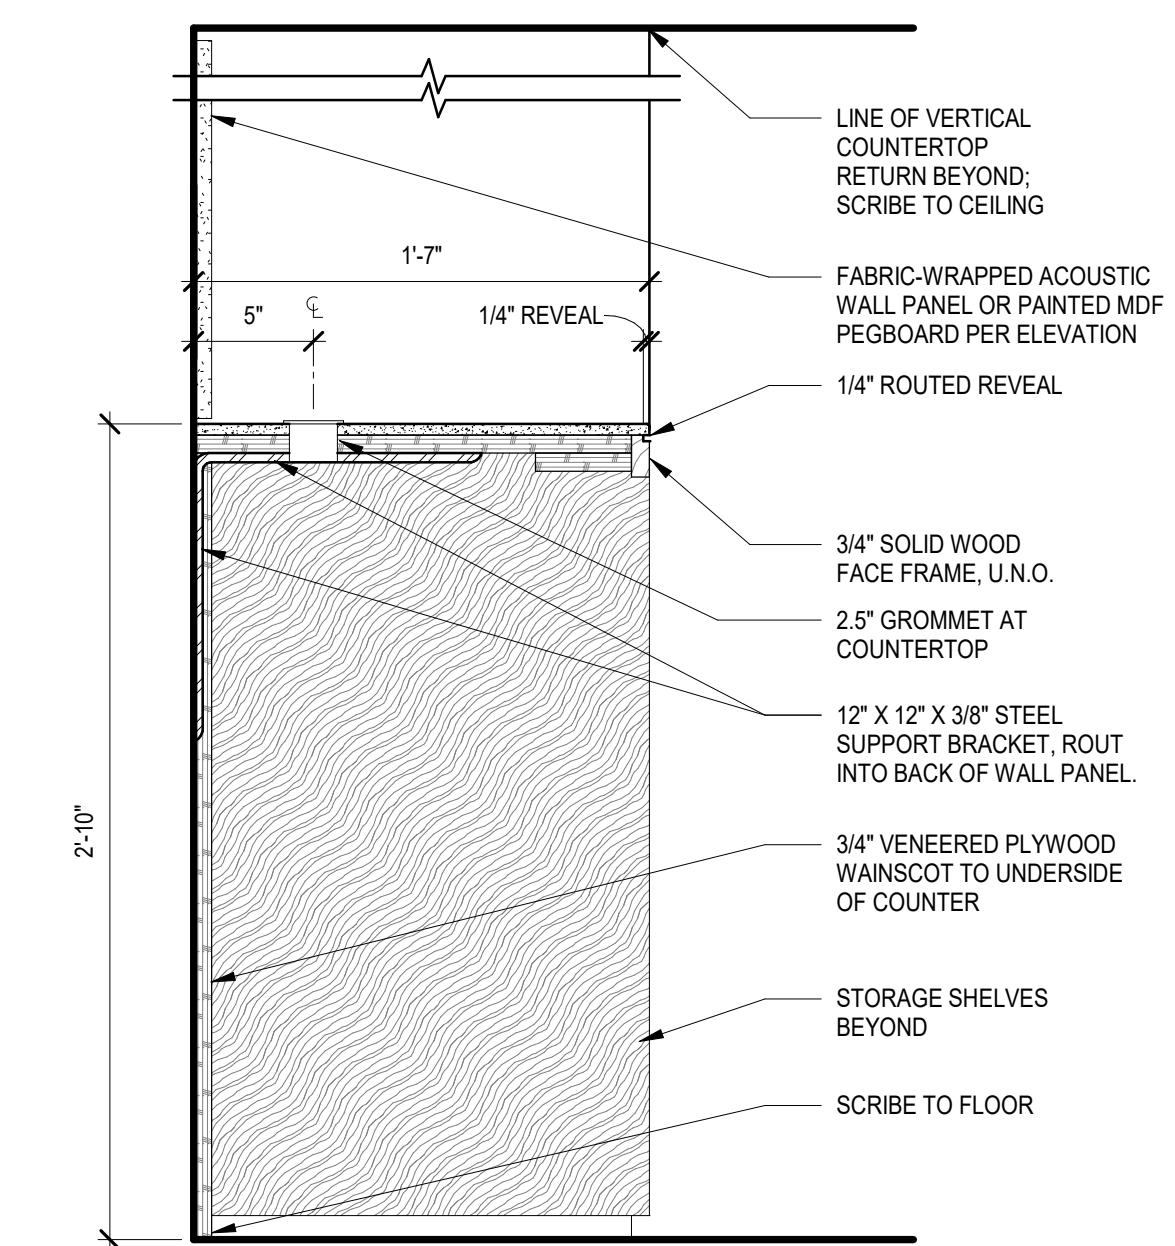

5 137 - WEST WALL OPEN COUNTER  
SCALE: 1 1/2" = 1'-0"

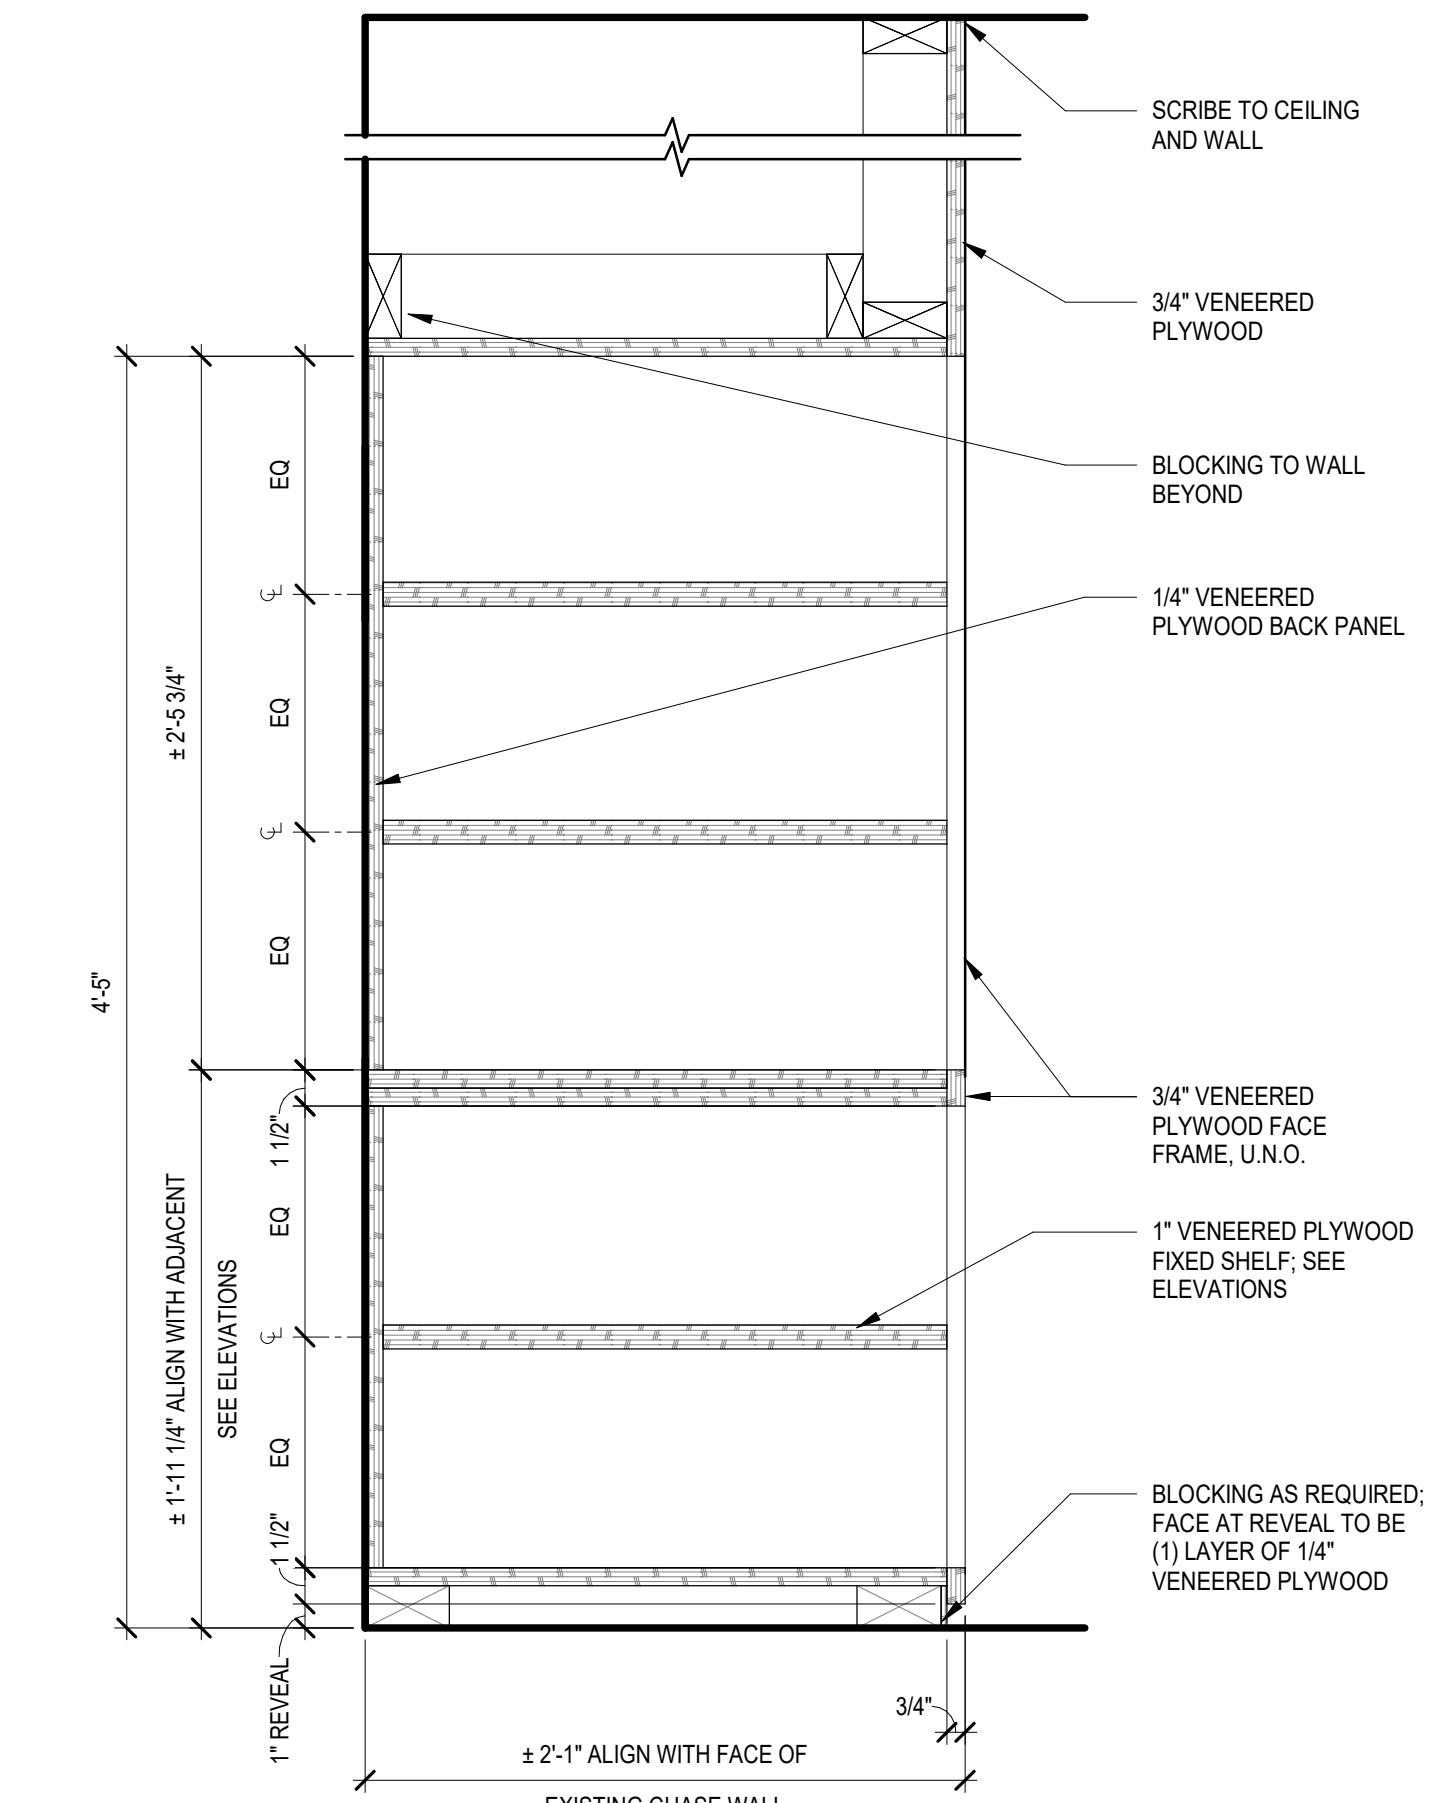

2 137 - EAST STORAGE, TALL SHELVES

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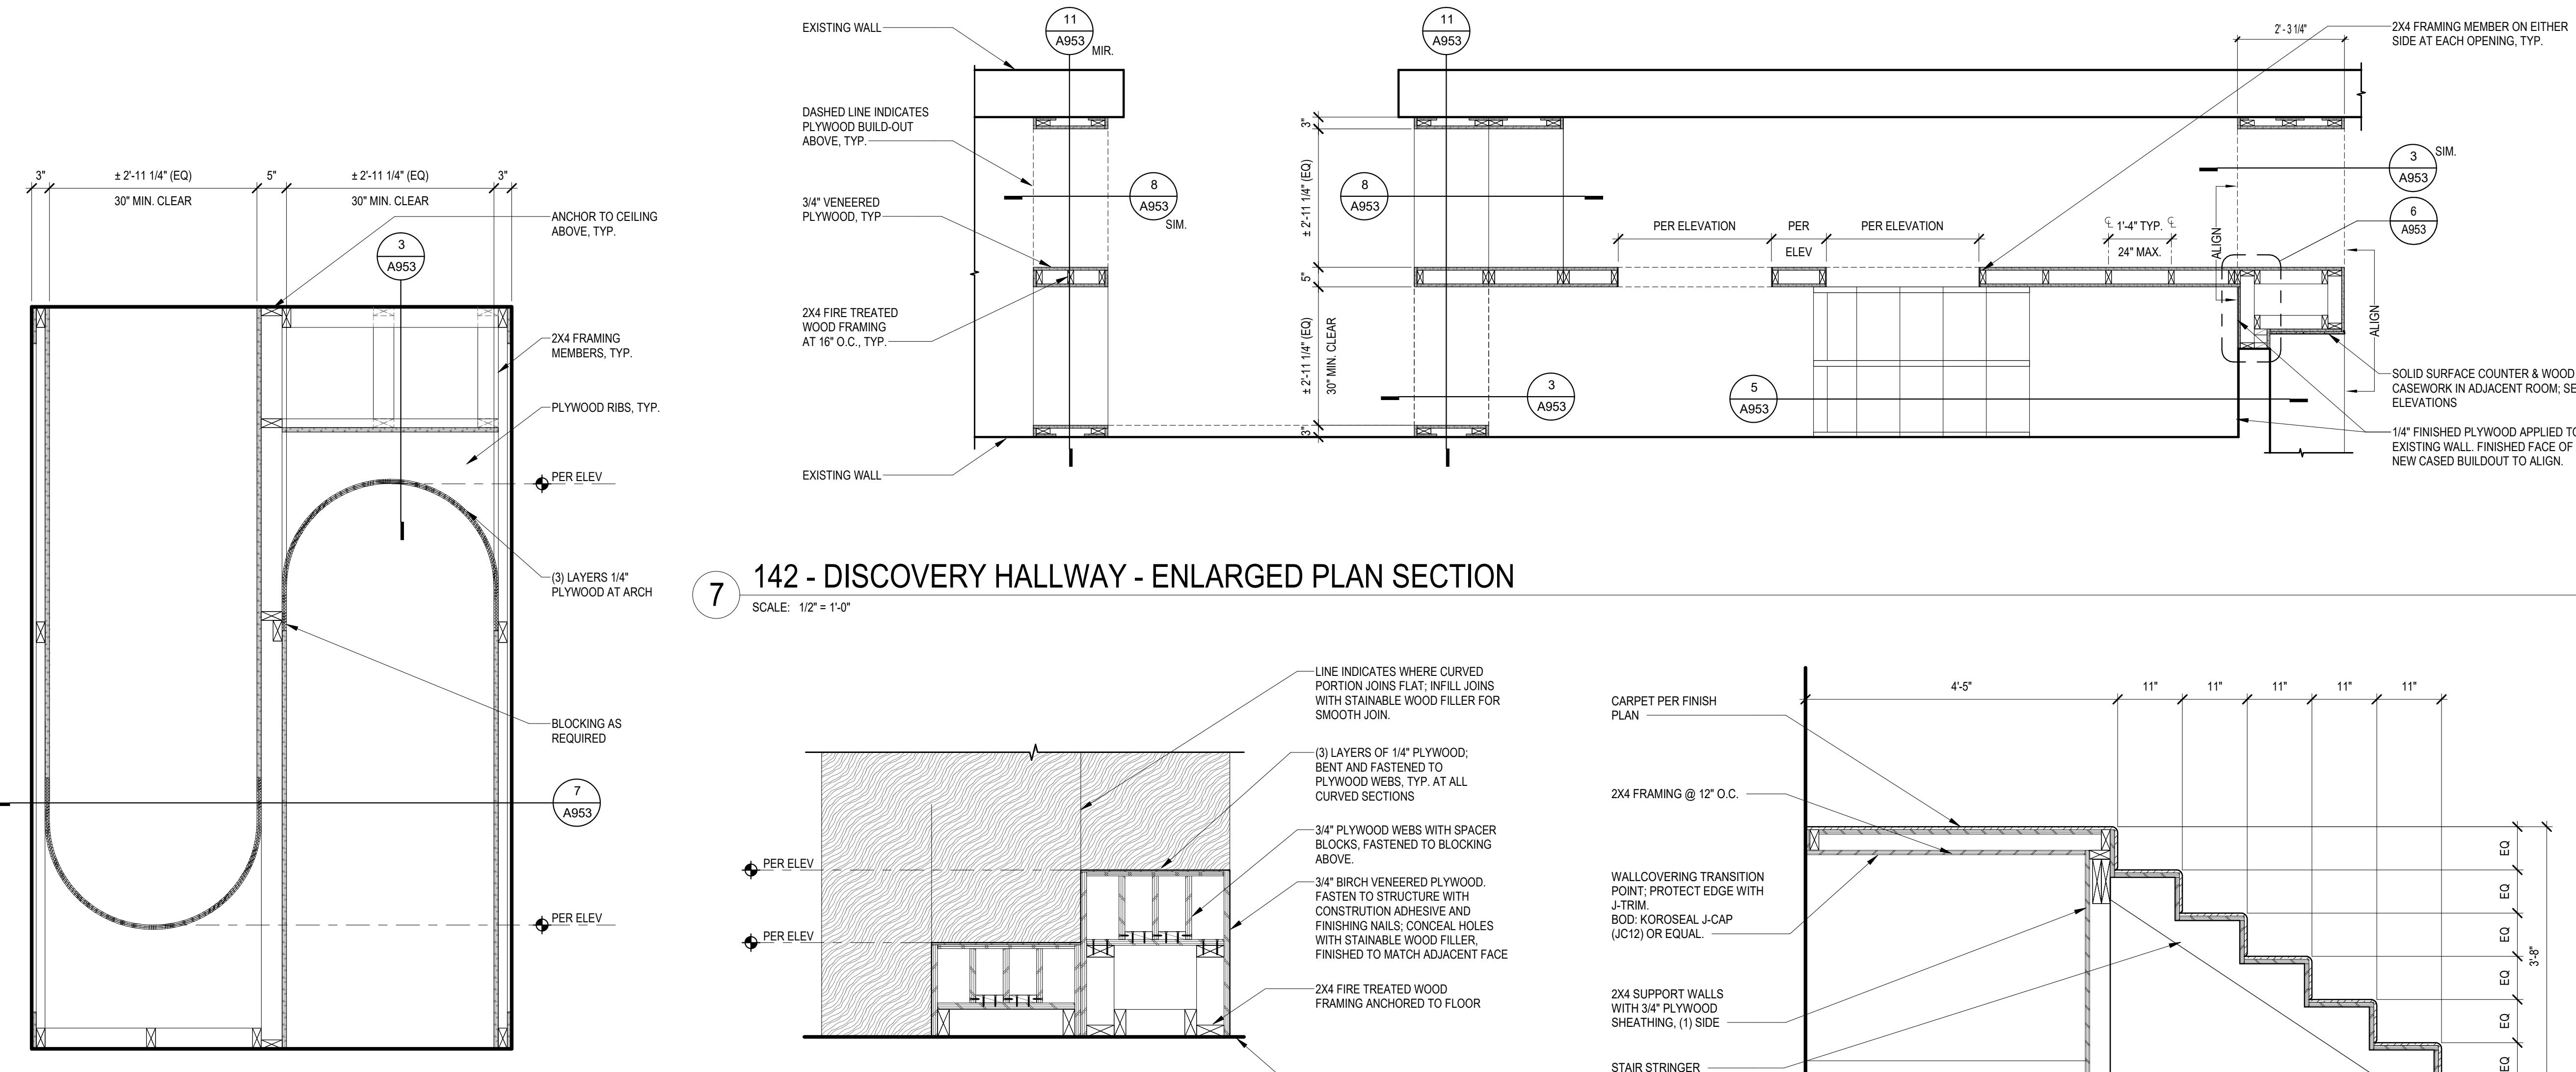
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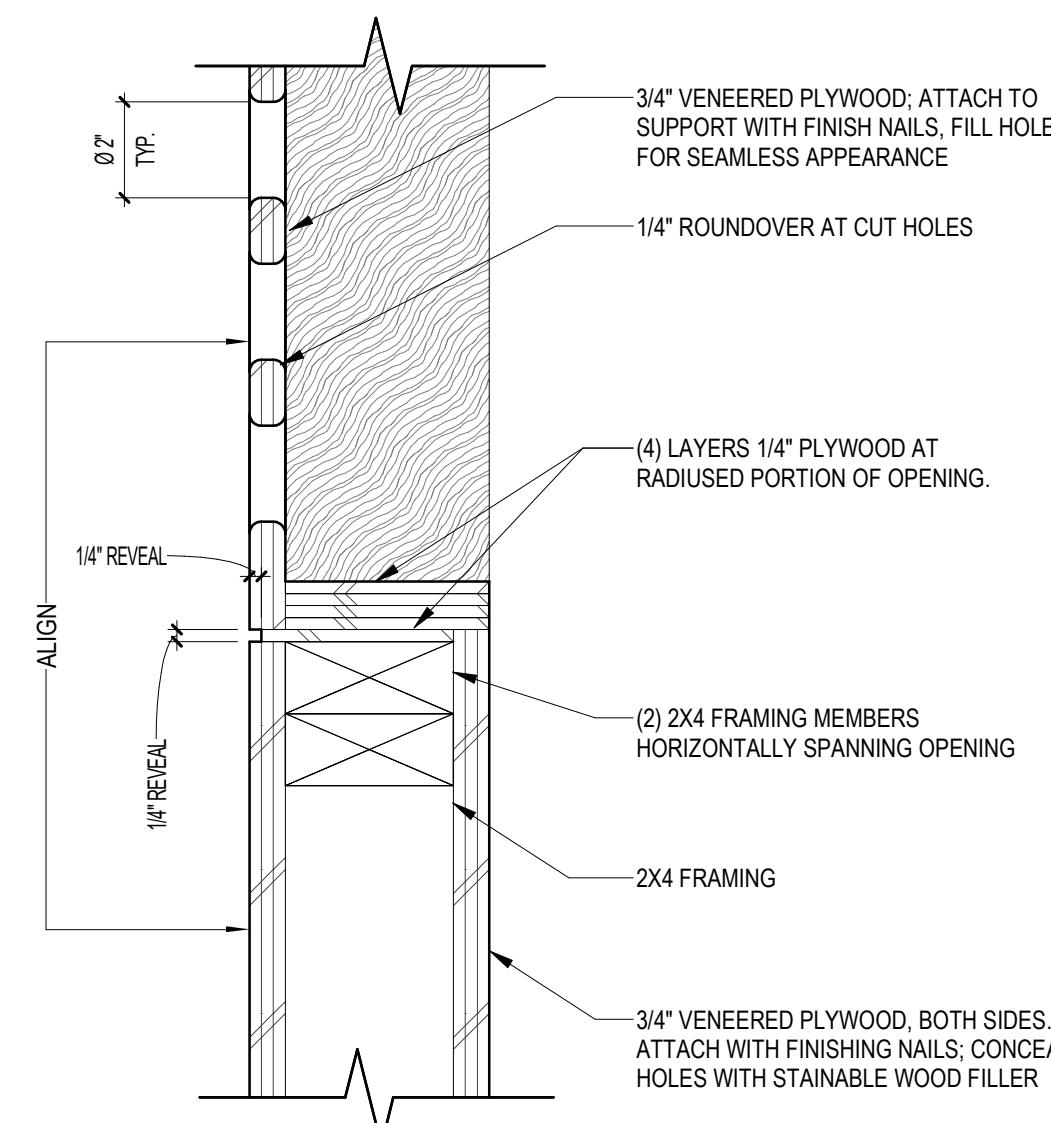
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INTERIOR DETAILS - DISCOVERY HALLWAY

SHEET NO.  
A953


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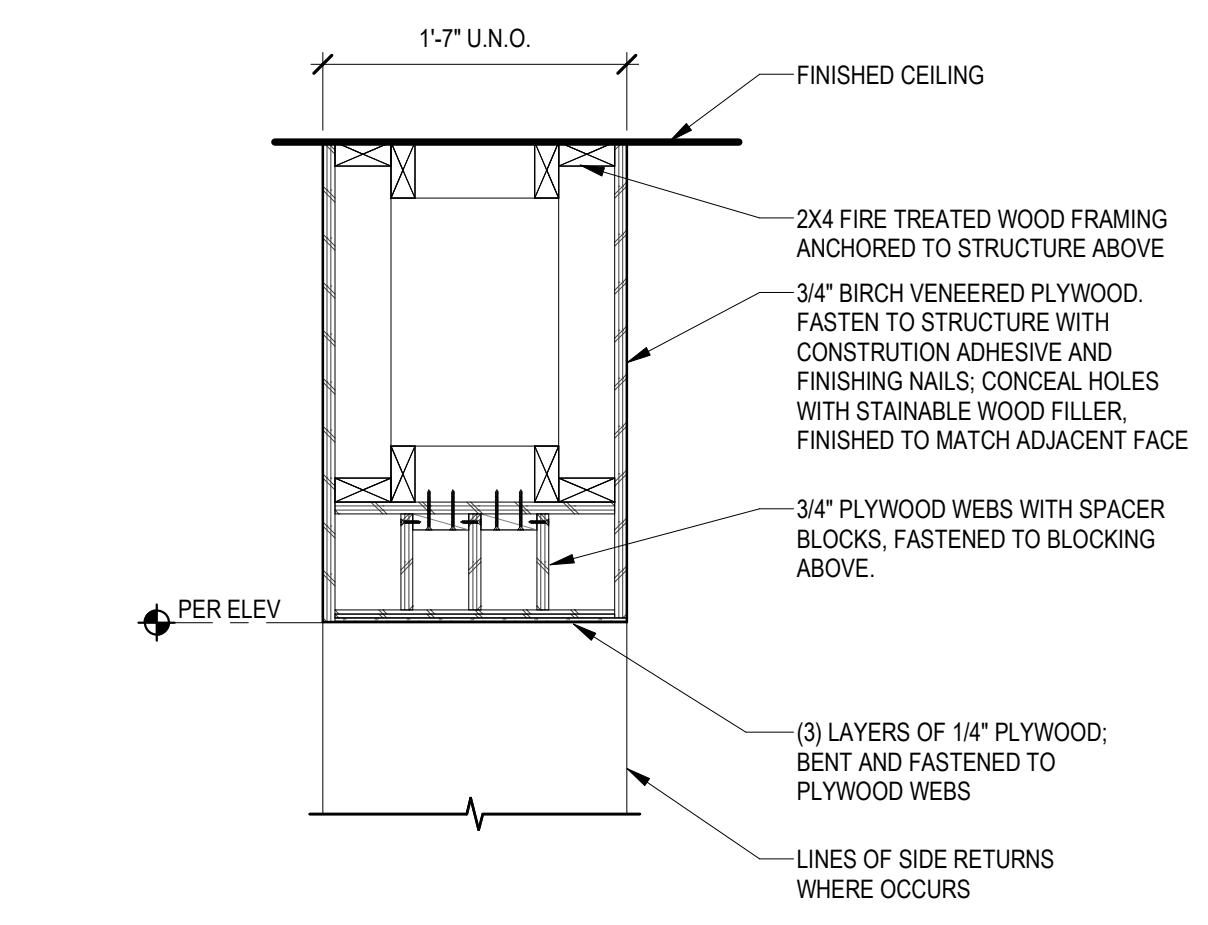
11 142 - FRAMING @ OPENINGS  
SCALE: 3/4" = 1'-0"



8 142 - SEATING ELEMENT  
SCALE: 1" = 1'-0"



142 - DISCOVERY HALLWAY - STAIR SECTION  
5  
SCALE: 3/4" = 1'-0"

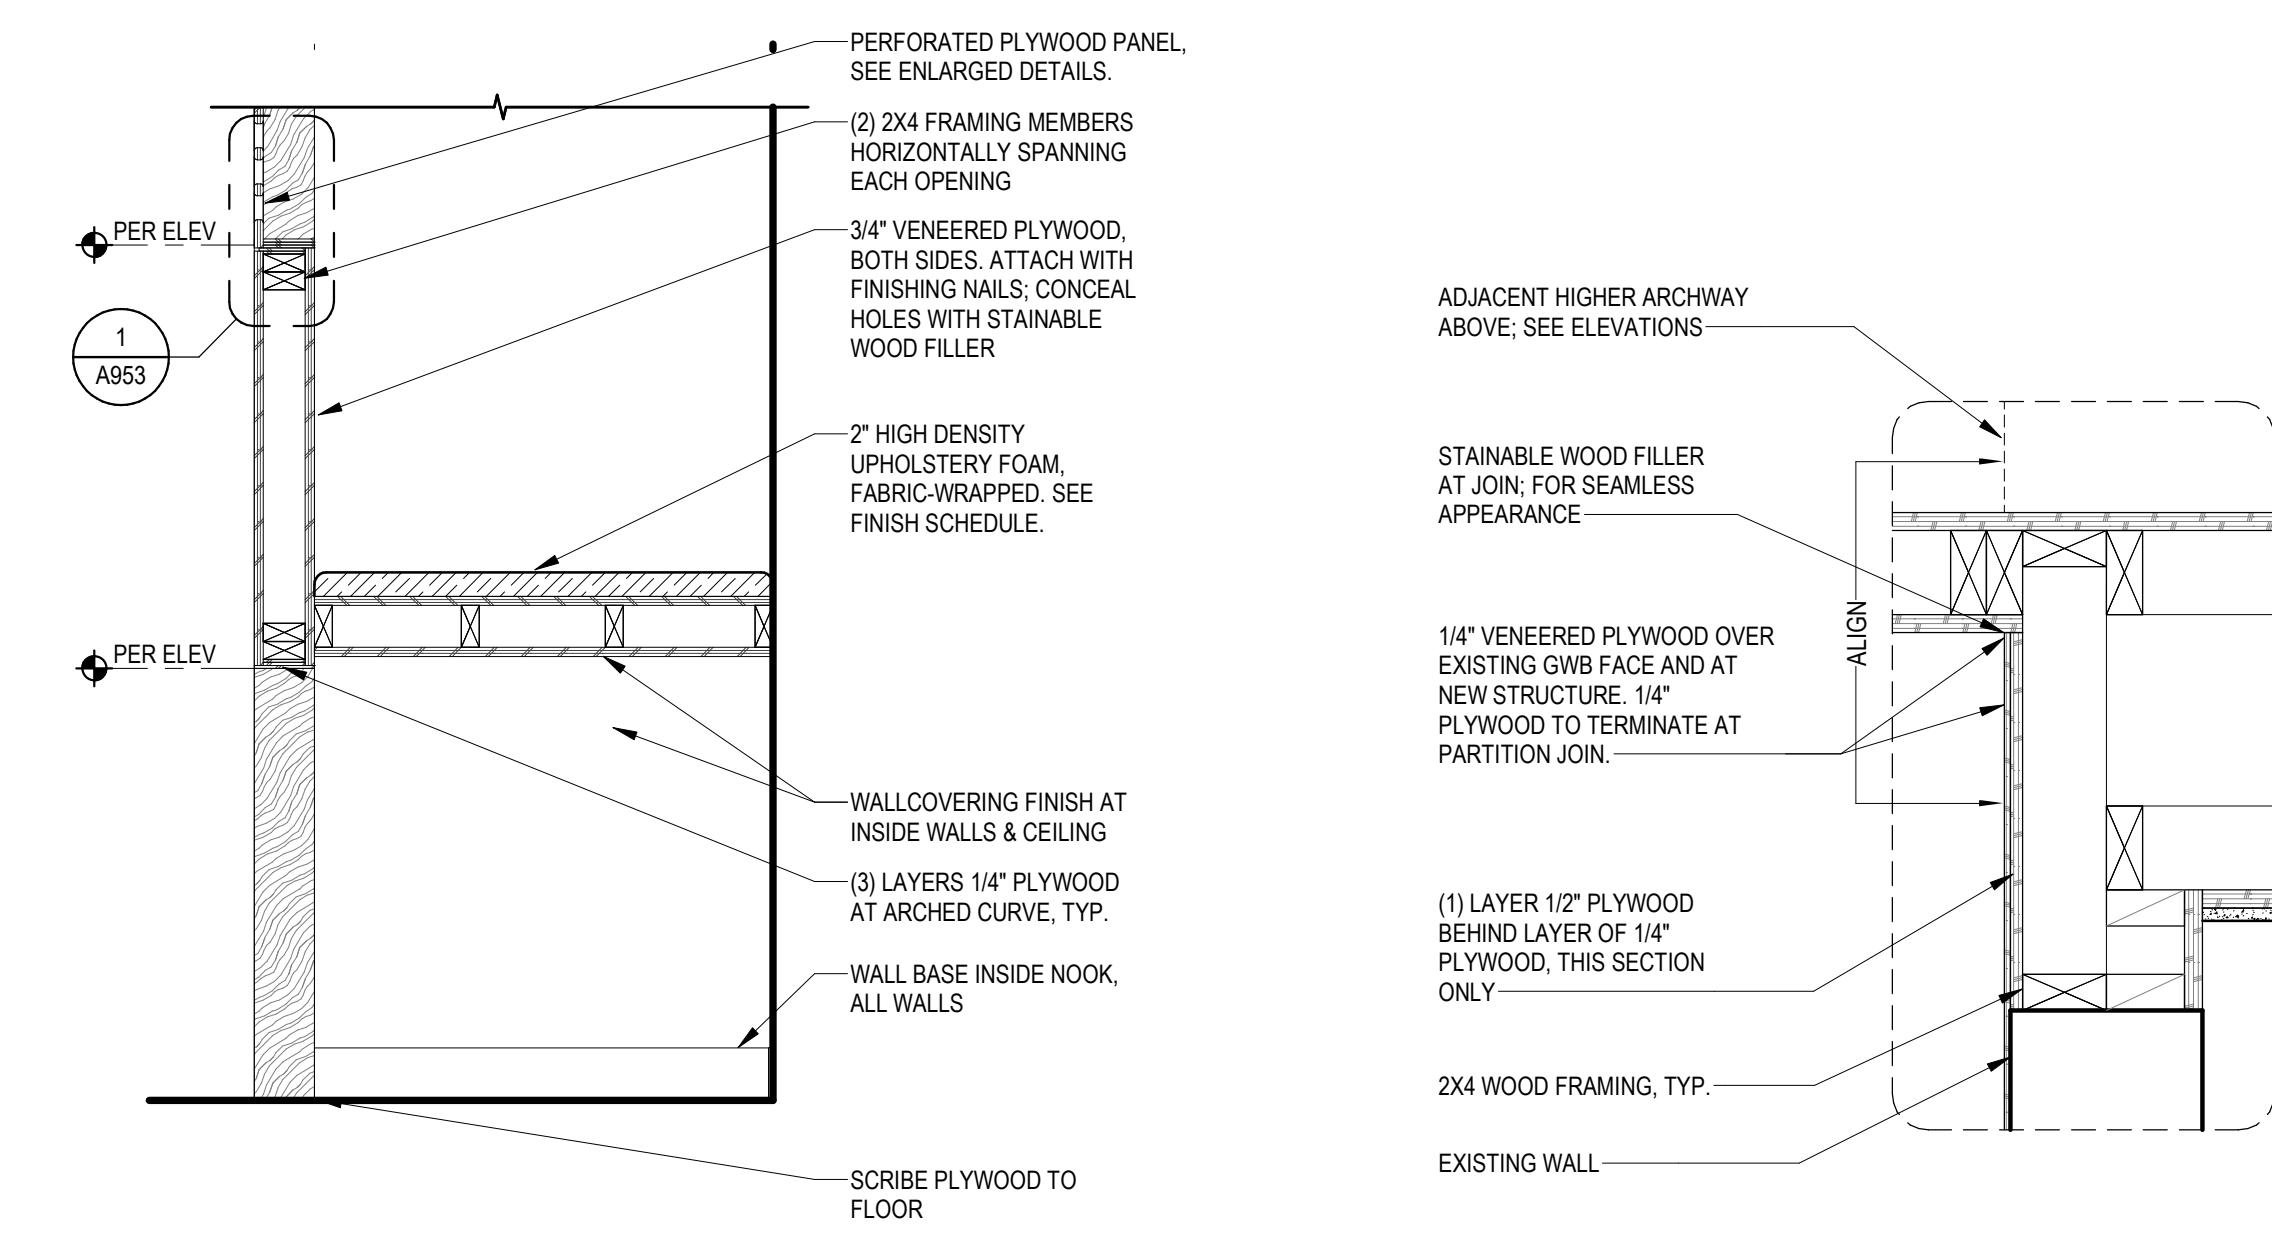

## ELECTRICAL SYMBOL LIST

NOTE: This is a standard symbol list and not all items listed may be used.

### Abbreviations

AFC	ABOVE FINISHED CEILING
AFF	ABOVE FINISHED FLOOR
ANSI	AMERICAN NATIONAL STANDARDS INSTITUTE
AWG	AMERICAN WIRE GAUGE
A	AMPERES, AMBER
AHJ	AUTHORITY HAVING JURISDICTION
AIC	AVAILABLE INTERRUPTING CAPACITY
BAS	BUILDING AUTOMATION SYSTEM
CA	CABLE
CAT	CATEGORY
CLG	CEILING
C	CONDUIT, CLOSE, CONTROL
COORD	COORDINATE
CU	COPPER
dB	DECIBEL
(X)	DEMOLISH
DTL	DETAIL
DIA	DIAMETER
DIM	DIMENSION
DIV	DIVISION
DN	DOWN
DWG	DRAWING
EA	EACH
EMT	ELECTRICAL METALLIC TUBING
EL	ELEVATION
E	EMERGENCY
EF	EXHAUST FAN
(E)	EXISTING
FF	FINISH FLOOR
FA	FIRE ALARM
FACP	FIRE ALARM CONTROL PANEL
FMC	FLEXIBLE METAL CONDUIT
FT	FOOT, FEET
FBO	FURNISHED BY OTHERS
G, GND	GROUND
GFCI	GROUND FAULT CIRCUIT INTERRUPTER
GFI	GROUND FAULT INTERRUPTER
GFP	GROUND FAULT PROTECTION
HH	HANDHOLE
HT	HEIGHT
ID	IDENTIFICATION
IN	INCH, INCHES
IEEE	INSTITUTE OF ELECTRICAL AND ELECTRONICS ENGINEERS
IMC	INTERMEDIATE METAL CONDUIT
IG	ISOLATED GROUND
KV	KILOVOLT
KVA	KILOVOLT AMPERES
KW	KILOWATT
LED	LIGHT EMITTING DIODE
LFMC	LIQUIDTIGHT FLEXIBLE METAL CONDUIT
LV	LOW VOLTAGE
MOPP	MAXIMUM OVERCURRENT PROTECTION
mA	MILLIAMPERES
MIN	MINIMUM
MCA	MINIMUM CIRCUIT AMPS
MISC	MISCELLANEOUS
MCC	MOTOR CONTROL CENTER
MT, MTD	MOUNT, MOUNTED
NEC	NATIONAL ELECTRIC CODE
NESC	NATIONAL ELECTRIC SAFETY CODE
NEMA	NATIONAL ELECTRICAL MANUFACTURERS ASSOCIATION
N	NEUTRAL
(N)	NEW
N/A	NOT APPLICABLE
N.I.C.	NOT IN CONTRACT
NTS	NOT TO SCALE
OC	ON CENTER
OFCI	OWNER FURNISHED, CONTRACTOR INSTALLED
PNL	PANEL
PH	PHASE
PVC	POLY-VINYL-CHLORIDE
PWR	POWER
QTY	QUANTITY
REF	REFERENCE
(R)	RELOCATE
RFI	REQUEST FOR INFORMATION
REQD	REQUIRED
RMC	RIGID METAL CONDUIT
RM	ROOM
SHT	SHEET
SIM	SIMILAR
STD	STANDARD
SPD	SURGE PROTECTION DEVICE
SWBD	SWITCHBOARD
TBD	TO BE DETERMINED
XFMR	TRANSFORMER
TVSS	TRANSIENT VOLTAGE SURGE SUPPRESSOR
TYP	TYPICAL
UG	UNDERGROUND
UL	UNDERWRITERS LABORATORIES
UPS	UNINTERRUPTIBLE POWER SUPPLY
UON	UNLESS OTHERWISE NOTED
VFD	VARIABLE FREQUENCY DRIVE
V	VOLTS, VOLTAGE
WP	WEATHERPROOF
WG	WIRE GUARD
W/	WITH
W/O	WITHOUT

### Connections / Equipment

	COMBINATION ADJUSTABLE FREQUENCY DRIVE WITH SAFETY DISCONNECT SWITCH, FURNISHED BY DIVISION 23 AND INSTALLED BY DIVISION 26.
	SURFACE MOUNTED 2' X 2' LUMINAIRE CONNECTED TO EMERGENCY/LIFE SAFETY CIRCUIT OR WITH INTEGRAL EMERGENCY BATTERY CONNECTED TO UNSWITCHED CIRCUIT
	SURFACE MOUNTED 2' X 4' LUMINAIRE
	SURFACE MOUNTED 2' X 4' LUMINAIRE CONNECTED TO EMERGENCY/LIFE SAFETY CIRCUIT OR WITH INTEGRAL EMERGENCY BATTERY CONNECTED TO UNSWITCHED CIRCUIT
	SURFACE OR PENDANT MOUNTED 1' X 4' LUMINAIRE
	SURFACE OR PENDANT MOUNTED 1' X 4' LUMINAIRE CONNECTED TO EMERGENCY/LIFE SAFETY CIRCUIT OR WITH INTEGRAL EMERGENCY BATTERY CONNECTED TO UNSWITCHED CIRCUIT
	SURFACE OR PENDANT MOUNTED STRIPLIGHT
	WALL MOUNTED 6" WIDE LUMINAIRE
	WALL MOUNTED 6" WIDE LUMINAIRE CONNECTED TO EMERGENCY/LIFE SAFETY CIRCUIT OR WITH INTEGRAL EMERGENCY BATTERY CONNECTED TO UNSWITCHED CIRCUIT
	WALL MOUNTED 12" WIDE LUMINAIRE
	WALL MOUNTED 12" WIDE LUMINAIRE CONNECTED TO EMERGENCY/LIFE SAFETY CIRCUIT OR WITH INTEGRAL EMERGENCY BATTERY CONNECTED TO UNSWITCHED CIRCUIT
	WALL MOUNTED LUMINAIRE
	WALL MOUNTED LUMINAIRE CONNECTED TO EMERGENCY/LIFE SAFETY CIRCUIT OR WITH INTEGRAL EMERGENCY BATTERY CONNECTED TO UNSWITCHED CIRCUIT
	FIRE ALARM CONTROL PANEL
	KEYED NOTE
	DEMOLISH
	EXISTING WORK
	NEW WORK
	COMBINATION EXIT SIGN CEILING MOUNTED AND DUAL HEAD EMERGENCY EGRESS LIGHTING WITH BATTERY PACK. ARROW(S) INDICATES DIRECTION IF SHOWN
	COMBINATION EXIT SIGN WALL MOUNTED AND DUAL HEAD EMERGENCY EGRESS LIGHTING WITH BATTERY PACK. ARROW(S) INDICATES DIRECTION IF SHOWN
	EXIT SIGN CEILING MOUNTED, ARROW(S) INDICATES DIRECTION IF SHOWN
	EXIT SIGN WALL MOUNTED, ARROW(S) INDICATES DIRECTION IF SHOWN
	RECESSED 1' X 4' LUMINAIRE
	RECESSED 1' X 4' LUMINAIRE CONNECTED TO EMERGENCY/LIFE SAFETY CIRCUIT OR WITH INTEGRAL EMERGENCY BATTERY CONNECTED TO UNSWITCHED CIRCUIT
	RECESSED 2' X 2' LUMINAIRE
	RECESSED 2' X 2' LUMINAIRE CONNECTED TO EMERGENCY/LIFE SAFETY CIRCUIT OR WITH INTEGRAL EMERGENCY BATTERY CONNECTED TO UNSWITCHED CIRCUIT
	RECESSED 2' X 4' LUMINAIRE
	RECESSED 2' X 4' LUMINAIRE CONNECTED TO EMERGENCY/LIFE SAFETY CIRCUIT OR WITH INTEGRAL EMERGENCY BATTERY CONNECTED TO UNSWITCHED CIRCUIT
	RECESSED LUMINAIRE
	RECESSED LUMINAIRE CONNECTED TO EMERGENCY/LIFE SAFETY CIRCUIT
	CONDUIT CONCEALED IN WALL OR CEILING SPACE
	CONDUIT ROUTED BELOW FLOOR / GRADE
	CONDUIT ELED DOWN
	CONDUIT ELED UP
	CONDUIT/WIRING CONTINUATION

### GENERAL ELECTRICAL NOTES

- A. ALL ELECTRICAL MATERIAL AND INSTALLATIONS SHOWN AND/OR SPECIFIED TO BE INSTALLED PER THE MANUFACTURER'S RECOMMENDATIONS AND IN ACCORDANCE WITH THE LATEST EDITION OF THE NEC 2023.
- B. REFER TO ARCHITECTURAL DRAWINGS TO COORDINATE LOCATION AND MOUNTING HEIGHT OF ALL ELECTRICAL DEVICES.
- C. REFER TO MECHANICAL AND PLUMBING DRAWINGS FOR EXACT LOCATION OF ALL MECHANICAL AND PLUMBING EQUIPMENT.
- D. MAXIMUM VOLTAGE DROP OF BRANCH CIRCUITS TO BE 3%. ELECTRICAL CONTRACTOR TO SIZE WIRING TO SUIT.
- E. NO WIRE SMALLER THAN #12 AWG SHALL BE USED FOR BRANCH CIRCUIT WIRING.
- F. IN FINISHED INTERIOR AREAS RUN ALL CONDUITS CONCEALED UNLESS OTHERWISE NOTED. PAINT ALL EXPOSED CONDUITS AND ELECTRICAL EQUIPMENT. REFER TO ARCHITECTURAL PAINTING SPECIFICATIONS FOR REQUIREMENTS.
- G. ALL EXPOSED CONDUIT TO BE RUN PARALLEL TO BUILDING LINES.
- H. PROVIDE DEDICATED NEUTRALS FOR ALL BRANCH CIRCUITS UNLESS OTHERWISE NOTED.
- I. ALL IN-SLAB OR BURIED CONDUIT TO BE COMPLETE WITH EQUIPMENT GROUNDING CONDUCTOR.
- J. ALL EMPTY CONDUITS TO BE COMPLETE WITH PULL WIRE.
- K. MC CABLE SHALL NOT BE USED WITHOUT PERMISSION FROM THE ENGINEER.
- L. ALL CONDUIT ROUTED IN AREAS SUBJECT TO MECHANICAL DAMAGE TO BE RIGID.

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**SYMBOL LIST AND GENERAL NOTES - ELECTRICAL**

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### SHEET INDEX

E000	SYMBOL LIST AND GENERAL NOTES - ELECTRICAL
E001	LUMINAIRE SCHEDULE - LIGHTING
E201	LEVEL 1 DEMOLITION PLAN - LIGHTING
E202	LEVEL 1 DEMOLITION PLAN - POWER
E301	LEVEL 1 CEILING PLAN - LIGHTING
E401	LEVEL 1 FLOOR PLAN - POWER
E451	LEVEL 1 ENLARGED PLAN - CHILDREN'S LIBRARY - POWER
E452	LEVEL 1 ENLARGED PLAN - NON-FICTION - POWER
E501	SINGLE LINE DIAGRAMS - ELECTRICAL
E601	SCHEDULES - ELECTRICAL
E701	DETAILS - ELECTRICAL

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TYPE	DESCRIPTION	HOUSING	OPTICS	MOUNTING	FINISH	UL/IP RATING	DRIVER LOCATION	DIMMING CONTROL	INITIAL DELIVERED LUMENS	CCT	CRI	RATED LIFE	LM/W	WATTAGE	VOLTAGE	MANUFACTURER	PRE-APPROVED PRODUCTS		REMARKS
																	SSZSF-Y120-2-8-NI+DSO400-NE-90-35-W-UNV-MD-1-C	A(18)-RC-LEM	
'C'	SUSPENDED PENDANT MOUNT LED LUMINAIRE; 4'-0" DIA x 8" H NOMINAL DIMENSIONS	ACOUSTIC POLYESTER	EXTRUDED ACRYLIC LENS	SUSPENDED 7'-6" A.F.F.	LEMON PET	DRY	INTEGRAL	0-10V; 1%	2400	3500K	90	50,000 (L80)	100	24.0	120	AXIS SPATIAL SOFTZONE	A(18)-RC-LEM		
'C-EM'	SUSPENDED PENDANT MOUNT LED LUMINAIRE; 4'-0" DIA x 8" H NOMINAL DIMENSIONS	ACOUSTIC POLYESTER	EXTRUDED ACRYLIC LENS	SUSPENDED 7'-6" A.F.F.	LEMON PET	DRY	INTEGRAL	0-10V; 1%	2400	3500K	90	50,000 (L80)	100	24.0	120	AXIS SPATIAL SOFTZONE	A(18)-RC-LEM	PROVIDE BATTERY BACKUP	
'D'	RECESSED LED DOWNLIGHT; 3.75" DIA x 4.5" H NOMINAL DIMENSIONS	ALUMINUM	CLEAR POLYCARBONATE	RECESSED; CONFIRM CEILING TYPE PRIOR TO ORDER; REFER TO ARCHITECTURAL DRAWINGS FOR DIMENSIONED LOCATIONS	WHITE	DAMP	INTEGRAL	0-10V; 1%	1300	3000K	95	225,000 (L70)	135	11.0	120	LUMENPULSE LUMENCORE	LCRS-EZ-A-FD-120-R-L13-35K-95-WFR-DA1-SB-MWH-R		
'D-EM'	RECESSED LED DOWNLIGHT; 3.75" DIA x 4.5" H NOMINAL DIMENSIONS	ALUMINUM	CLEAR POLYCARBONATE	RECESSED; CONFIRM CEILING TYPE PRIOR TO ORDER; REFER TO ARCHITECTURAL DRAWINGS FOR DIMENSIONED LOCATIONS	WHITE	DAMP	INTEGRAL	0-10V; 1%	1300	3000K	95	225,000 (L70)	135	11.0	120	LUMENPULSE LUMENCORE	LCRS-EZ-A-FD-120-R-L13-35K-95-WFR-DA1-SB-MWH-R	PROVIDE BATTERY BACKUP	
'F'	CEILING MOUNTED FIBER OPTIC STAR FIELD INSTALLATION; TOTAL SURFACE AREA OF LUMINAIRE INSTALLATION 4'-1" W x 2'-6 1/2" H	FIBER OPTIC CABLE	N/A	CEILING MOUNTED, SEE DETAIL 2/A610 FOR MORE INFORMATION	N/A	DRY	REMOTE	N/A	N/A	3000K	90	N/A	N/A	42.0	120	VLT	GALAXY SERIES		
'H'	SURFACE LED HEX LUMINAIRE; 27.3125" W x 28.625" L x 2.5" H NOMINAL DIMENSIONS	ALUMINUM	OPAL LENS	SURFACE	WHITE	DAMP	INTEGRAL	0-10V; 1%	5000	3000K	90	N/A	96	53.0	120	BASO HEX	HEX-SUR-WH-OP-35K-C90-UNV-010V-05000L-DM-2FT		
'H.1'	SURFACE ACOUSTIC HEX PANEL; 27.3125" W x 28.625" L x 2.5" H NOMINAL DIMENSIONS	ALUMINUM	N/A	SURFACE	WHITE; ARCH TO CONFIRM ACOUSTIC PANEL FINISH	N/A	N/A	N/A	N/A	N/A	N/A	N/A	N/A	0.0	120	BASO HEX	HEX-ACO-LI-SUR-WH-TBD-DM-2FT		
'I.1'	SUSPENDED ACOUSTIC DOWNLIGHT LED LUMINAIRE; 35" DIA x 2" H NOMINAL DIMENSIONS	>60% RECYCLED PET	EXTRUDED ACRYLIC LENS	SUSPENDED SUCH THAT THE BOTTOM OF THE FIXTURE IS 8'-0" A.F.F.	FELT: MERCURY; CORD: BLACK	DAMP	INTEGRAL	0-10V; 1%	1971	3000K	90	60,000 (L70)	82.1	24.5	120	SABIN DISC	L-YR-D-L-DL-35"-D2000-DGA-LRW-CEN-935K-SC-10-UNV	-15MY-PCBK-ACBLK-RWH	
'I.2'	SUSPENDED ACOUSTIC DOWNLIGHT LED LUMINAIRE; 31" X 15" W X 2" H NOMINAL DIMENSIONS	>60% RECYCLED PET	EXTRUDED ACRYLIC LENS	SUSPENDED SUCH THAT THE BOTTOM OF THE FIXTURE IS 8'-0" A.F.F.	FELT: GULF; CORD: BLACK	DAMP	INTEGRAL	0-10V; 1%	1971	3000K	90	60,000 (L70)	82.1	24.5	120	SABIN OROUND	L-YR-O-L-DL-31" X 15"-D2000-DGA-LRW-CEN-935K-SC-10-UNV-15GF-PCBK	-ACBLK-RWH	
'I.3'	SUSPENDED ACOUSTIC DOWNLIGHT LED LUMINAIRE; 47" DIA X 2" H NOMINAL DIMENSIONS	>60% RECYCLED PET	EXTRUDED ACRYLIC LENS	SUSPENDED SUCH THAT THE BOTTOM OF THE FIXTURE IS 8'-0" A.F.F.	FELT: MERCURY; CORD: BLACK	DAMP	INTEGRAL	0-10V; 1%	1971	3000K	90	60,000 (L70)	82.1	24.5	120	SABIN DISC	L-YR-D-L-DL-47"-D2000-DGA-LRW-CEN-935K-SC-10-UNV	-15MY-PCBK-ACBLK-RWH	
'I.4'	SUSPENDED ACOUSTIC DOWNLIGHT LED LUMINAIRE; 63" X 23" W X 2" H NOMINAL DIMENSIONS	>60% RECYCLED PET	EXTRUDED ACRYLIC LENS	SUSPENDED SUCH THAT THE BOTTOM OF THE FIXTURE IS 8'-0" A.F.F.	FELT: GULF; CORD: BLACK	DAMP	INTEGRAL	0-10V; 1%	1971	3000K	90	60,000 (L70)	82.1	24.5	120	SABIN OROUND	L-YR-O-L-DL-63" X 23"-D2000-DGA-LRW-CEN-935K-SC-10-UNV-15GF-PCBK	-ACBLK-RWH	

## NOTES

- 1 THIS LUMINAIRE SCHEDULE IS NOT COMPLETE WITHOUT A COPY OF THE PROJECT MANUAL CONTAINING THE ELECTRICAL SPECIFICATIONS.
- 2 DIMMING CONTROL PROTOCOL (0-10VDC, LINE VOLTAGE, DALI, ETC.) COMPATIBLE WITH LIGHTING CONTROL SYSTEM AS SPECIFIED AND SHOWN ON DRAWINGS.
- 3 PROVIDE +/- 12 INCH ADJUSTABILITY IN AIRCRAFT CABLE LENGTH WHERE USED.
- 4 COORDINATE ALL CEILING TYPES WITH LUMINAIRE LOCATIONS PRIOR TO ORDERING LUMINAIRES. COORDINATE INSTALLATION WITH REFLECTED CEILING PLAN.
- 5 SPECIFIED MANUFACTURERS ARE BASIS OF DESIGN. SUBMIT ALTERNATES FOR APPROVAL PRIOR TO BID CLOSE.
- 6 PROVIDE SUBMITTALS THAT INCLUDE THE LUMINAIRE, LAMP AND DRIVER INFORMATION OF EACH LUMINAIRE, WITH APPLICABLE OPTIONS CLEARLY CHECKED OR HIGHLIGHTED. SUBMITTALS NOT INCLUDING THIS INFORMATION WILL BE RETURNED AS REJECTED BY THE ENGINEER OF RECORD.
- 7 REMOTE BALLASTS/DRIVERS: UL LISTED FOR THEIR APPLICATION. BALLASTS/DRIVERS MARKED AS UL RECOGNIZED COMPONENT BUT NOT UL LISTED ARE SUBJECT TO REMOVAL AND REPLACEMENT AT NO COST TO OWNER.
- 8 LABEL ALL REMOTE DRIVERS TO SHOW LUMINAIRE TYPE IDENTIFICATION AND SOURCE CIRCUIT. PROVIDE WIRING BETWEEN REMOTE DRIVER AND LUMINAIRE AS RECOMMENDED BY MANUFACTURER. DO NOT EXCEED MAXIMUM DISTANCE RECOMMENDED BY MANUFACTURER BETWEEN DRIVER AND FURTHEST LUMINAIRE.


LED REPLACEMENT MATRIX: BASIS OF DESIGN	
LUMINAIRE TYPE	LAMPS
FD26/FD26E	1 GREEN CREATIVE: 9PLO/8CCTS/HYB/PF
PH3	4 GREEN CREATIVE
	EXISTING LAMPS TO BE REPLACED
	CFL 26W 4P OR 2P -GC Offers Pin Fit Technology
	26W DTT CFL

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ROOM NAME	OCC. SENSOR TYPE	LOCAL CONTROL	PHOTOCELL (Y/N)	PLUGLOAD CONTROL (Y/N)	UL 924 RELAY	NETWORKED (Y/N)	CONTROL FUNCTION		NOTES
							MANUAL ON WITH WALL DIMMER. INCORPORATE MANUAL DIMMING CONTROL TO OFF. AUTOMATIC CONTINUOUS DIMMING IN PRIMARY AND SECONDARY DAYLIGHT ZONES. AUTO OFF AFTER 10 MINUTES OF UNOCCUPANCY		
DISCOVERY HALLWAY	CEILING MOUNTED DUAL TECHNOLOGY OCCUPANCY SENSOR	LOW VOLTAGE DIMMING SWITCHES	N	N	Y	N			
HOLDS	N/A	EXISTING LOCAL CONTROL	N	N	Y	N	EXISTING LIGHTING CONTROLS	<20% LIGHTING TO BE REPLACED	
EARLY LEARNING	CEILING MOUNTED DUAL TECHNOLOGY VACANCY SENSOR	LOW VOLTAGE DIMMING SWITCHES	N	N	Y	N	MANUAL ON, AUTO OFF WITHIN 10 MINUTES OF UNOCCUPANCY. INCORPORATE MANUAL DIMMING CONTROL TO OFF. AUTO DIMMING FOR DAYLIGHT ZONES		
INDIVIDUAL EXPLORATION	CEILING MOUNTED DUAL TECHNOLOGY VACANCY SENSOR	LOW VOLTAGE DIMMING SWITCHES	N	N	Y	N	MANUAL ON, AUTO OFF WITHIN 10 MINUTES OF UNOCCUPANCY. INCORPORATE MANUAL DIMMING CONTROL TO OFF. AUTO DIMMING FOR DAYLIGHT ZONES		
CHILDREN'S LIBRARY	N/A	EXISTING LOCAL CONTROL	N	N	Y	N	EXISTING LIGHTING CONTROLS	C503.7.3 N/A	
ALL OTHER ROOMS	CEILING MOUNTED DUAL TECHNOLOGY VACANCY SENSOR	LOW VOLTAGE DIMMING SWITCHES	N	N	Y	N	MANUAL ON, AUTO OFF WITHIN 10 MINUTES OF UNOCCUPANCY. INCORPORATE MANUAL DIMMING CONTROL TO OFF. WHEN BLDG ARMS, LIGHTS TURN OFF.		

## GENERAL NOTES:

- 1 PROVIDE ALL COMPONENTS REQUIRED FOR A FULLY FUNCTION LIGHTING CONTROL SYSTEM TO MEET FUNCTIONALITY LISTED ABOVE.
- 2 PROVIDE LOW VOLTAGE LIGHTING CONTROL, UNLESS OTHERWISE NOTED.
- 3 LIGHTING SYSTEM TESTING: SCOPE OF WORK INCLUDES BOTH INITIAL PROGRAMMING OF DEVICES BASED ON THIS SCHEDULE AND/OR SPECIFICATIONS, TESTING OF CONTROLS, AND ADJUSTING OF PROGRAMMED SETPOINTS BASED ON OWNER FEEDBACK AT SUBSTANTIAL COMPLETION. FINAL CALIBRATION OF ALL SENSOR AND DIMMING SETTINGS TO OCCUR AFTER FURNITURE AND FINAL FINISHES HAVE BEEN INSTALLED.
- 4 COORDINATE PHOTOCELL RATINGS AND MOUNTING HEIGHTS. SENSORS SHALL BE CAPABLE OF DETECTING DESIGNED FOOT-CANDLE LEVELS PER IESNA RECOMMENDATIONS.
- 5 COORDINATE FINAL TIME AND LIGHT LEVEL SETTINGS WITH OWNER.
- 6 LUMINAIRES WITHIN DESIGNATED DAYLIGHT HARVESTING ZONES SHALL BE DIMMED BY AT LEAST 65% WHEN DAYLIGHT SENSORS READ AT LEAST 150% OF DESIGN ILLUMINANCE.
- 7 FOR ALL SPACES WITH DAYLIGHT HARVESTING, DIMMING CONTROLS, ILLUMINATION DURING NIGHT TIME SHALL BE ADJUSTED TO BE GREATER THAN OR EQUAL TO 20% LOWER THAN THE DAYTIME LIGHT LEVEL DESIGN GUIDE FOOT-CANDLE LEVELS PER IESNA RECOMMENDATIONS.
- 8 CONFIRM SCENE SETTINGS, TIMECLOCK CONTROLS, AND OPTIONS WITH OWNER PRIOR TO SUBMITTAL.
- 9 LIGHTING CONTROLS TO COMPLY WITH WSEC 2021.
- 10 IF FIRE ALARM OR INTRUSION ALARM OCCURS ALL LIGHTS OPERATE IN NORMAL FUNCTION.

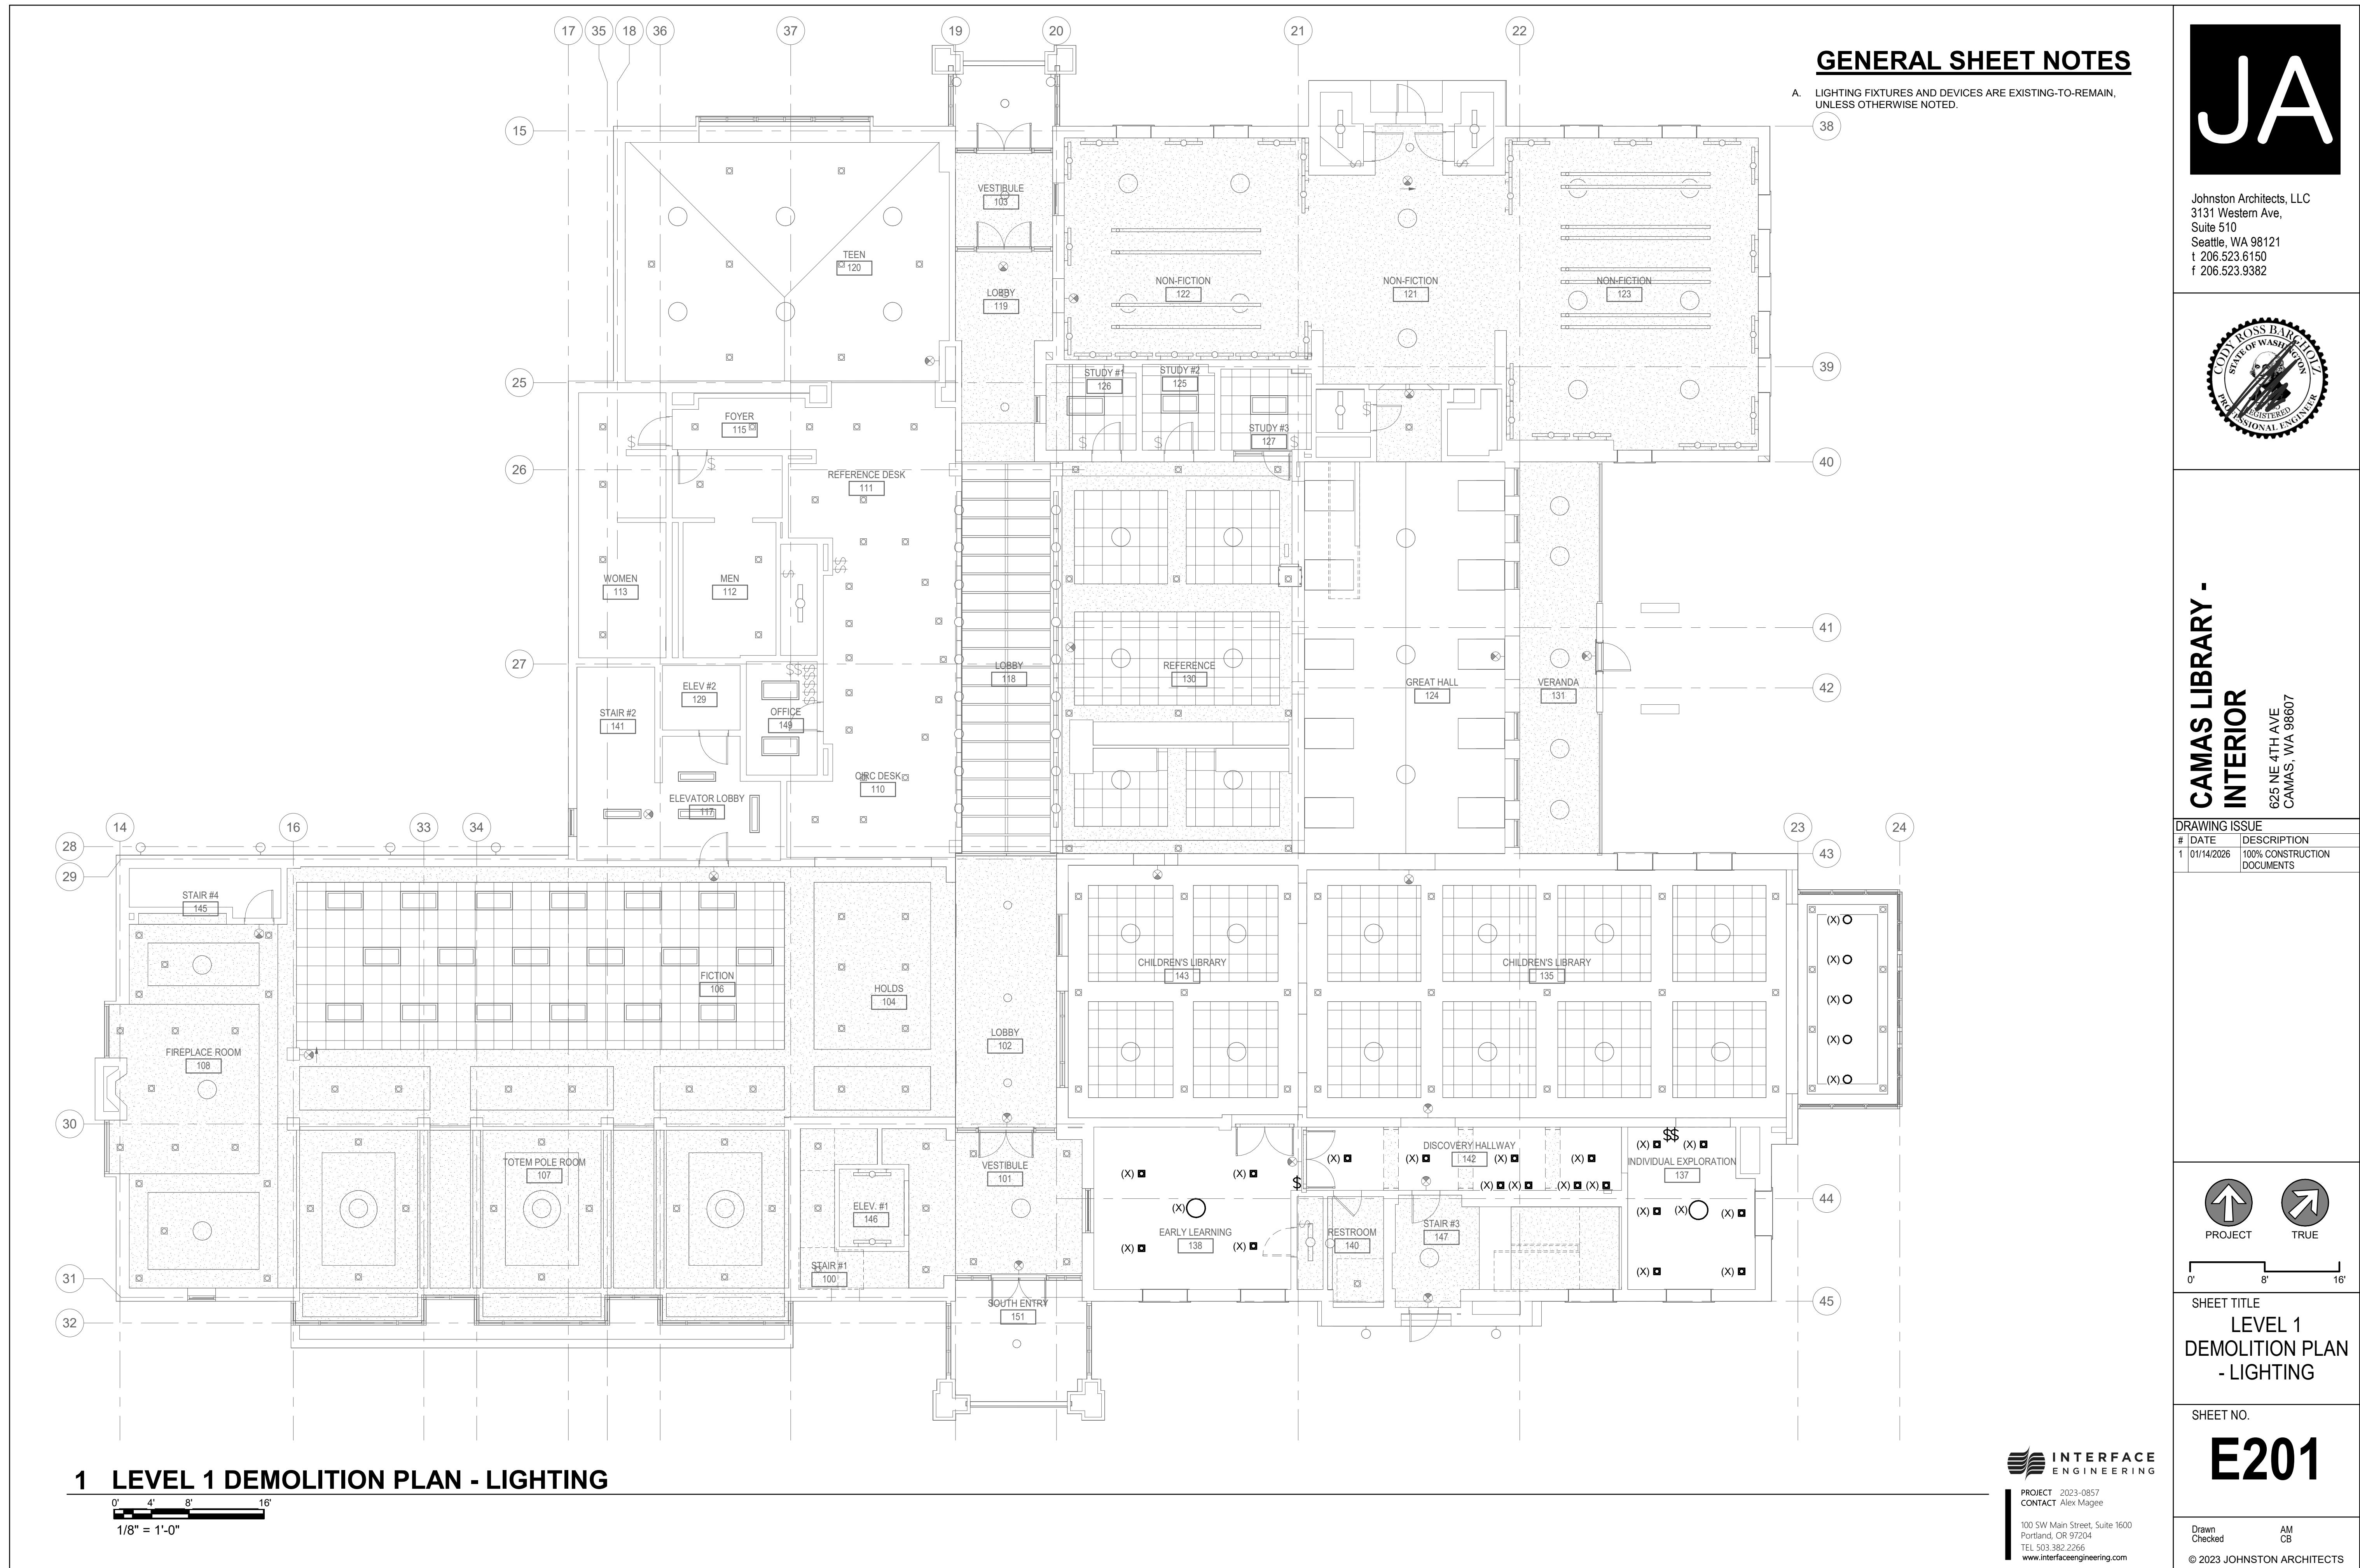

# JA


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SHEET TITLE  
LEVEL 1  
DEMOLITION PLAN  
- POWER


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# E202

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PROJECT 2023-0857  
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Portland, OR 97204  
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## 1 LEVEL 1 DEMOLITION PLAN - POWER

0' 4' 8' 16'  
1/8" = 1'-0"

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## GENERAL SHEET NOTES

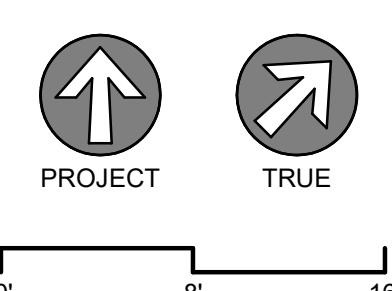- A. LIGHTING FIXTURES AND DEVICES ARE EXISTING-TO-REMAIN, UNLESS OTHERWISE NOTED.
- B. CONNECT NEW LUMINAIRES TO EXISTING NORMAL LIGHTING CIRCUIT MADE AVAILABLE BY DEMOLITION OF EXISTING NORMAL LIGHTS, UNLESS OTHERWISE NOTED.
- C. PROVIDE BOTH SWITCHED AND UNSWITCHED CIRCUIT LEGS FOR EMERGENCY LIGHTING LUMINAIRES DESIGNATED WITH THE SUBSCRIPT 'EM'.
- D. EXISTING TO REMAIN LUMINAIRES, CLEAN AND RELAMP PER E001 LED REPLACEMENT MATRIX.

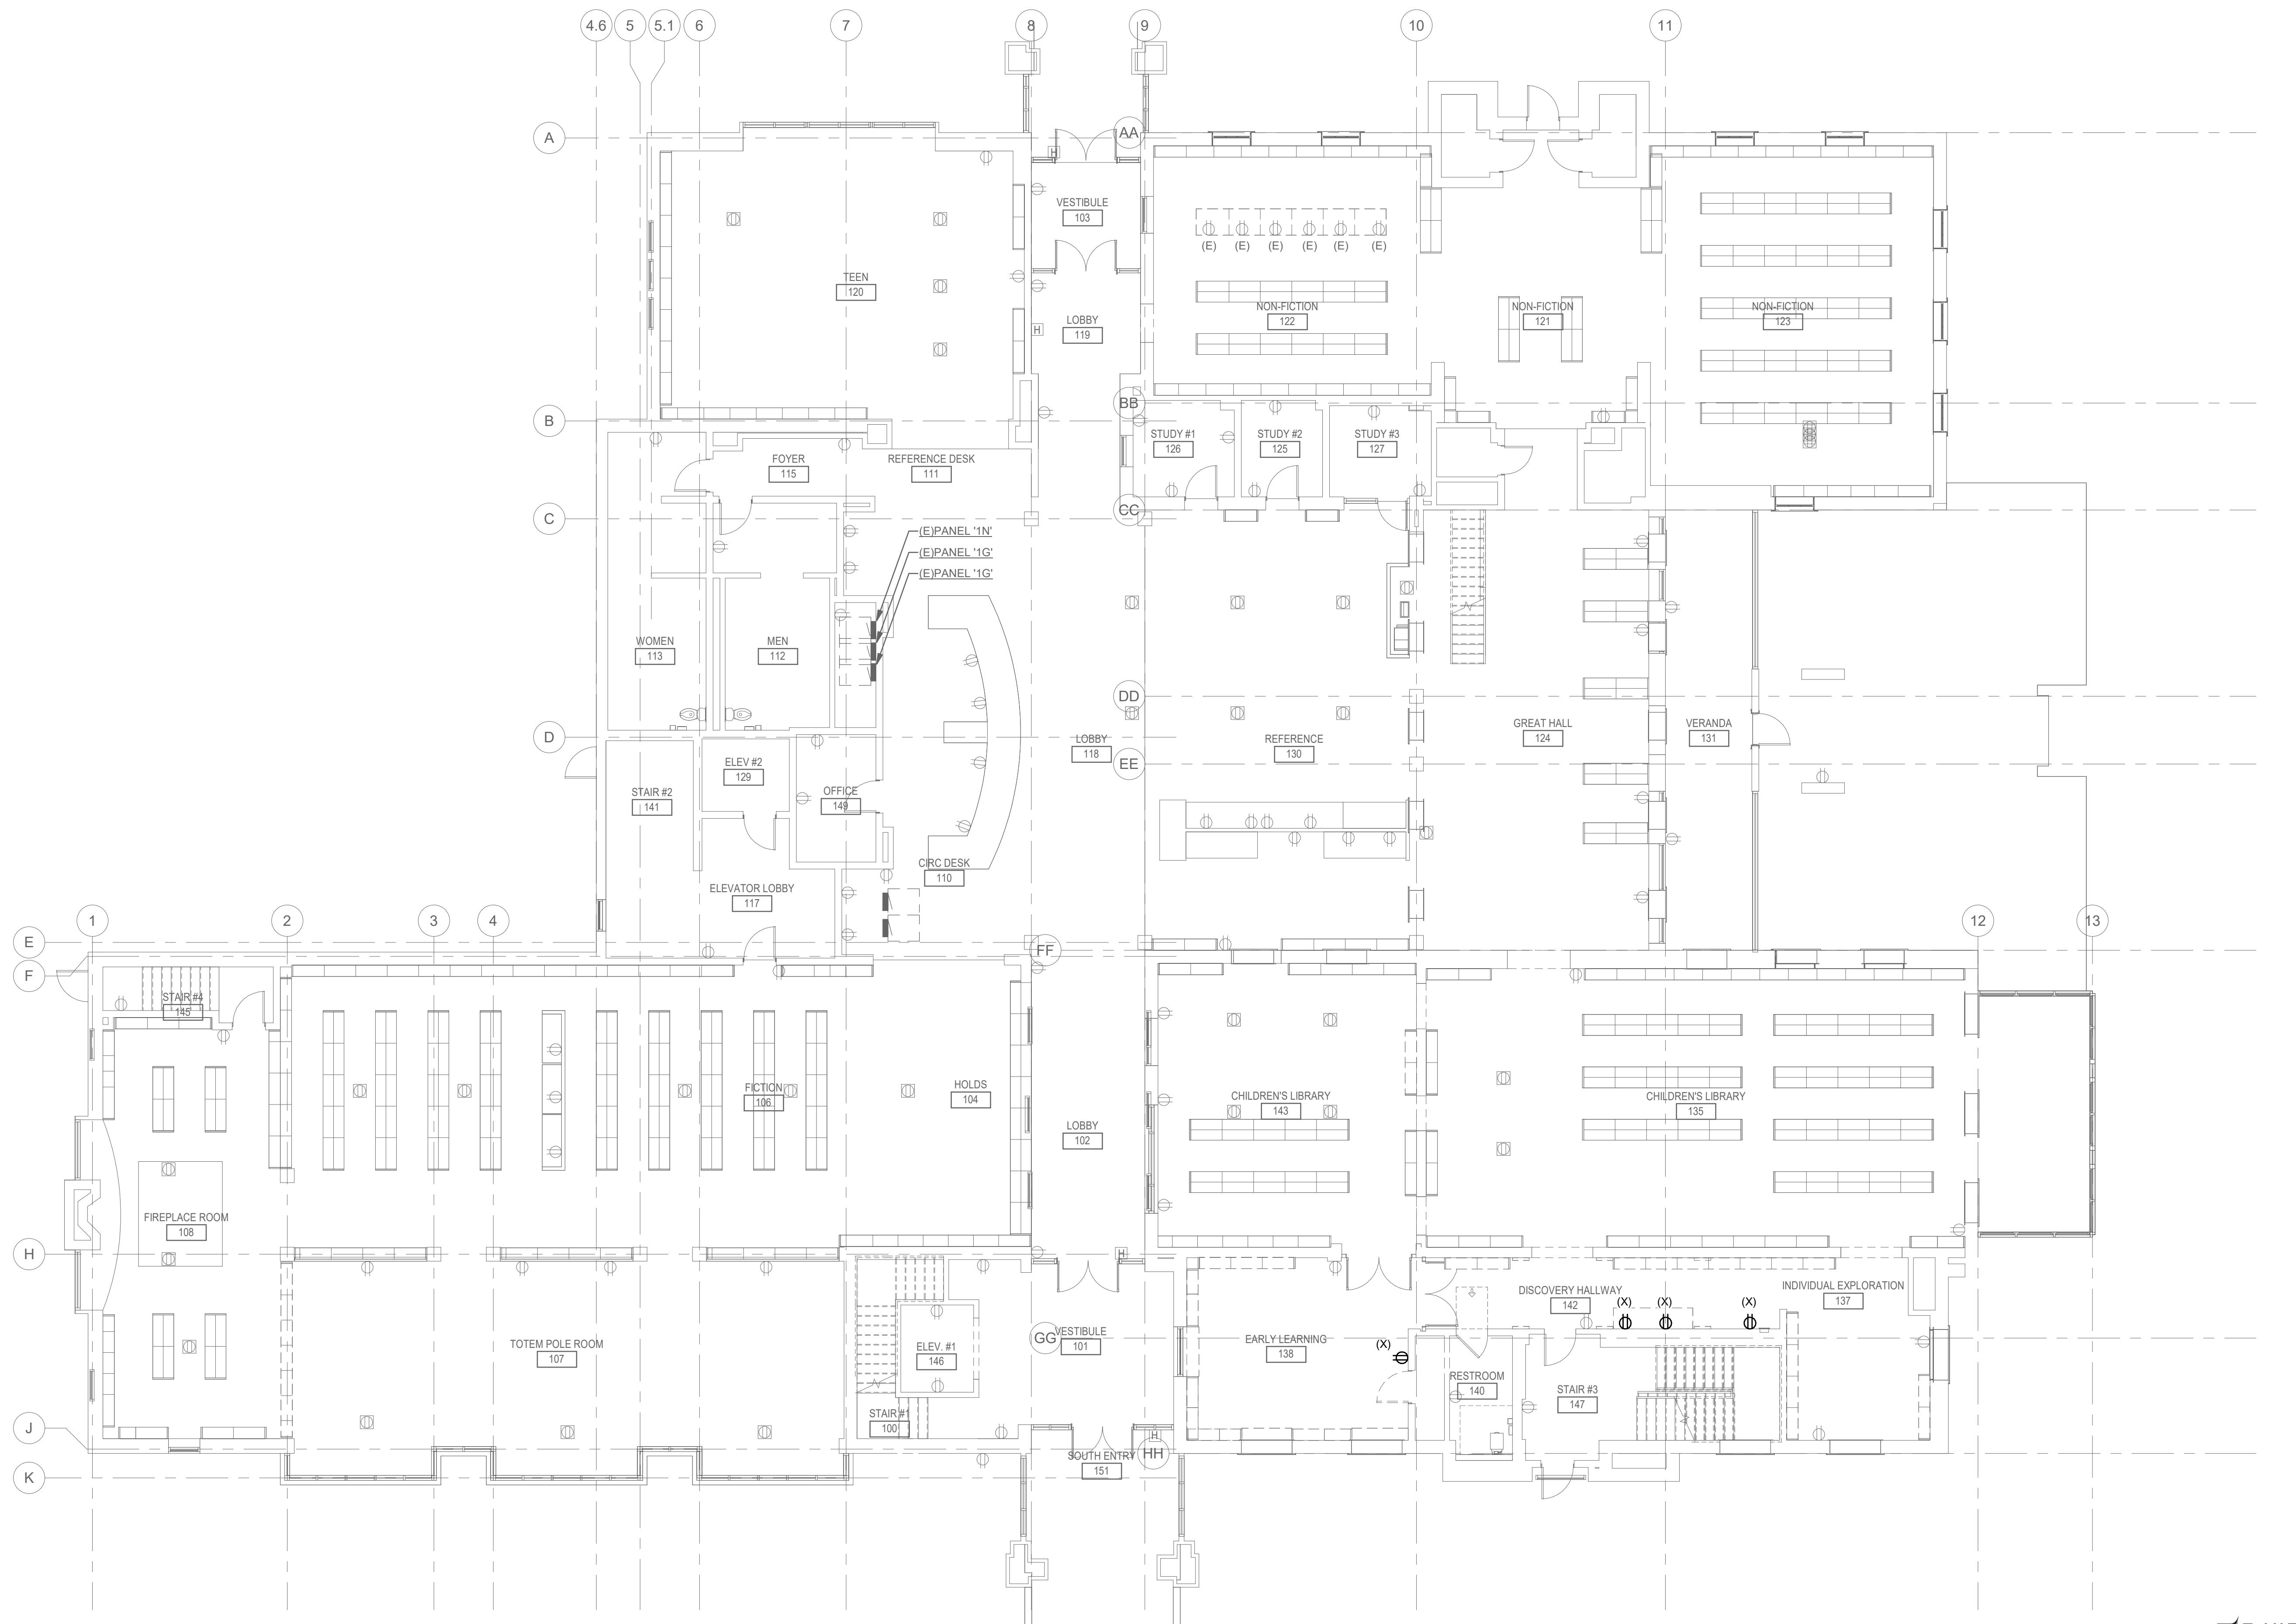
## SHEET KEYNOTES

1. NOT USED.
2. FIBER OPTIC LIGHTING INSTALLATION PER MANUFACTURER RECOMMENDATIONS.
3. INSTALL REMOTE DRIVERS FOR TYPE 'F' FIXTURES IN THE AREA INDICATED AND CIRCUIT AS INDICATED. COORDINATE WITH ARCHITECT PRIOR TO INSTALLATION. PROVIDE LOW VOLTAGE WIRING FROM DRIVER TO LED LUMINAIRES PER MFR INSTRUCTIONS.

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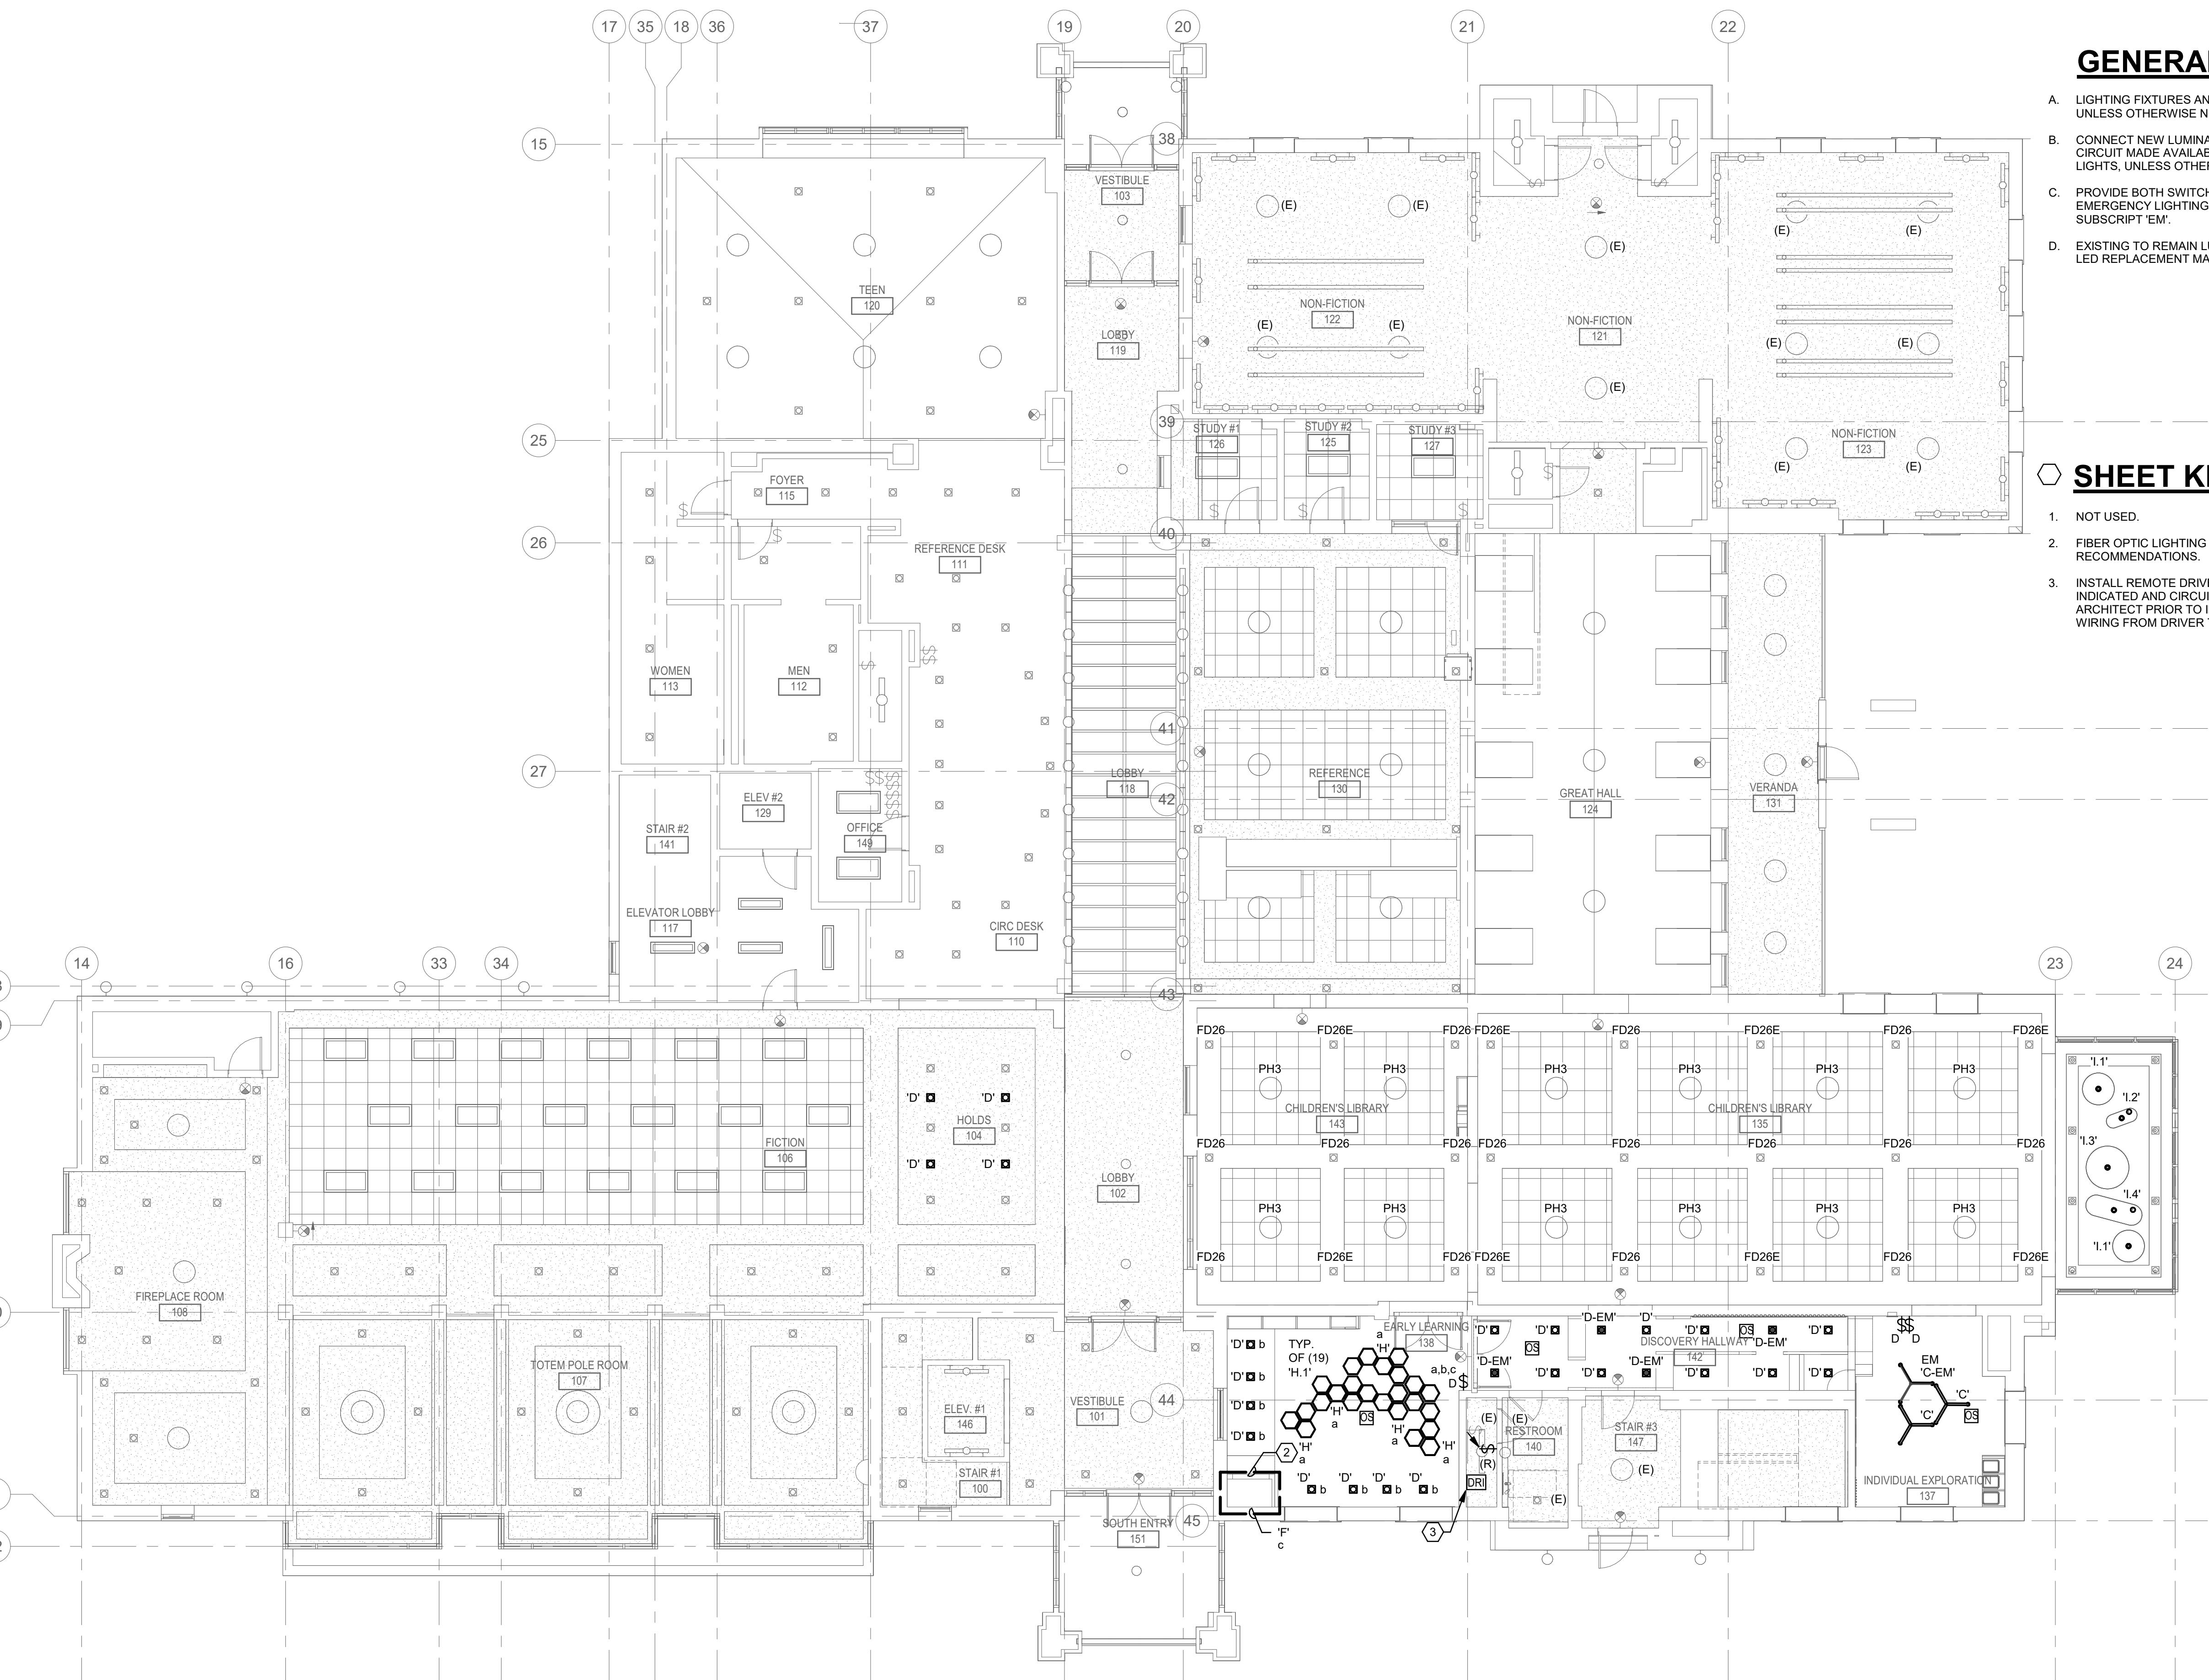
SHEET TITLE  
LEVEL 1 CEILING  
PLAN - LIGHTING

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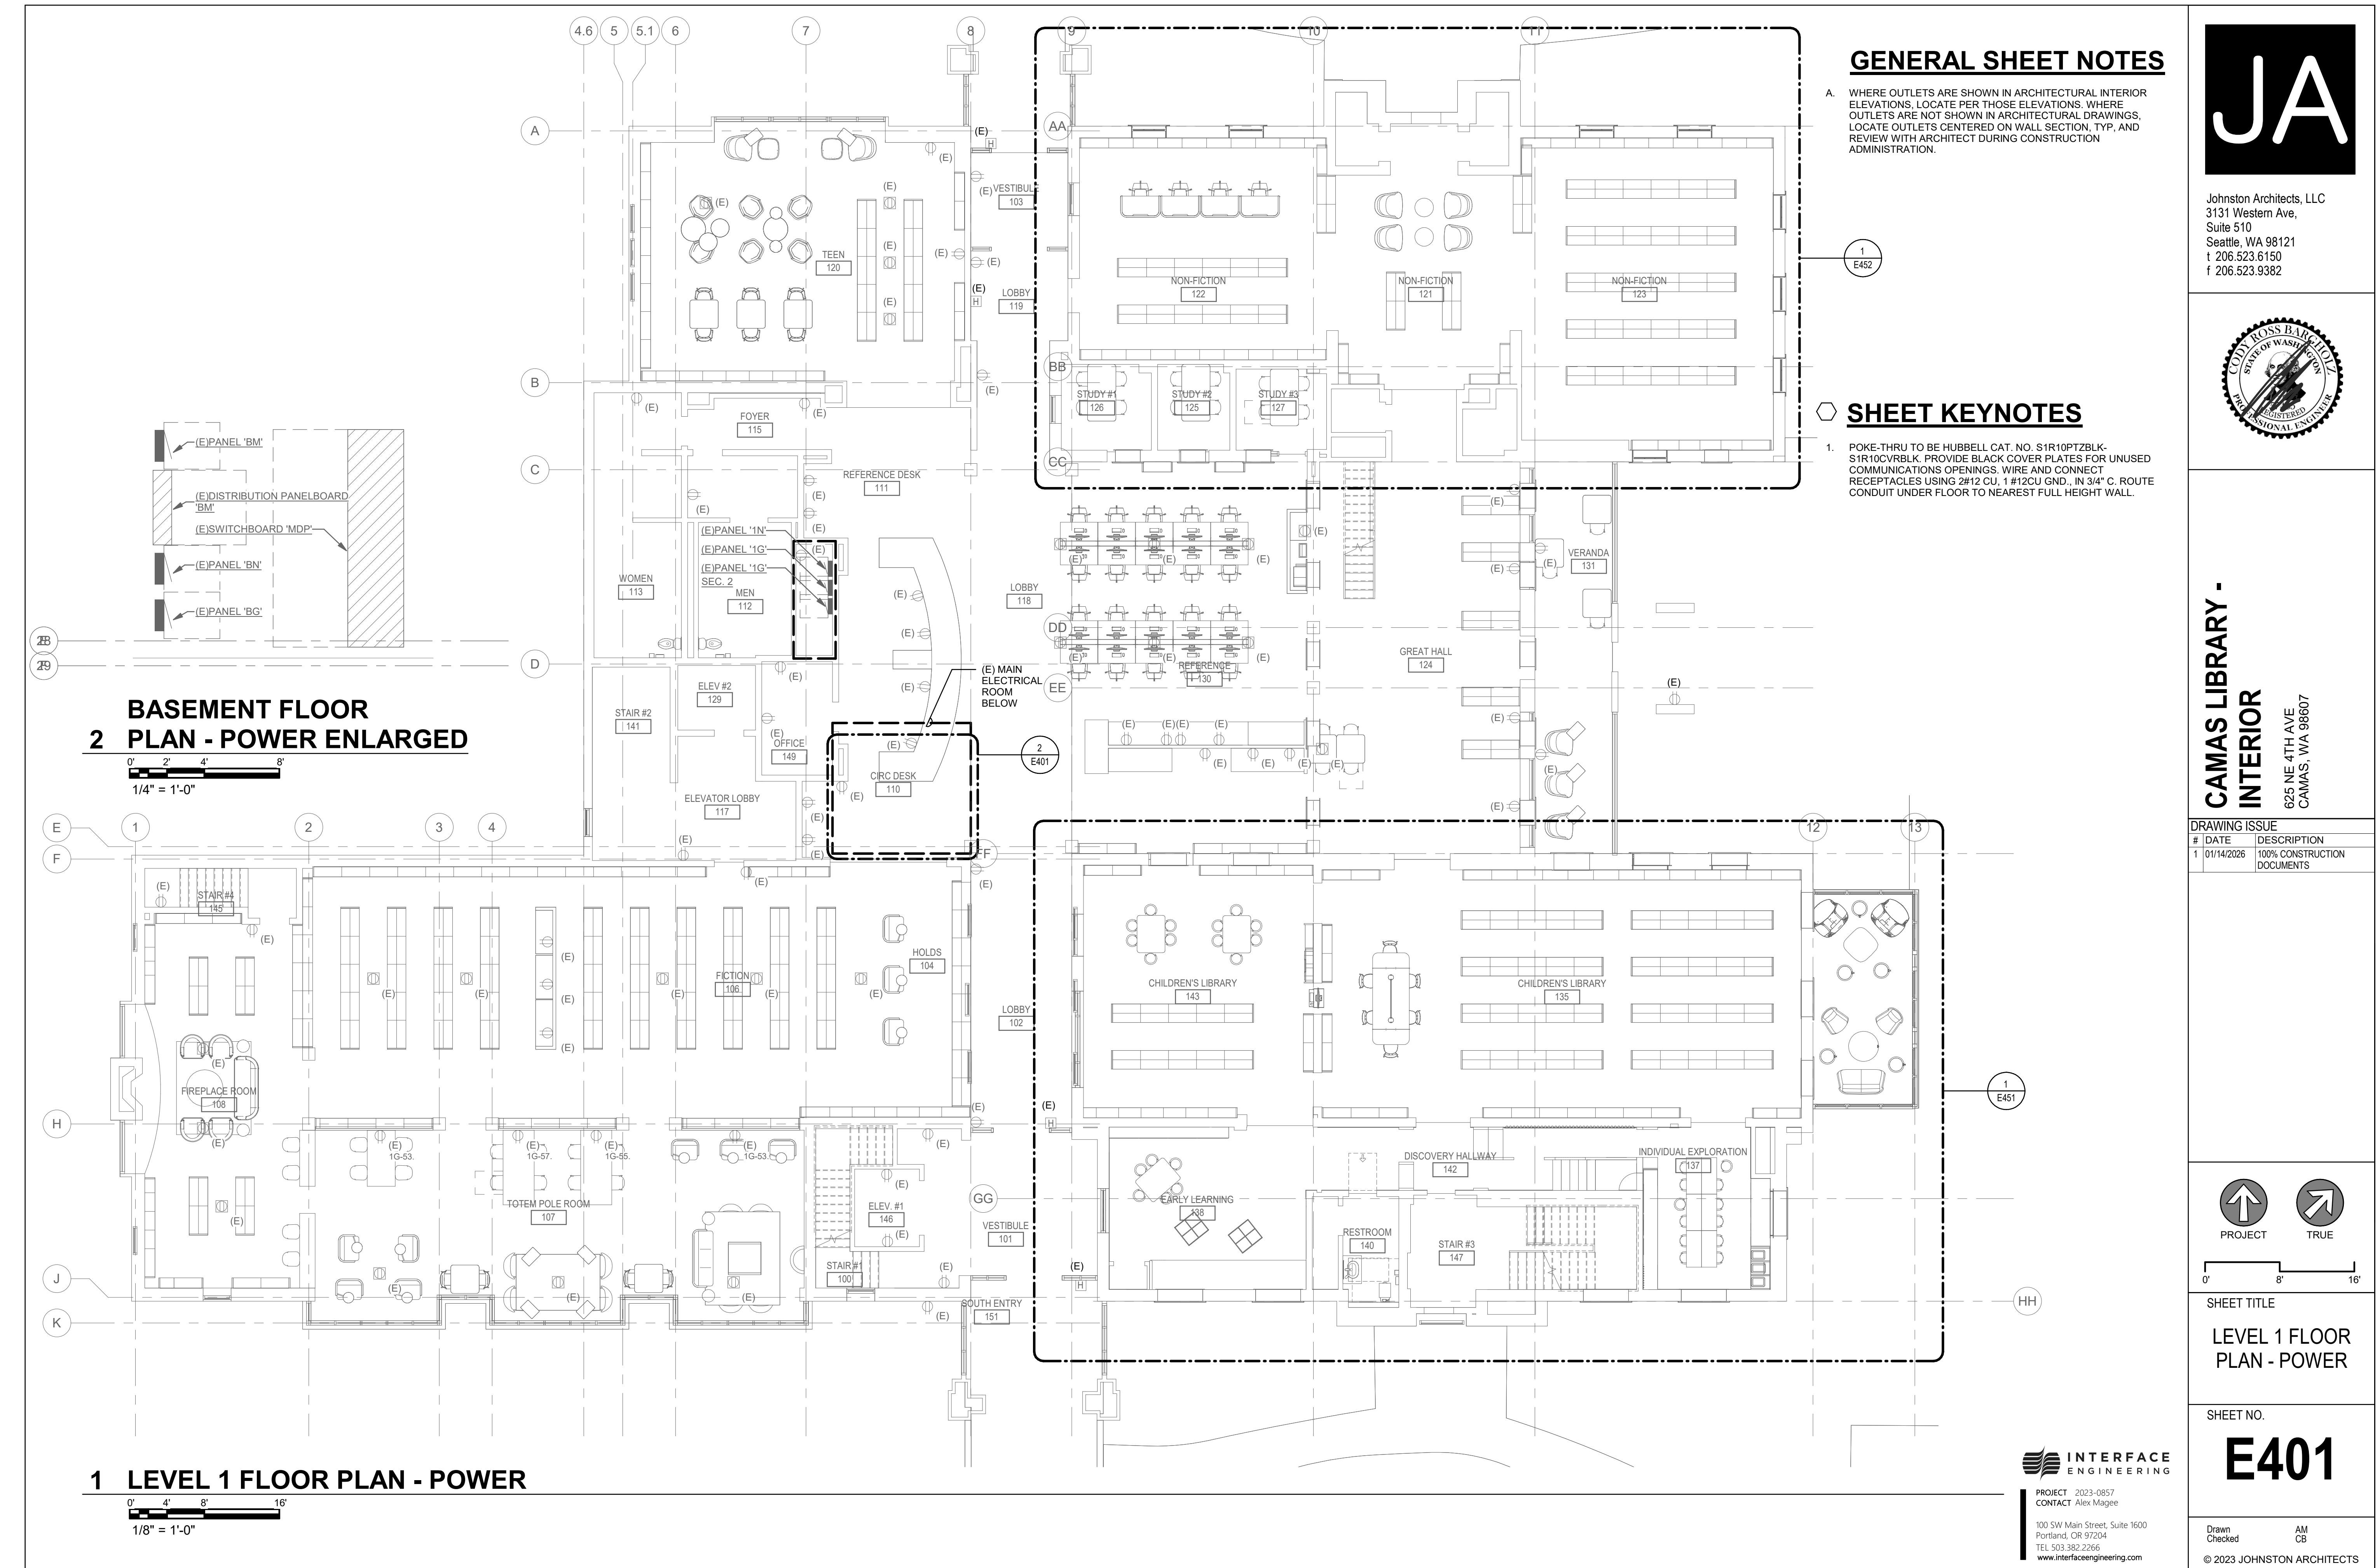
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## 1 LEVEL 1 CEILING PLAN - LIGHTING

0' 4' 8' 16'  
1/8" = 1'-0"

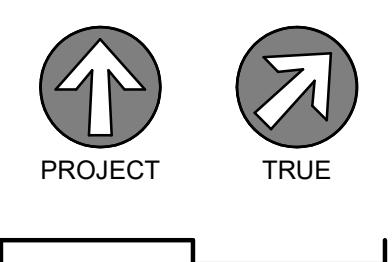

# JA


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0' 4' 8'  
SHEET TITLE  
LEVEL 1  
ENLARGED PLAN -  
CHILDREN'S  
LIBRARY - POWER

SHEET NO.


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## SHEET KEYNOTES

1. PROVIDE HUBBELL SYSTEM ONE 4-GANG ON GRADE RATED FLOOR BOX, BOX TO BE HUBBELL CAT. NO. CFB4G30RCR-CFB51R8CVBLK. PROVIDE BLACK COVER PLATES FOR UNUSED COMMUNICATIONS OPENINGS. WIRE AND CONNECT RECEPTACLES USING 2#12 CU, 1 # 12CU GND, IN 3/4" C. ROUTE CONDUIT UNDER FLOOR TO NEAREST FULL HEIGHT WALL.

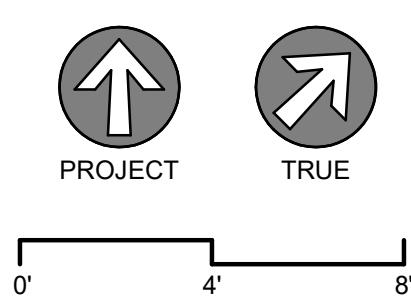

1 LEVEL 1 ENLARGED PLAN - CHILDREN'S LIBRARY - POWER

0' 2' 4' 8'  
1/4" = 1'-0"

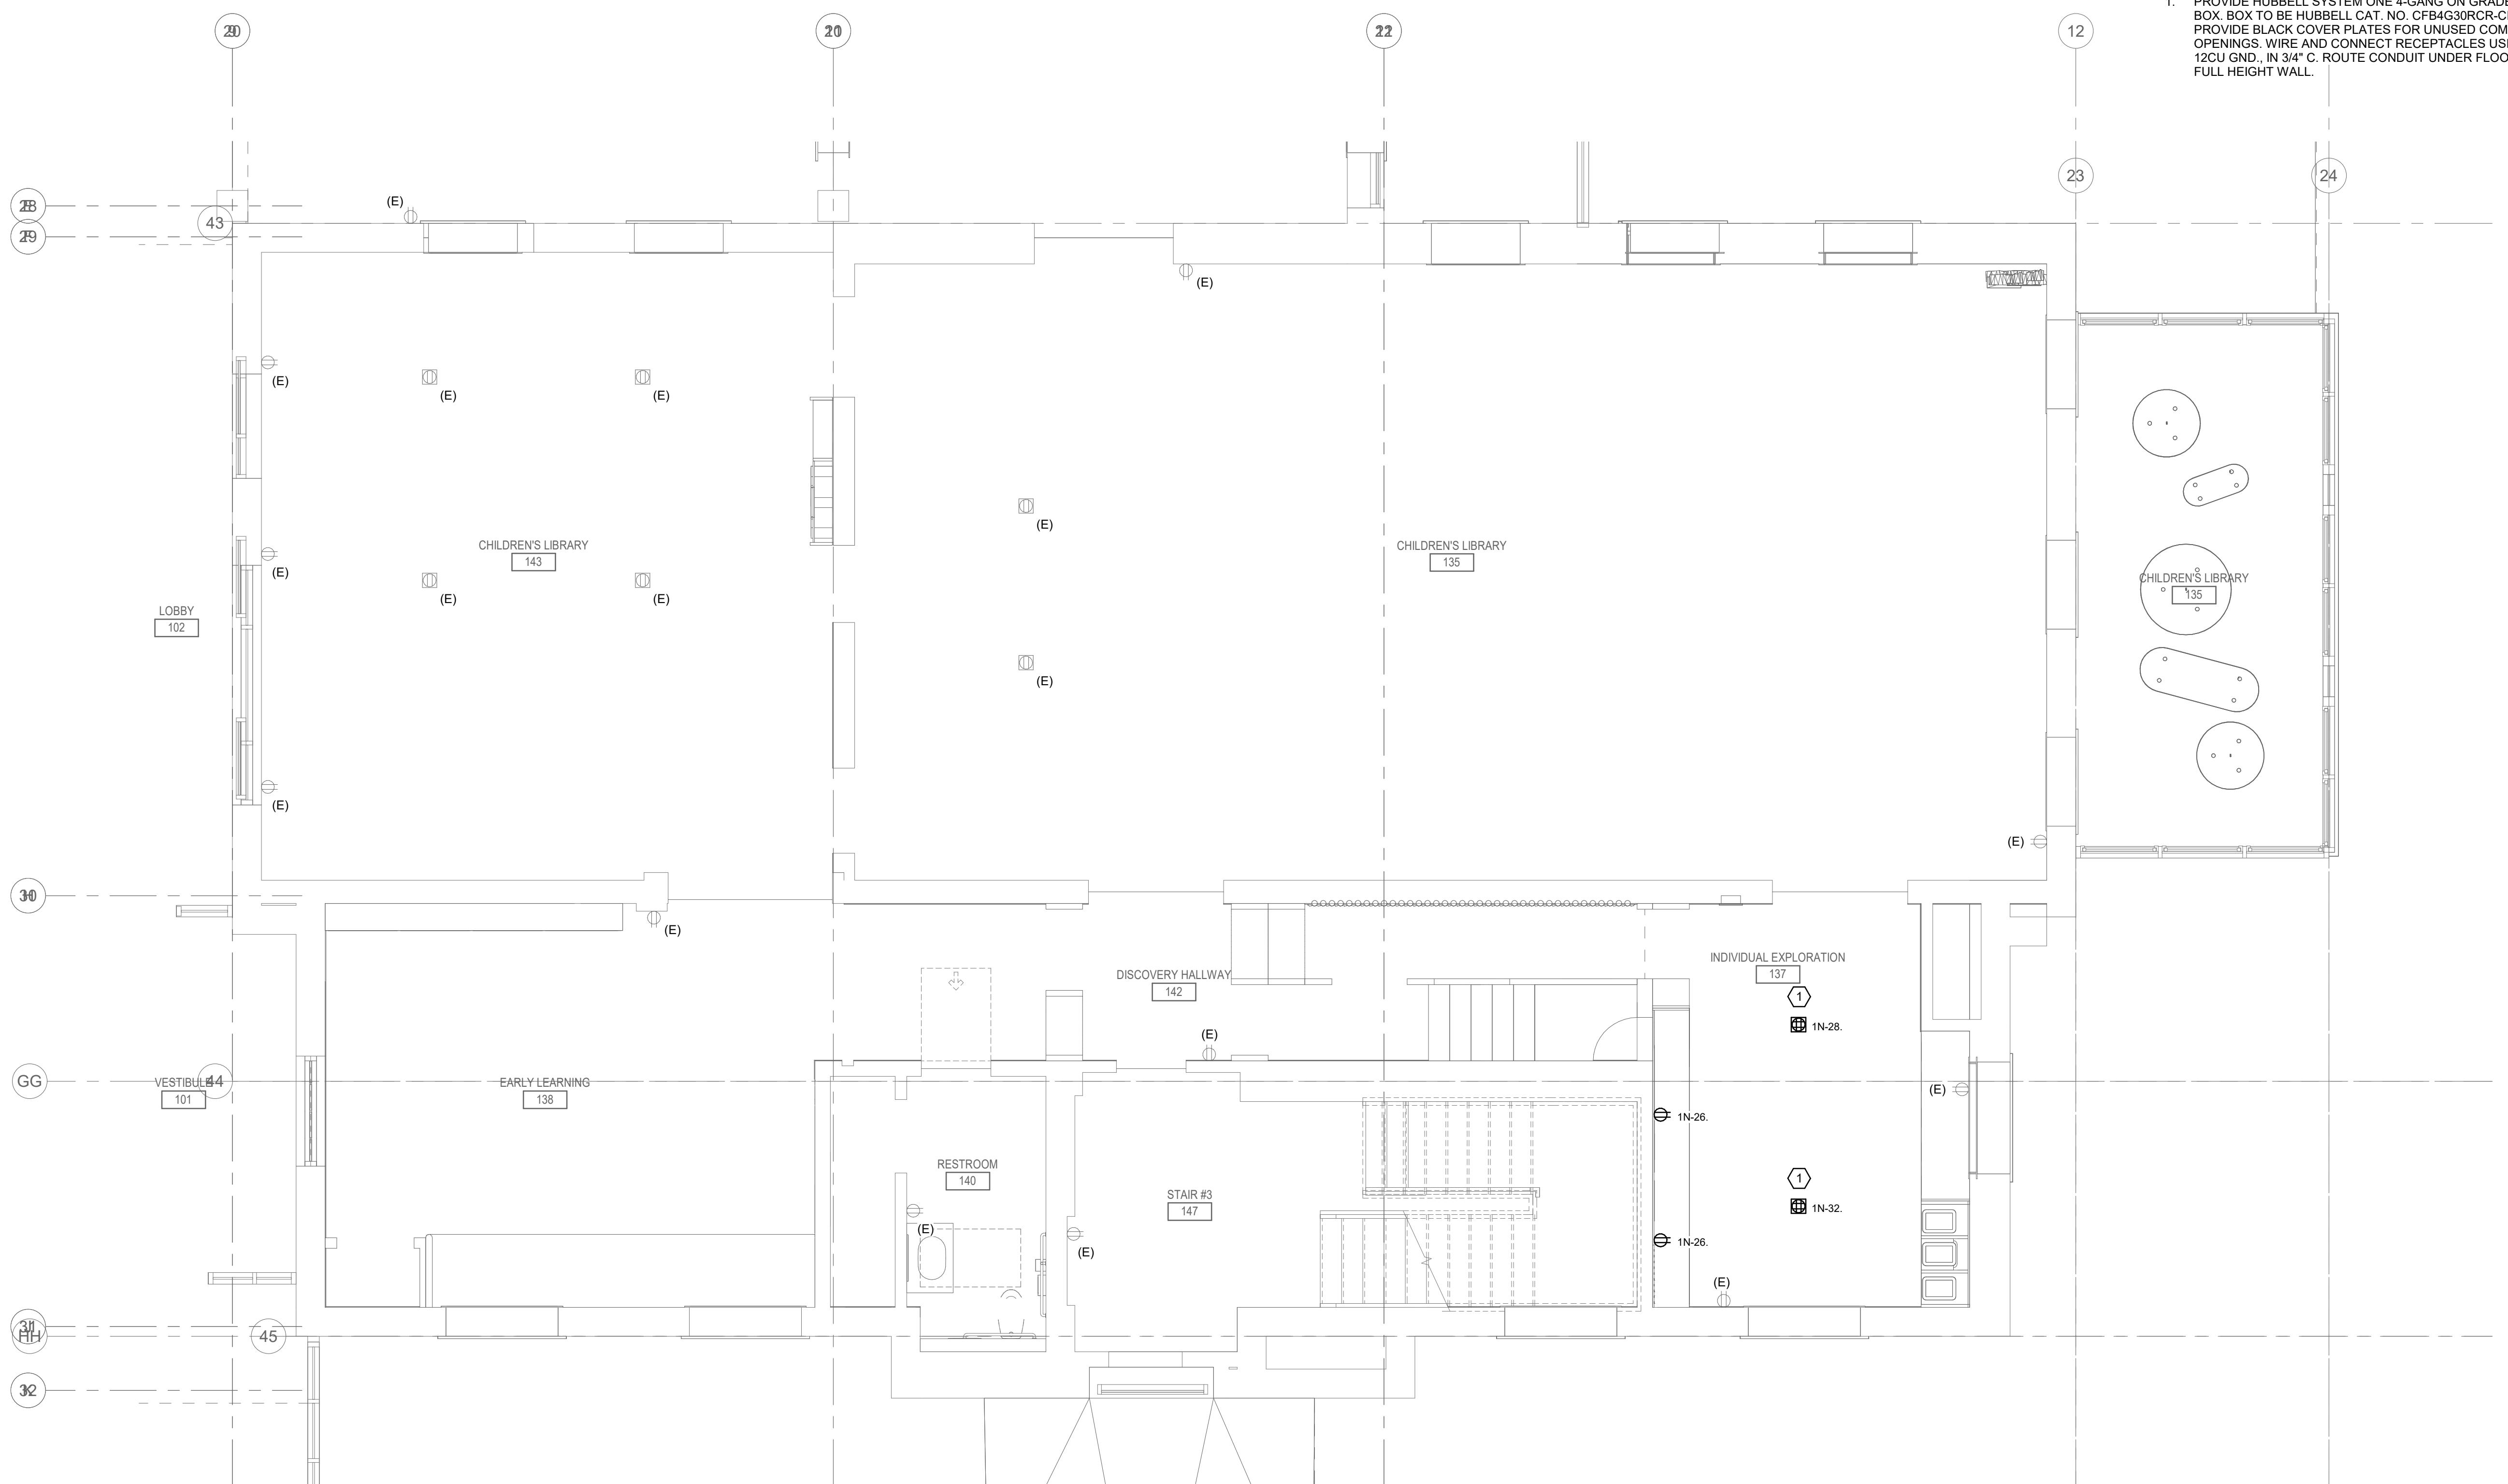

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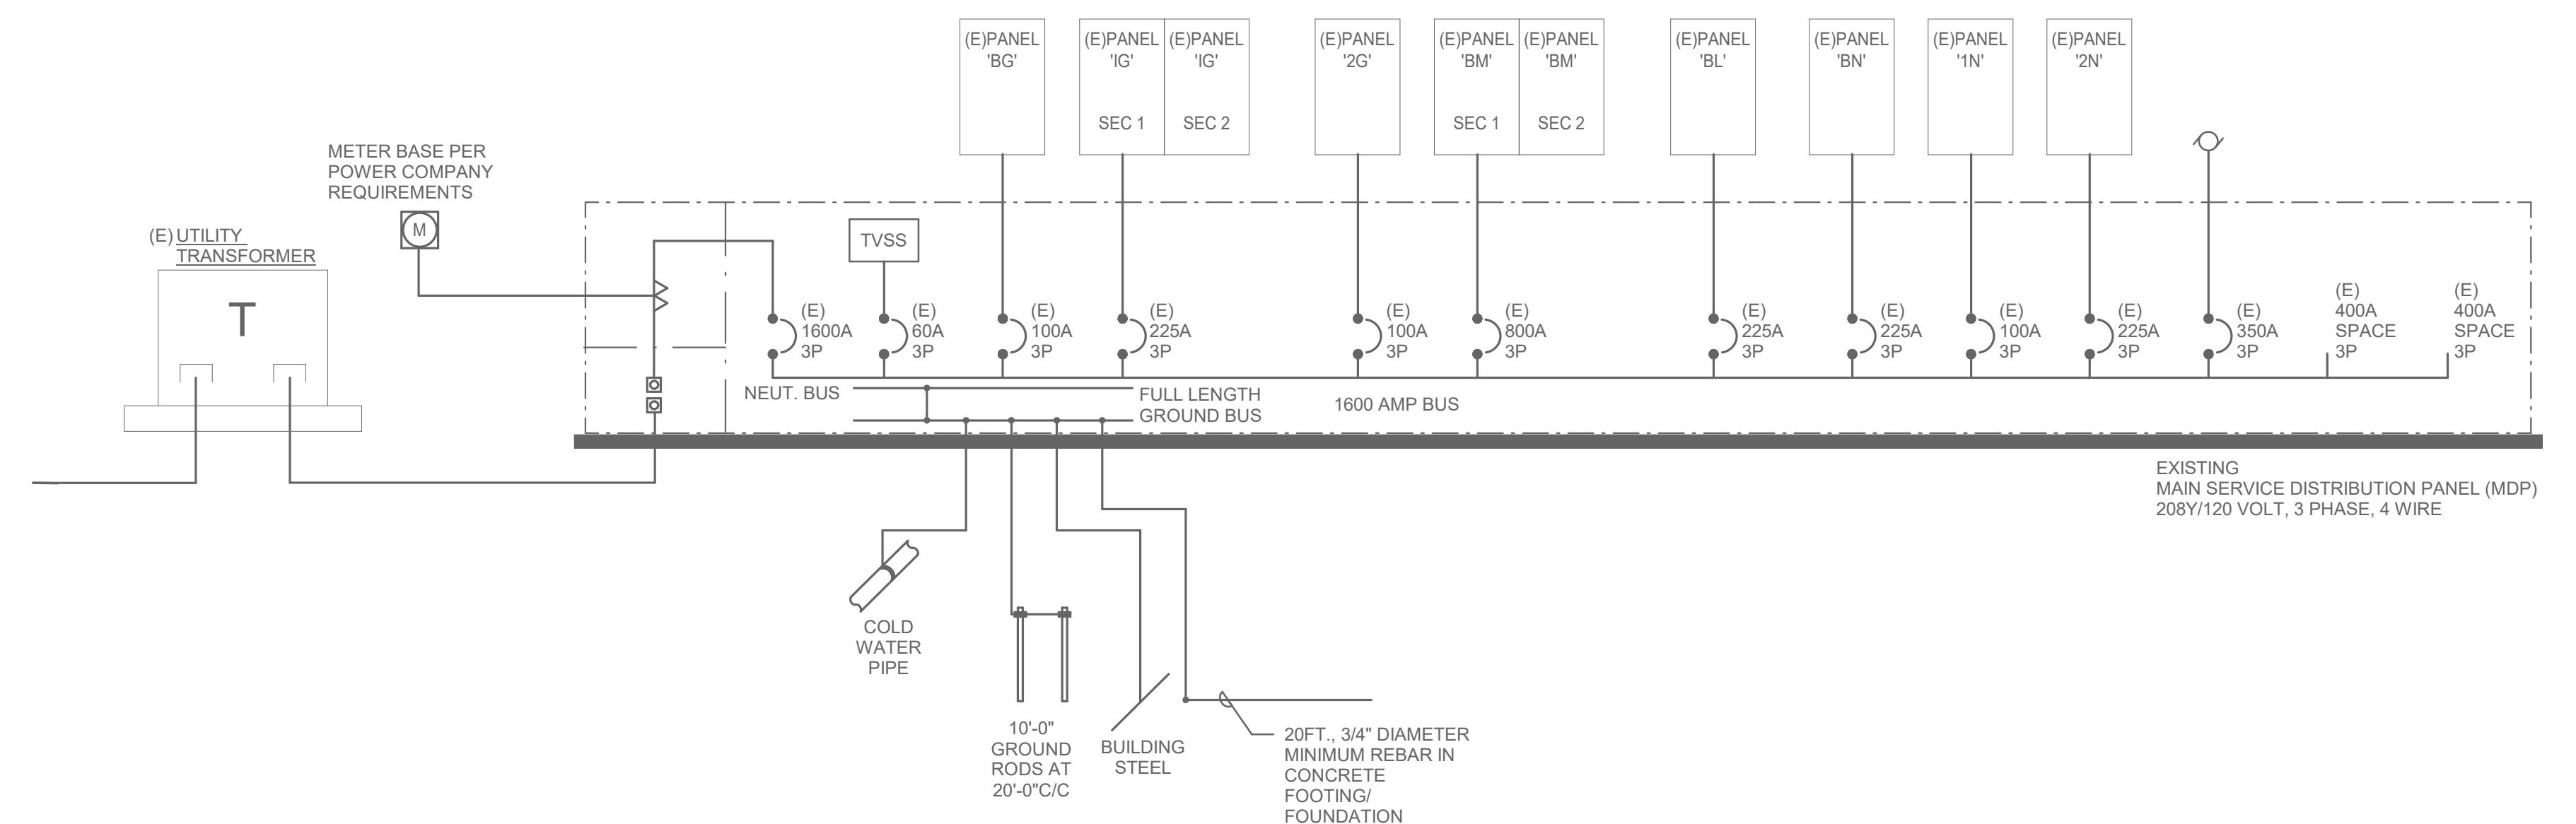


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**1 EXISTING ONE LINE DIAGRAM - ELECTRICAL**

NO SCALE

**SHEET TITLE**  
**SINGLE LINE  
DIAGRAMS -  
ELECTRICAL**

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EXISTING PANELBOARD: 1N																																	
		MAIN LUG ONLY				MOUNTING: SURFACE				Accessories:																							
		BUS AMPACITY: 100 A				ENCLOSURE: TYPE 1																											
		EQUIPMENT RATING: 120/208 V, 3PH, 4 WIRE				LOCATION:				SUPPLIED FROM: MDP																							
FOR AIC RATING SEE ONE-LINE DIAGRAM																																	
Load (VA)																																	
CKT	Description/Location	Type	C.B.	Pole	Note	A	B	C	A	B	C	Note	Pole	C.B.	Type	Description/Location	CKT																
1	(E) EC 108, 149	R	20 A	1	540		528		1	20 A	--	(E) ELEV 1 CAB LTS		2																			
3	(E) REC 101	--	20 A	1		360		360	1	20 A	R	(E) ELEV REC PIT		4																			
5	(E) REC 101, 102, 107	R	20 A	1		900		864	1	20 A	--	(E) SP-1		6																			
7	(E) REC 139, 143	R	20 A	1	900		360		1	1	20 A	R	R - FLOOR BOX NON-FICTION		8																		
9	(E) REC 135	R	20 A	1	720		360		1	1	20 A	R	R - FLOOR BOX NON-FICTION		10																		
11	(E) REC O/S	R	20 A	1		540		360	1	1	20 A	--	(E) ELEV REC PIT		12																		
13	(E) REC 140, 42, 47	R	20 A	1	540		500		1	1	20 A	--	(E) EF-2		14																		
15	SPARE BREAKER	--	20 A	1		0		360	1	1	20 A	R	R - FLOOR BOX NON-FICTION		16																		
17	SPARE BREAKER	--	20 A	1		0		0	1	1	20 A	--	SPARE BREAKER		18																		
19	(E) REC 112, 113	--	20 A	1	720		900		1	1	20 A	--	(E) DOOR SEC		20																		
21	(E) EWC	--	20 A	1		750		600	1	1	20 A	--	(E) UNKNOWN		22																		
23	(E) REC 125,26,27	R	20 A	1		540		0	1	1	20 A	--	SPARE BREAKER		24																		
25	(E) REC 103,19,21	R	20 A	1	540		720		1	1	20 A	R	R - IND. EXP. COUNTER		26																		
27	(E) REC O/S	--	20 A	1		180		360	1	1	20 A	R	R - IND. EXP. FLOOR BOX		28																		
29	(E) PUMP CONTROLLER	R	20 A	1		500		0	1	1	20 A	--	(E) AHU-5 DOC		30																		
31	(E) ROOF HEAT TRACE	--	20 A	1	480		360		1	1	20 A	R	R - IND. EXP. FLOOR BOX		32																		
33	(E) ROOF HEAT TRACE	--	20 A	1		480		0	1	1	20 A	--	SPARE BREAKER		34																		
35	SPARE BREAKER	--	20 A	1		0		0	1	1	20 A	--	SPARE BREAKER		36																		
37	SPARE BREAKER	--	20 A	3	0		0		3	20 A	--	SPARE BREAKER		38																			
39	--	--	--	--	0		0		--	--	--	--	--		40																		
41	--	--	--	--	0		0		--	--	--	--	--		42																		
Total Connected load Ph. A		60 A	Panel Connected Load: 15.3 kVA				42.5 A																										
Total Connected load Ph. B		39 A	Total Demand Load: 15.3 kVA				42.5 A																										
Total Connected load Ph. C		31 A																															
Notes:																																	
1. PROVIDE NEW LOAD ON EXISTING BREAKER.																																	
Load Type Definitions:																																	
Motor (125% largest Motor + 100% remaining... K = Kitchen (Demand as per NEC Table 220.56) C = Continuous Load (125%) X = X-Rays (Demand per NEC... R = Receptacles (to 10kVA100%, over 10 kVA... G = General Load (Non-continuous) (100%) L = Lighting (125%) H = Heating (100%) E = Existing Load 30-day metered (125%) EL = Elevator (Demand as per NEC Table... W = Water Heater (125%) EV = Electric Vehicle Charger																																	
Load Type		Connected Load		NEC Demand Factor		NEC Demand Load		Panel Totals																									
R		8600.0		100.00%		8600.0																											
Spare		6722.0		100.00%		6722.0																											
Total Connected Load: 15322.0 VA																																	
Total NEC Demand: 15322.0 VA																																	
Total Connected Current: 42.5 A																																	
Total NEC Demand Current: 42.5 A																																	
Load Type Definitions:																																	
Motor (125% largest Motor + 100% remaining... K = Kitchen (Demand as per NEC Table 220.56) C = Continuous Load (125%) X = X-Rays (Demand per NEC... R = Receptacles (to 10kVA100%, over 10 kVA... G = General Load (Non-continuous) (100%) L = Lighting (125%) H = Heating (100%) E = Existing Load 30-day metered (125%) EL = Elevator (Demand as per NEC Table... W = Water Heater (125%) EV = Electric Vehicle Charger																																	
Load Type		Connected Load		NEC Demand Factor		NEC Demand Load		Panel Totals																									
R		19080.0		76.21%		14540.0																											
Spare		540.0		100.00%		540.0																											
Total Connected Load: 19620.0 VA																																	

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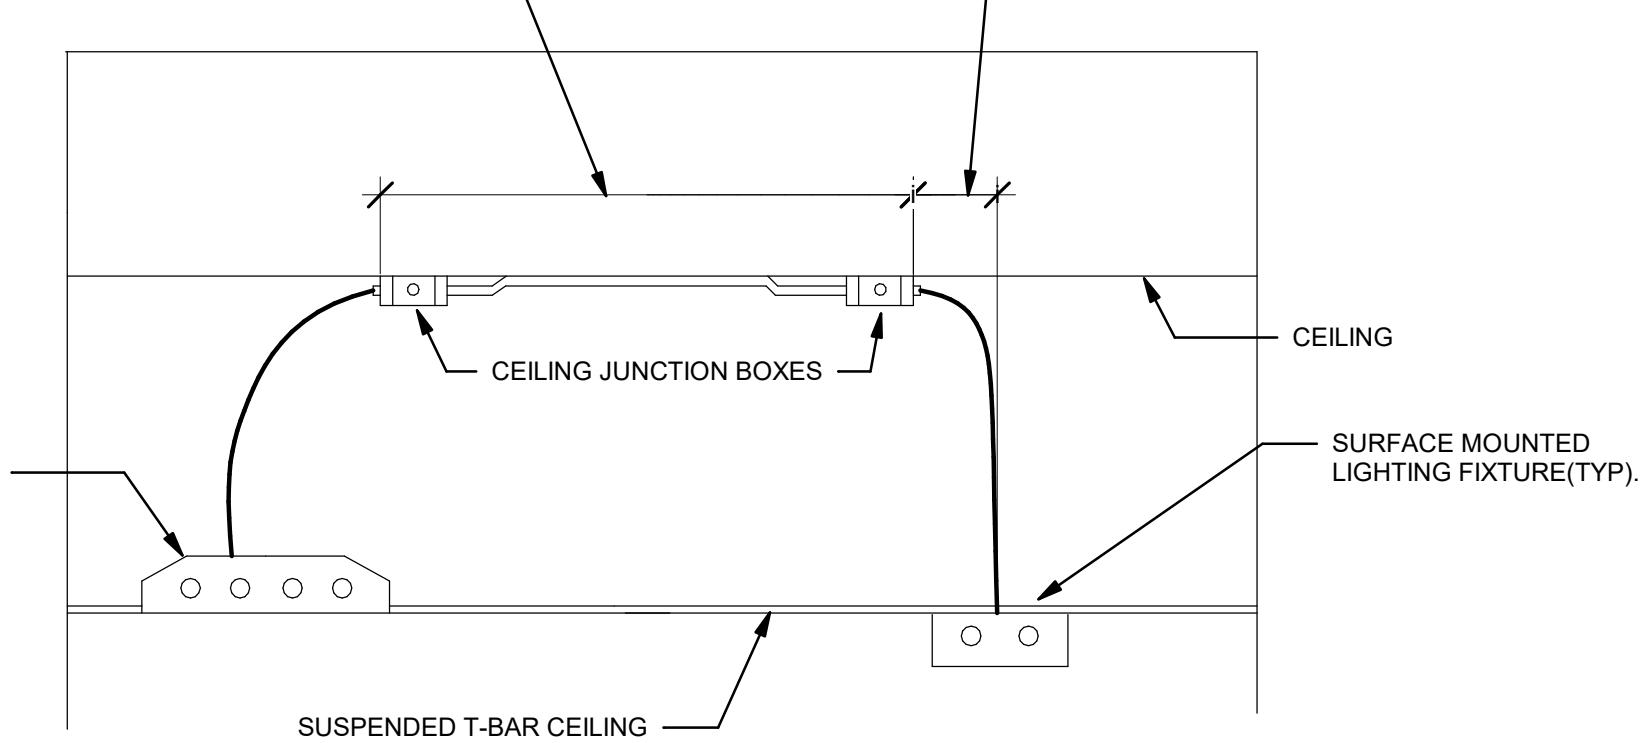
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RUN CONDUIT IF FIXTURE IS  
MORE THAN 6 FEET FROM  
JUNCTION BOX. MIN. #12  
AWG.




#### DETAIL NOTES:

(1) MC CABLE IS ONLY PERMITTED FOR FIXTURE DROPS. DO NOT LOOP MC CABLE FROM ONE FIXTURE TO ANOTHER.

## 1 LIGHTING DROP - DETAIL

NO SCALE

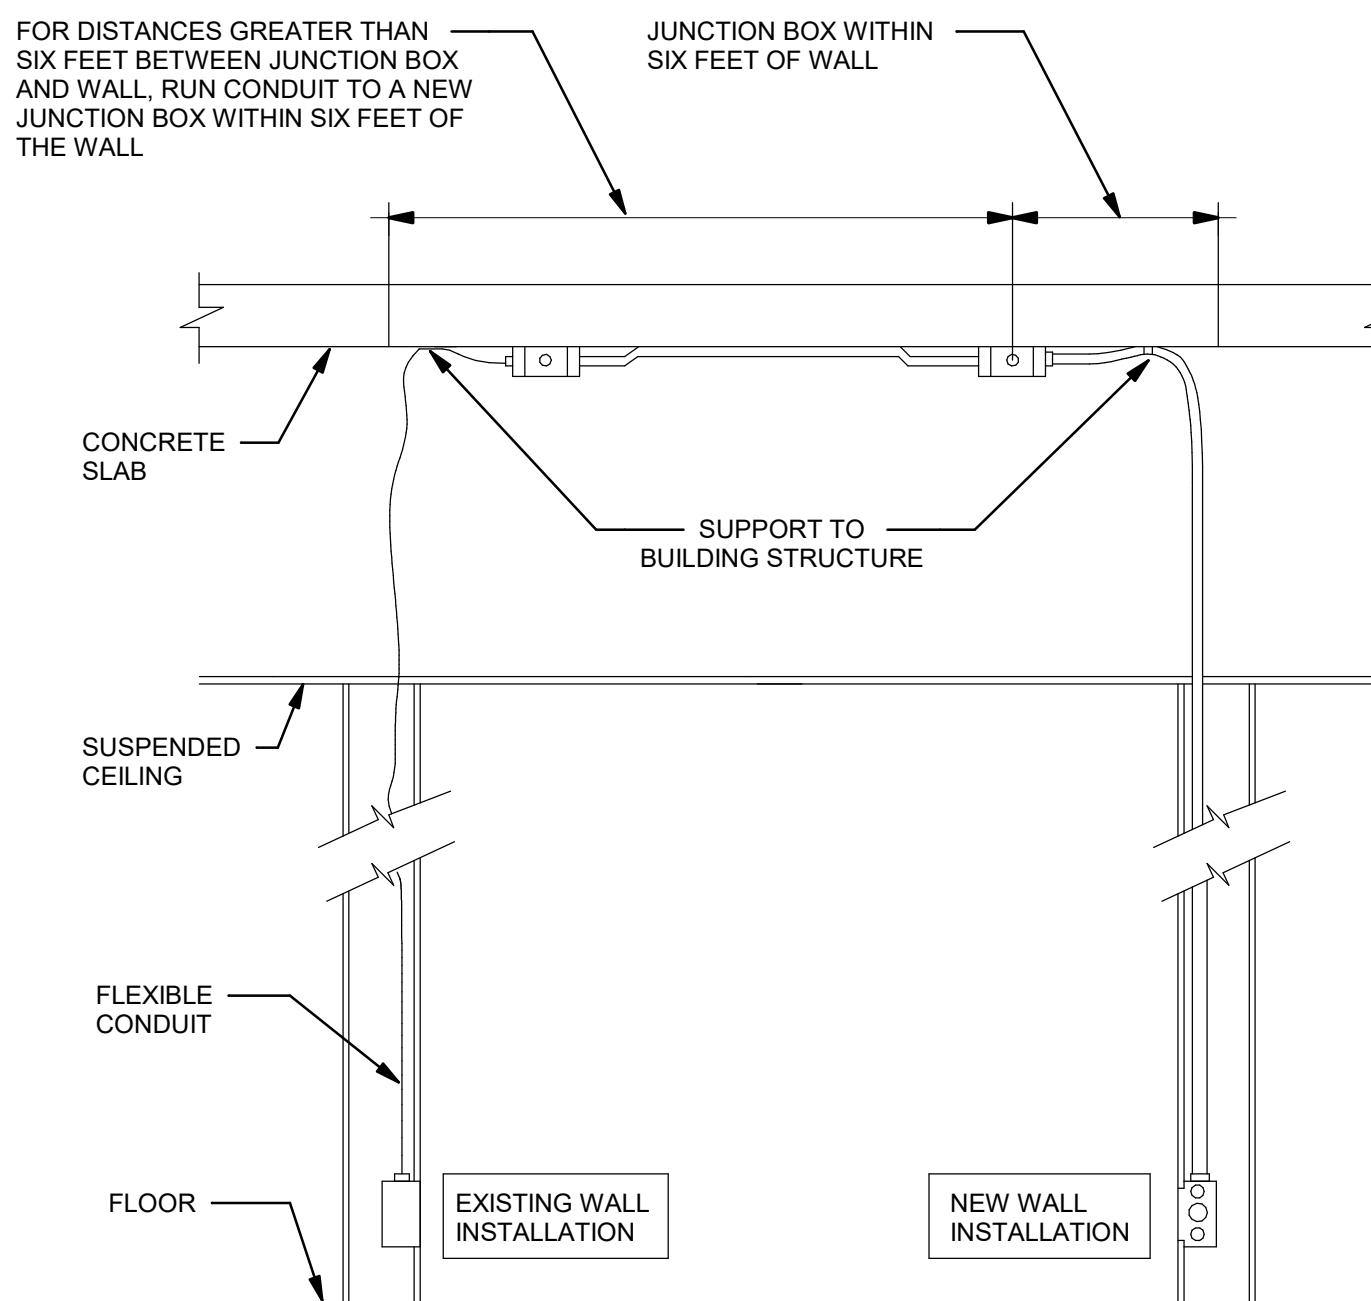

#### GENERAL DETAIL NOTES:

1. NEW WALL INSTALLATION RUN CONDUIT FROM JUNCTION BOX DOWN TO FIRST DEVICE.
2. EXISTING WALL INSTALLATION RUN FLEX OR MC CABLE FROM JUNCTION BOX DOWN TO DEVICE.
3. ALL CONDUITS ARE TO BE DIRECTLY SUPPORTED FROM SLAB.
4. COORDINATE ROUTE WITH OTHER TRADES TO AVOID CONFLICTS WITH ACCESS.

## 2 POWER DROP DETAIL

NO SCALE