	BREVIATIONS ANGLE	LD (O)	DOLIND (C)
∠	ANGLE ANCHOR BOLT ACOUSTICAL	LB (S)	POUND (S)
AB		LF	LINEAL FOOT/FEET
ACST		LH	LEFT HAND
ADA	AMERICANS WITH DISABILITIES ACT	LHR	LEFT HAND REVERSE
ADDL		LNDSCP	LANDSCAPE
ADDL ADJ AFF	ADJACENT ABOVE FINISH FLOOR	LOC LR	LOCATION LIVING ROOM
AP	ACCESS PANEL APPROXIMATE	LTG LVL	LIGHTING LAMINATED VENEER LUMBER
ARCH	ARCHITECT (URAL)	MACH RM	MACHINE ROOM
ASTM	AMERICAN SOCIETY OF TESTING MATERIALS ARCHITECTURAL WOODWORKING INSTITUTE	MAG	MAGNET(IC)
AWI		MATL	MATERIAL
BLDG	BITUMINOUS	MAX	MAXIMUM
	BUILDING	MBR	MASTER BEDROOM
BLKG	BLOCKING	MC	MEDICINE CABINET MECHANICAL
BM	BEAM	MECH	
BO	BOTTOM OF	MEMB	MEMBRANE
BOF	BOTTOM OF FOOTING	MEP	MECHANICAL, ELECTRICAL, PLUMBING
BR	BEDROOM	MEZZ	MEZZANINE
BSMT	BASEMENT	MFD	MANUFACTURED
BTU	BRITISH THERMAL UNIT	MFR	MANUFACTURER
CAB	CABINET	MIN	"MINIMUM, MINUTE"
CB	CATCH BASIN	MIRR	MIRROR
C.C.	CENTER TO CENTER	MISC	MISCELLANEOUS
CFM	CUBIC FEET PER MINUTE CONTRACTOR FURNISHED; OWNER INSTALLED	MO	MASONRY OPENING
CFOI		MTL	METAL
CH	CHANNEL	MULL	MULLION
CI	CAST IRON	(N)	NEW
CIP	CAST-IN-PLACE (CONCRETE) CENTERLINE	NIC	NOT IN CONTRACT
CL		NOM	NOMINAL
CLG	CEILING	N	NORTH
CLR	CLEAR	NTS	NOT TO SCALE
CMU	CONCRETE MASONRY UNIT	OA	OVERALL
CO	CLEAN OUT	OC	ON CENTER
COL	COLUMN	OD	"OUTSIDE DIAMETER, DIMENSION"
CONC	CONCRETE	OFF	OFFICE
CONT	CONTINUOUS COORDINATE	OH	OVERHANG OPPOSITE HAND
CPT	CARPET (ED) CASEMENT	OVHD	OVERHEAD
CSMT		PBD	PARTICLE BOARD
CT	CERAMIC TILE DEGREES	PCP PERF	PORTLAND CEMENT PLASTER PERFORATED
	"DEMOLISH, DEMOLITION" DEPARTMENT	PERIM PERM	PERIMETER
DET	DETAIL	PERP	PERMANENT PERPENDICULAR
DB	A DIAMETER DECIBEL DIMENSION	PL PLAM	PROPERTY LINE PLASTIC LAMINATE
DIM	DIMENSION	PLWD	PLYWOOD
DN	DOWN	POLYISO	POLYISOCYANURATE
DS	DOWNSPOUT	PR	PAIR
DW	DISHWASHER	PRCST	PRECAST
DWR	DRAWINGS	PREFAB	PREFABRICATED
	DRAWER	PRELIM	PRELIMINARY
(E)	EXISTING	PRKG	PARKING
E	EAST	PROJ	PROJECT
EA EIFS	EACH EXTERIOR INSULATION AND FINISH SYSTEM	PROP PSF	PROPERTY POUNDS PER SQUARE FOOT
EL	ELEVATION	PSI	POUNDS PER SQUARE INCH
ELEC	ELECTRIC (AL)	PSL	PARALLEL STRAND LUMBER
ENCL	ENCLOSE (URE)	PTD	PAINTED POST-TENSIONED, PRESSURE TREATED
EQ	EQUAL	PT	
EQUIP	EQUIPMENT	PTN	PARTITION
ESMT	EASEMENT	PVA	POLYVINYL ACRYLIC
EST	ESTIMATE (D)	PVC	POLYVINYL CHLORIDE
EW	EACH WAY	PVG	PAVING
EXH	EXHAUST	QTY	QUANTITY
EXP	EXPANSION	R	RADIUS, RISER
EXT	EXTERIOR	RCP	REFLECTED CEILING PLAN
FAM	FLUID APPLIED MEMBRANE	RD	ROOF DRAIN, ROAD
FD	FLOOR DRAIN	REC	RECESSED
FDN	FOUNDATION	REF	REFER (ENCE), REFRIGERATOR
FE	FIRE EXTINGUISHER FINISH GRADE	REINF	REINFORCE (D), (ING)
F.G.		REQD	REQUIRED
FIN	FINISH (ED)	RESIL	RESILIENT
FL	FLASHING	REV	REVISION (S), REVISED
FLR	FLOOR	RH	"ROOF HATCH, RIGHT HAND"
FF	FINISH FLOOR	RHR	RIGHT HAND REVERSE
FM	FACTORY MANUAL FACE OF CONCRETE	RM	ROOM
FOC		RO	ROUGH OPENING
FOF	FACE OF FINISH FURNISHED BY OWNER INSTALLED BY CONTRACTOR	ROW	RIGHT OF WAY
FOIC		RPM	REVOLUTIONS PER MINUTE
FOIO	FURNISHED BY OWNER INSTALLED BY OWNER FACE OF MASONRY	RT	RIGHT
FOM		RWL	RAINWATER LEADER
FOS	FACE OF STUDS FROSTPROOF HOSE BIBB	S	SOUTH
FPHB		SAM	SELF-ADHERED MEMBRANE
FPL	FIREPLACE	SCHED	SCHEDULE
	FRAMING	SD	STORM DRAIN
FT	"FOOT, FEET" FOOTING	SF	SQUARE FOOT (FEET)
FTG		SHT	SHEET
	FURNITURE	SIM	SIMILAR
	NATURAL GAS	SP	STANDPIPE
GA	GAUGE "GALVANIZED, GALVANIC"	SPEC	SPECIFICATION
GALV		SQ	SQUARE
GAR	GARAGE	SQ IN	SQUARE INCH "SANITARY SEWER, STANDING SEAM"
GB	GRAB BAR	SS	
GC GEN	GENERAL CONTRACTOR GENERAL	SST STC	STAINLESS STEEL SOUND TRANSMISSION CLASS
GL	GLASS GLUED LAMINATED WOOD	STD STL	STANDARD
GOVT	GOVERNMENT	STOR	STEEL STORAGE
GSM GWB	GALVANIZED SHEET METAL GYPSUM WALL BOARD	STRUCT SUSP	STRUCTURE (AL) SUSPEND(ED)
HT	HEIGHT	T	TREAD TONGUE AND GROOVE
HB	HOSE BIBB	T&G	
HDR	HEADER	TBD	TO BE DETERMINED TEMPORARY
HDW	HARDWARE	TEMP	
HLDN	HARDWOOD	TFF	TOP OF FINISH FLOOR
	HOLDDOWN	THK	THICK (NESS)
HM	HOLLOW METAL	THRU	THROUGH
HO	HOLD OPEN	T.O.B.	TOP OF BEAM
HR	HORIZONTAL HOUR	T.O.C. T.O.S.	TOP OF CURB TOP OF STRUCTURE
	HOLLOW STRUCTURAL SECTION HEATING, VENTILATION, AND AIR CONDITIONING	T.O.W. TV	TOP OF WALL TELEVISION
HWH ID	HOT WATER HEATER INSIDE DIAMETER	TYP UBC	TYPICAL UNIFORM BUILDING CODE
IE IIC	INVERT ELEVATION IMPACT ISOLATION CLASS	UL UNO	UNDERWRITERS LABORATORIES UNLESS NOTED OTHERWISE
IN INCL	INCH (S) INCLUDING (ED)	UTIL VCT	UTILITY VINYL COMPOSITION TILE
INFO INSUL	INFORMATION INSULATION	VERT VIF	VERTICAL VERIFY IN FIELD
INT	INTERIOR JANITOR	V V W	VOLT "WEST, WIDTH, WASHER"
JAN		W/	WITH
JST	JOIST (S) KITCHEN		
KW	KITCHÈN	W/D	WASHER / DRYER
	KILOWATT	W/O	WITHOUT
JST KIT	KITCHÈŃ	W/D	WASHER / DRYER

MATERIAL LEGEND

MATERIAL LE	GEND
CEMENTITIOUS UNDERLAYMENT	
CONCRETE	
EARTH, UNDISTURBED	
EARTH, COMPACTED FILL	
GYPSUM WALL BOARD	11 S. J.
INSULATION - BATT	
INSULATION - RIGID	
ORIENTED STRAND BOARD	
PARTICLEBOARD	[+ (, ' +], -], - ; - ; - ; - ; - '-"
PLYWOOD	
POROUS FILL	
SAND, GROUT	
SPRAY FOAM	$\times \times \times \times \times \times$
STEEL, OTHER METALS	
WOOD - BLOCKING OR SHIM	
WOOD - FINISHED	

SYMBOL LEGEND

DOOR TAG

FINISH, FIXTURE, AND **EQUIPMENT TAG**

REVISION TAG /

REVISION CLOUD

WALL - NEW

WALL - EXISTING

WINDOW TAG

WALL - DEMOLITION

KEY NOTE PER LEGEND

-WALL ASSEMBLY TAG


8'-0"

(PF-1)




CEILING HEIGHT TAG COLUMN GRIDS DATUM / CONTROL POINT

ELEVATION - BUILDING DRAWING NUMBER SHEET NUMBER

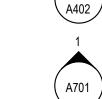




<u> ELEVATION - INTERIOR</u> DRAWING NUMBER

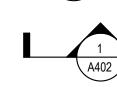


SHEET NUMBER

DRAWING NUMBER

SHEET NUMBER

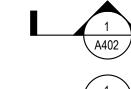

DRAWING NUMBER \A402 SHEET NUMBER

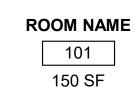

ROOM TAG ROOM NAME ROOM NUMBER ROOM AREA



NORTH ARROW

GENERAL NOTES

1. GENERAL

WOOD - GLUE LAMINATED

WOOD - NOMINAL LUMBER

A. THE CONTRACTOR SHALL BE GOVERNED BY ALL CONDITIONS AS INDICATED IN THE CONSTRUCTION DRAWINGS AND SPECIFICATIONS. CONSTRUCTION DRAWINGS AND SPECIFICATIONS ARE COMPLEMENTARY, AND WHAT IS CALLED FOR BY EITHER WILL BE BINDING AS IF CALLED FOR BY ALL. PROVIDE WORK SHOWN OR REFERRED TO ON ONE SET OF DRAWINGS AS THOUGH SHOWN ON ALL RELATED DRAWINGS

 $\longrightarrow \longrightarrow \longrightarrow$

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B. THE SPECIFICATIONS CONTAIN PERTINENT DETAILED INFORMATION ABOUT EACH BUILDING COMPONENT; THEY ARE A PART OF THE CONTRACT DOCUMENTS AND MUST BE USED IN CONJUNCTION WITH THE DRAWINGS.

C. ANY DISCREPANCIES BETWEEN EXISTING CONDITIONS AND CONTRACT DOCUMENTS SHOULD BE CALLED TO THE ATTENTION OF THE ARCHITECT.

D. THE CONTRACTOR SHALL BE RESPONSIBLE FOR SAFETY IN THE AREA OF WORK IN ACCORDANCE WITH ALL APPLICABLE SAFETY CODES

E. EACH CONTRACTOR/SUBCONTRACTOR IS RESPONSIBLE FOR ANY DAMAGE TO ADJACENT WORK AND IS RESPONSIBLE FOR THE REPAIR OF SAID DAMAGE AT THEIR OWN EXPENSE. TAKE CARE TO PROTECT EXISTING ARTWORK. F. THE CONTRACTOR SHALL VERIFY SITE CONDITIONS AND REPORT ERRORS AND OMISSIONS TO

THE ARCHITECT IMMEDIATELY IN WRITING. DO NOT VARY OR MODIFY THE WORK SHOWN EXCEPT UPON WRITTEN INSTRUCTIONS OF THE ARCHITECT. G. NO BUILDING COMPONENT SHOWN ON THESE DRAWINGS SHALL BE INCORPORATED INTO THE WORK UNTIL SHOP DRAWINGS, SAMPLES, BROCHURES OR OTHER SUBMITTALS CALLED FOR IN

THE SPECIFICATIONS HAVE BEEN APPROVED BY THE ARCHITECT. H. COORDINATE THE WORK OF DELEGATED DESIGNERS WITH THE WORK OF OTHER TRADES. ANY PERMITTING COSTS FOR DELEGATED DESIGN ARE THE RESPONSIBILITY OF THE GC AND/OR

 THE CONTRACTOR SHALL BE RESPONSIBLE FOR PROVIDING ALL WALL BLOCKING AS REQUIRED FOR ALL WALL AND CEILING MOUNTED ITEMS. PROVIDE BLOCKING OR OTHER CONCEALED SUPPORTS WITHIN WALLS AS REQUIRED FOR HANDRAILS, CASEWORK, GRAB BARS, ARTWORK SHELVING, AND OTHER APPLIED WALL/CEILING MOUNTED FIXTURES, FINISHES OR EQUIPMENT COORDINATE WITH THE ARCHITECT AND/OR OWNER LOCATION OF ALL MOUNTED ITEMS WHICH

J. ALL CONSTRUCTION SHALL BE STABILIZED AGAINST LATERAL MOVEMENT IN ACCORDANCE WITH REQUIREMENTS OF THE LATEST ADOPTED EDITION OF THE I.B.C. IN THE LOCAL JURISDICTION AND IN STRICT ACCORDANCE WITH THE STRUCTURAL DETAILS OF THIS SET OF

K. ALL WORK SHALL BE INSTALLED TRUE, PLUMB, SQUARE, LEVEL AND IN PROPER ALIGNMENT. L. OFFSET STUDS WHERE REQUIRED SO THAT FINISH WALL SURFACES WILL BE FLUSH.

M. FASTENERS IN CONTACT WITH TREATED WOOD SHALL BE CORROSION RESISTANT. N. MECHANICAL, ELECTRICAL, & FIRE PROTECTION CONDUCTED UNDER SEPARATE PERMIT & NOT PART OF THIS CONTRACT.

O. INSTALL ALL FIXTURES, EQUIPMENT, AND MATERIALS PER MANUFACTURER'S SPECIFICATION. P. EACH CONTRACTOR/SUBCONRACTOR SHALL BE RESPONSIBLE FOR LEAVING ALL AREAS CLEAN AND READY FOR THEIR INTENDED USE. Q. CONTRACTOR SHALL GUARANTEE ALL WORK AGAINST FAULT OF ANY MATERIAL OR

WORKMANSHIP FOR PERIOD OF ONE YEAR AFTER COMPLETION AND ACCEPTANCE. FAULTY WORK SHALL BE REPLACED OR REPAIRED AS REQUIRED AT CONTRACTOR'S EXPENSE. R. ALL EMERGENCY EXITS SHALL BE KEPT CLEAR AND ACCESSIBLE AT ALL TIMES.

2. CODES:

A. ALL WORK SHALL BE IN COMPLIANCE WITH ALL APPLICABLE FEDERAL, STATE, AND LOCAL CODES INCLUDING BUT NOT LIMITED TO THE 2018 SBC., THE GOVERNING ENERGY CODE AND MECHANICAL CODE WITHIN THE JURISDICTION OF THE PROJECT. IN CASE OF CONFLICT WHERE METHODS OR STANDARDS OF INSTALLATION OR MATERIALS SPECIFIED DO NOT EQUAL OR EXCEED THE REQUIREMENTS OF THE LAWS OR ORDINANCES, THE ORDINANCES SHALL GOVERN. NOTIFY THE ARCHITECT OF ANY CONFLICT.

IMPORTANT: IT IS THE RESPONSIBILITY OF THE GENERAL CONTRACTOR AND EACH AND EVERY SUBTRADE TO ENSURE EVERY ASPECT OF THIS WORK IS IN COMPLIANCE WITH THE PREVAILING CODES.

3. DRAWINGS:

A. THESE DRAWINGS ARE THE EXCLUSIVE PROPERTY OF THE ARCHITECT. AUTHORIZED

REPRODUCTION MUST BEAR THE NAME OF THE FIRM. B. IN CASE OF DISCREPANCY OR AMBIGUITY, CONTACT THE ARCHITECT FOR CLARIFICATION

PRIOR TO PROCEEDING WITH ANY WORK. C. DRAWINGS INDICATE GENERAL AND TYPICAL DETAILS OF CONSTRUCTION, WHERE CONDITIONS ARE NOT SPECIFICALLY INDICATED BUT ARE SIMILAR CHARACTER TO DETAILS

SHOWN, SIMILAR DETAILS OF CONSTRUCTION SHALL BE USED ONLY SUBJECT TO REVIEW AND APPROVAL BY THE ARCHITECT. D. CONTRACTOR SHALL FURNISH SHOP DRAWINGS FOR THE ARCHITECT'S APPROVAL PRIOR TO

MANUFACTURE OF ANY CABINET WORK, MILLWORK AND ANY OTHER SPECIAL ITEMS

REQUIRING CUSTOM SHOP FABRICATED WORK. E. DRAWINGS INCLUDE ABBREVIATIONS WHICH ARE IN COMMON USE. THE LIST OF ABBREVIATIONS PROVIDED IS NOT INTENDED TO BE COMPLETE OR REPRESENTATIVE OF CONDITIONS OR MATERIALS SPECIFICALLY USED ON THE PROJECT. THE ARCHITECT WILL DEFINE THE INTENT OF ANY DEFINITION OR TERM IN QUESTION.

4. SUPPLEMENTARY DRAWINGS AND SPECIFICATIONS:

A. STRUCTURAL, PLUMBING, MECHANICAL, ELECTRICAL AND FIRE PROTECTION DRAWINGS ARE SUPPLEMENTARY TO THESE DRAWINGS. THE CONTRACTOR SHALL COORDINATE THE WORK OF EACH CONSULTING ENGINEER WITH THESE DRAWINGS OR SPECIFICATIONS AND SHALL NOTIFY THE ARCHITECT OF ALL DISCREPANCIES WITH A WRITTEN REQUEST FOR CLARIFICATION. ANY WORK INSTALLED IN CONFLICT WITH THESE CONTRACT DOCUMENTS SHALL BE CORRECTED SOLELY AT THE EXPENSE OF THE CONTRACTOR.

5. DIMENSIONS:

- A. <u>DO NOT SCALE THESE DRAWINGS.</u> ALL INFORMATION SHOWN ON THE DRAWINGS RELATIVE TO EXISTING CONDITIONS IS GIVEN AS THE BEST PRESENT KNOWLEDGE BUT WITHOUT GUARANTEE OF ACCURACY. THE CONTRACTOR SHALL FIELD VERIFY EXISTING CONDITIONS AND DIMENSIONS AND SHALL NOTIFY THE ARCHITECT OF ANY DISCREPANCIES OR CONDITIONS ADVERSELY AFFECTING THE DESIGN PRIOR TO PROCEEDING WITH THE ITEM OF WORK AFFECTED.
- EXISTING EXTERIOR WALLS TO REMAIN INCLUDING THICKNESS OF FINISH MATERIALS DIMENSIONS FROM EXISTING WALLS ARE TO THE FINISHED FACE. DIMENSIONS FROM ALL NEW INTERIOR WALLS IS FROM FACE OF STRUCTURE.
- DIMENSIONS NOTED AS "CLEAR" ARE MEASURED FROM THE FACE OF THE DEEPEST PROTRUSION FROM THE WALL SURFACE (CASEWORK, FIXTURE, BASE, HANDRAIL, WAINSCOT,
- NOTES TO "ALIGN" REFER TO FINISHED FACE OF INDICATED SURFACES . WING WALLS ADJACENT TO CASEWORK SHALL BE 2'-2" LONG, UNLESS NOTED OTHERWISE

A. THE GENERAL CONTRACTOR SHALL BE RESPONSIBLE FOR THE VERIFICATION AND COORDINATION OF THE WORK OF ALL TRADES TO ASSURE COMPLIANCE WITH THE DRAWINGS AND SPECIFICATIONS.

7. FIRE PROTECTION:

A. FIRE PROTECTION CONTRACTORS SHALL PROVIDE FIRE PROTECTION DRAWINGS REQUIRED BY GOVERNING AUTHORITY. DRAWINGS SHOULD BE SUBMITTED TO THE ARCHITECT FOR REVIEW. B. PROVIDE FIRE PROTECTION AT ALL PENETRATIONS OF FIRE RATED ELEMENTS REQUIRED BY

THE FIRE OFFICIAL. C. EXISTING FIRE ALARM SYSTEMS SHALL REMAIN INTACT AND OPERABLE AT ALL TIMES. IF APPLICABLE.

. ELECTRICAL NOTES:

A. THE ELECTRICAL CONTRACTOR SHALL BE RESPONSIBLE FOR MAINTAINING COMPLIANCE WITH

ALL CODES AND OBTAINING ALL NECESSARY PERMITS. B. ALL DEVIATIONS FROM DIMENSIONED LOCATIONS MUST BE APPROVED BY THE ARCHITECT. THE ELECTRICAL CONTRACTOR SHALL VERIFY THE LOCATION OF EACH CORE DRILL WITH THE EXISTING STRUCTURE, PIPING, CONDUIT, ETC. AND SHALL NOTIFY THE ARCHITECT OF ANY CONFLICTS OR OBSTRUCTIONS.

D. ALL NEW ELECTRICAL/TELEPHONE OUTLETS ARE TO BE MOUNTED VERTICALLY AT 15" AFF TO BOTTOM OF OUTLET UNLESS NOTED. ALL WALL MOUNTED RECEPTACLES LOCATED IN CASEWORK ARE TO BE MOUNTED HORIZONTALLY UNLESS OTHERWISE NOTED.

SPECIAL HEIGHTS ARE NOTED ADJACENT TO THE OUTLET. THE ELECTRICAL CONTRACTOR SHALL INCLUDE THE CODE REQUIRED NUMBER, SPACING, AND TYPE OF ELECTRICAL OUTLETS IN THEIR BID PROPOSAL AND PROVIDE THOSE FOR THE PROJECT, EVEN IF THOSE OUTLETS ARE IN EXCESS OF WHAT IS INDICATED ON THE

DRAWINGS G. ELECTRICAL FIXTURES SHALL BE DIMMABLE PER THE ELECTRICAL DRAWINGS.

9. MECHANICAL NOTES:

A. EXISTING DUCTED VAV SYSTEM TO BE MODIFIED AS NEEDED TO ACCOMODATE PROPOSED

B. ALL HVAC SYSTEMS ARE TO COMPLY WITH ALL APPLICABLE CODES.

C. THE CONTRACTOR SHALL VERIFY SIZES AND LOCATIONS OF ALL OPENINGS FOR MECHANICAL EQUIPMENT WITH MECHANICAL DRAWINGS AS WELL AS SHOP DRAWINGS BEFORE PROCEEDING

10. ACCESSIBILITY

A. REFER TO G3XX SERIES FOR SPECIFIC ACCESSIBILITY REQUIREMENTS PERTAINING TO OUTLET LOCATIONS AND HEIGHTS, SWITCH LOCATIONS AND HEIGHTS, GRAB BARS, WALL BLOCKING, FLOOR CLEARANCES, COUNTER TOP HEIGHTS, LOCATION OF PLUMBING CONTROLS, ETC.

B. CHANGES IN FINISH FLOOR ELEVATION IN EXCESS OF 1/4", MEASURE FROM LOWEST POINT ON EITHER SIDE OF THRESHOLD TO HIGHEST POINT ON THRESHOLD, SHALL BE BEVELED AT 1:2. IN NO CASE SHALL FLOOR TRANSITIONS AND CHANGES IN LEVEL IN FLOOR SURFACE BE MORE THAN 1/4" MAX IN VERTICAL HEIGHT.

11. SIGNAGE

A. PROVIDE SIGNAGE AT EACH EXIT ACCESS DOORWAY AND AT EXIT DISCHARGE IN

ACCORDANCE WITH SBC 1009.9 AND ICC/ANSI 117.1 B. REFER TO SPECIFICATIONS & DRAWINGS FOR LOCATION, TYPE, & DESIGN OF ALL SIGNAGE

C. EXTERIOR BUILDING SIGNAGE AND ENTRY VESTIBULE SIGNAGE ARE N.I.C.

12. FINISH NOTES:

A. ALL FINISH MATERIAL COLORS SHALL MATCH ARCHITECT'S CONTROL SAMPLES AND REQUIRE THE ARCHITECT'S APPROVAL PRIOR TO INSTALLATION.

13. DESIGN-BUILD MEP:

A. THE MEP SCOPE OF THIS PROJECT, INCLUDING COMMUNICATIONS & FIRE PROTECTION, IS DESIGN-BUILD. ARCHITECT HAS INDICATED MINIMUM REQUIREMENTS FOR POWER, COMMUNICATIONS, EXIT SIGNS, AND LIGHTING SELECTION AND PLACEMENT.

B. DESIGN-BUILD EFFORTS SHALL INCLUDE THOSE MINIMUM COMPONENTS, PLUS COMPLIANCE WITH ANY ADDITIONAL CODE REQUIREMENTS, INCLUDING BUT NOT LIMITED TO, THE REQUIRED NUMBER, SPACING, AND TYPE OF MEP ELEMENTS EVEN IF THOSE ARE IN EXCESS TO WHAT IS INDICATED IN THESE DRAWINGS.

C. THE DESIGN-BUILD HVAC SCOPE INCLUDES ASSESSING THE EXISTING HVAC SYSTEM ON SITE, DESIGN ALTERATIONS & ANY NECESSARY ADDITIONS TO ACCOMODATE THE NEW PLAN LAYOUT, DEFERRED SUBMITTAL APPROVAL FROM THE AHJ, AND INSTALLATION OF SAID COMPONENTS. D. VISUAL DESIGN INTENT IS FOR A TIDY, ORGANIZED INSTALLATION WITH BUNDLED CONDUIT

IN SINGLE PATHWAYS WHERE POSSIBLE, DIRECT VENTING AND DIFFUSERS ON SPIRAL

DUCTWORK, AND RAW, UNPAINTED FINISHES. WHERE NECESSARY, RUN BRANCH LINES IN

ORDERLY LAYOUT. ALL MEP DESIGN-BUILD WORK IS TO BE SUBMITTED TO THE ARCHITECT & OWNER FOR

CAMAS PUBLIC LIBRARY

CAMAS LIBRARY INTERIOR BUILDING IMPROVEMENTS



DRAWING INDEX

PROJECT INFORMATION

G001 GENERAL NOTES, ABBREVIATIONS, SYMBOLS CODE SUMMARY

G003 ICC ACCESSIBILITY & MOUNTING REQUIREMENTS

V001 SURVEY

LEVEL 1 - OVERALL FLOOR PLAN LEVEL 1 - DEMOLITION FLOOR PLANS A210 A211 LEVEL 1 - DEMOLITION RCPS

LEVEL 1 - ENLARGED PLANS LEVEL 1 - REFLECTED CEILING PLAN LEVEL 1 - ENLARGED RCPS

A611 LEVEL 1 - ENLARGED RCPS FINISH SCHEDULE & LEGEND INTERIOR ELEVATIONS INTERIOR ELEVATIONS

INTERIOR ELEVATIONS A950 HVAC RELOCATION INTERIOR DETAILS

INTERIOR DETAILS INTERIOR DETAILS - DISCOVERY HALLWAY

ELECTRICAL

SYMBOL LIST AND GENERAL NOTES - ELECTRIC LUMINAIRE SCHEDULE - LIGHTING

LEVEL 1 DEMILITION PLAN - LIGHTING LEVEL 1 DEMOLITION PLAN - POWER LEVEL 1 CEILING PLAN - LIGHTING F301

LEVEL 1 FLOOR PLAN - POWER LEVEL 1 ENLARGED PLAN - CHILDREN'S LIBRARY - POWER

LEVEL 1 ENLARGED PLAN - NON-FICTION - POWER E452 E501 SINGLE LINE DIAGRAMS - ELECTRICAL

SCHEDULES - ELECTRICAL **DETAILS - ELECTRICAL** E701

PROJECT INFORMATION

OWNER: CAMAS PUBLIC LIBRARY

ADDRESS: 625 NE 4TH AVE, CAMAS, WA 98607

PARCEL #S: 78700000, 78710000, 78720000, 78730000

PROJECT DESCRIPTION: INTERIOR RENOVATION OF EXISTING LIBRARY; NEW FINISHES, ELECTRICAL, AND CASEWORK

LEGAL DESCRIPTION: CAMAS LOTS 1 THROUGH 7 BLK 35

PROJECT TEAM

CONTRACTOR: CAMAS PUBLIC LIBRARY 625 NE 4TH AVE CAMAS, WA 98607 PH: 360-817-7201

CONTACT: CONNIE URQUHART

CURQUHART@CITYOFCAMAS.US ARCHITECT: 3131 WESTERN AVE, SUITE 510

SEATTLE WA 98121 PH: (206) 523-6150 CONTACT: SARAH BURK SBURK@JOHNSTONARCHITECTS.COM

LANDSCAPE: LANGO HANSEN 1100 NE GLISAN, #3A

PORTLAND, OR 97209 PH: (206) 523-6150 CONTACT: KATHERINE SHEIE KATHERINE@LANGOHANSEN.COM

VICINITY MAP



CATENA CONSULTING FNGINFERS


1500 NE IRVING STREET, SUITE 412

JARED@CATENAENGINEERS.COM


PORTLAND, OR 97232

CONTACT: JARED LEWIS

PH: (503) 380-8760

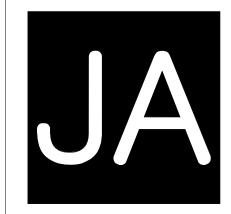

Johnston Architects, LLC 3131 Western Ave. Suite 510 Seattle, WA 98121 t 206.523.6150 f 206.523.9382

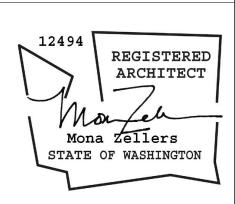


DING BUIL

DRAWING ISSUE # DATE DESCRIPTION 10/10/2025 100% CONSTRUCTION DOCUMENTS

SHEET TITLE GENERAL NOTES, ABBREVIATIONS,

SHEET NO.

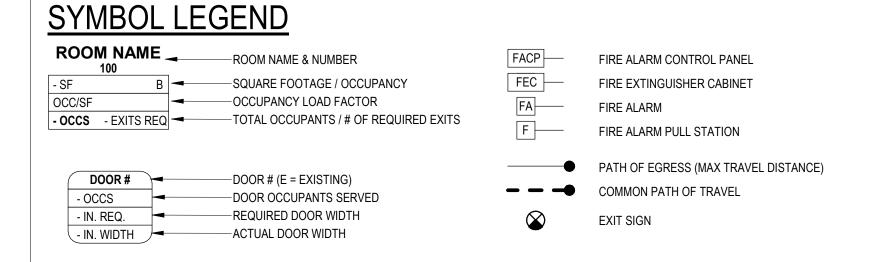


APPLICABLE CODES

ZONING CODE: CITY OF CAMAS **BUILDING CODE:** 2021 INTERNATIONAL BUILDING CODE **ENERGY CODE:** 2021 WASHINGTON STATE ENERGY CODES (WSEC) 2021 UNIFORM PLUMBING CODE (UPC) PLUMBING CODE: 2021 INTERNATIONAL MECHANICAL CODE **MECHANICAL CODE: ELECTRICAL CODE:** 2020 WASHINGTON CITIES ELECTRICAL CODE 2017 NATIONAL ELECTRICAL CODE FIRE PROTECTION: 2021 INTERNATIONAL FIRE CODE ACCESSIBILITY:

2017 ICC A117.1 ACCESSIBLE AND USEABLE BUILDINGS AND FACILITIES IBC CHAPTER 11 AND APPENDIX E FOR ACCESSIBILITY

DEFERRED SUBMITTALS

• MEP EQUIPMENT, ANCHORAGE, AND BRACING CEILING AND CEILING SUPPORTS LOW VOLTAGE CONSTRUCTION (ROW) PERMIT

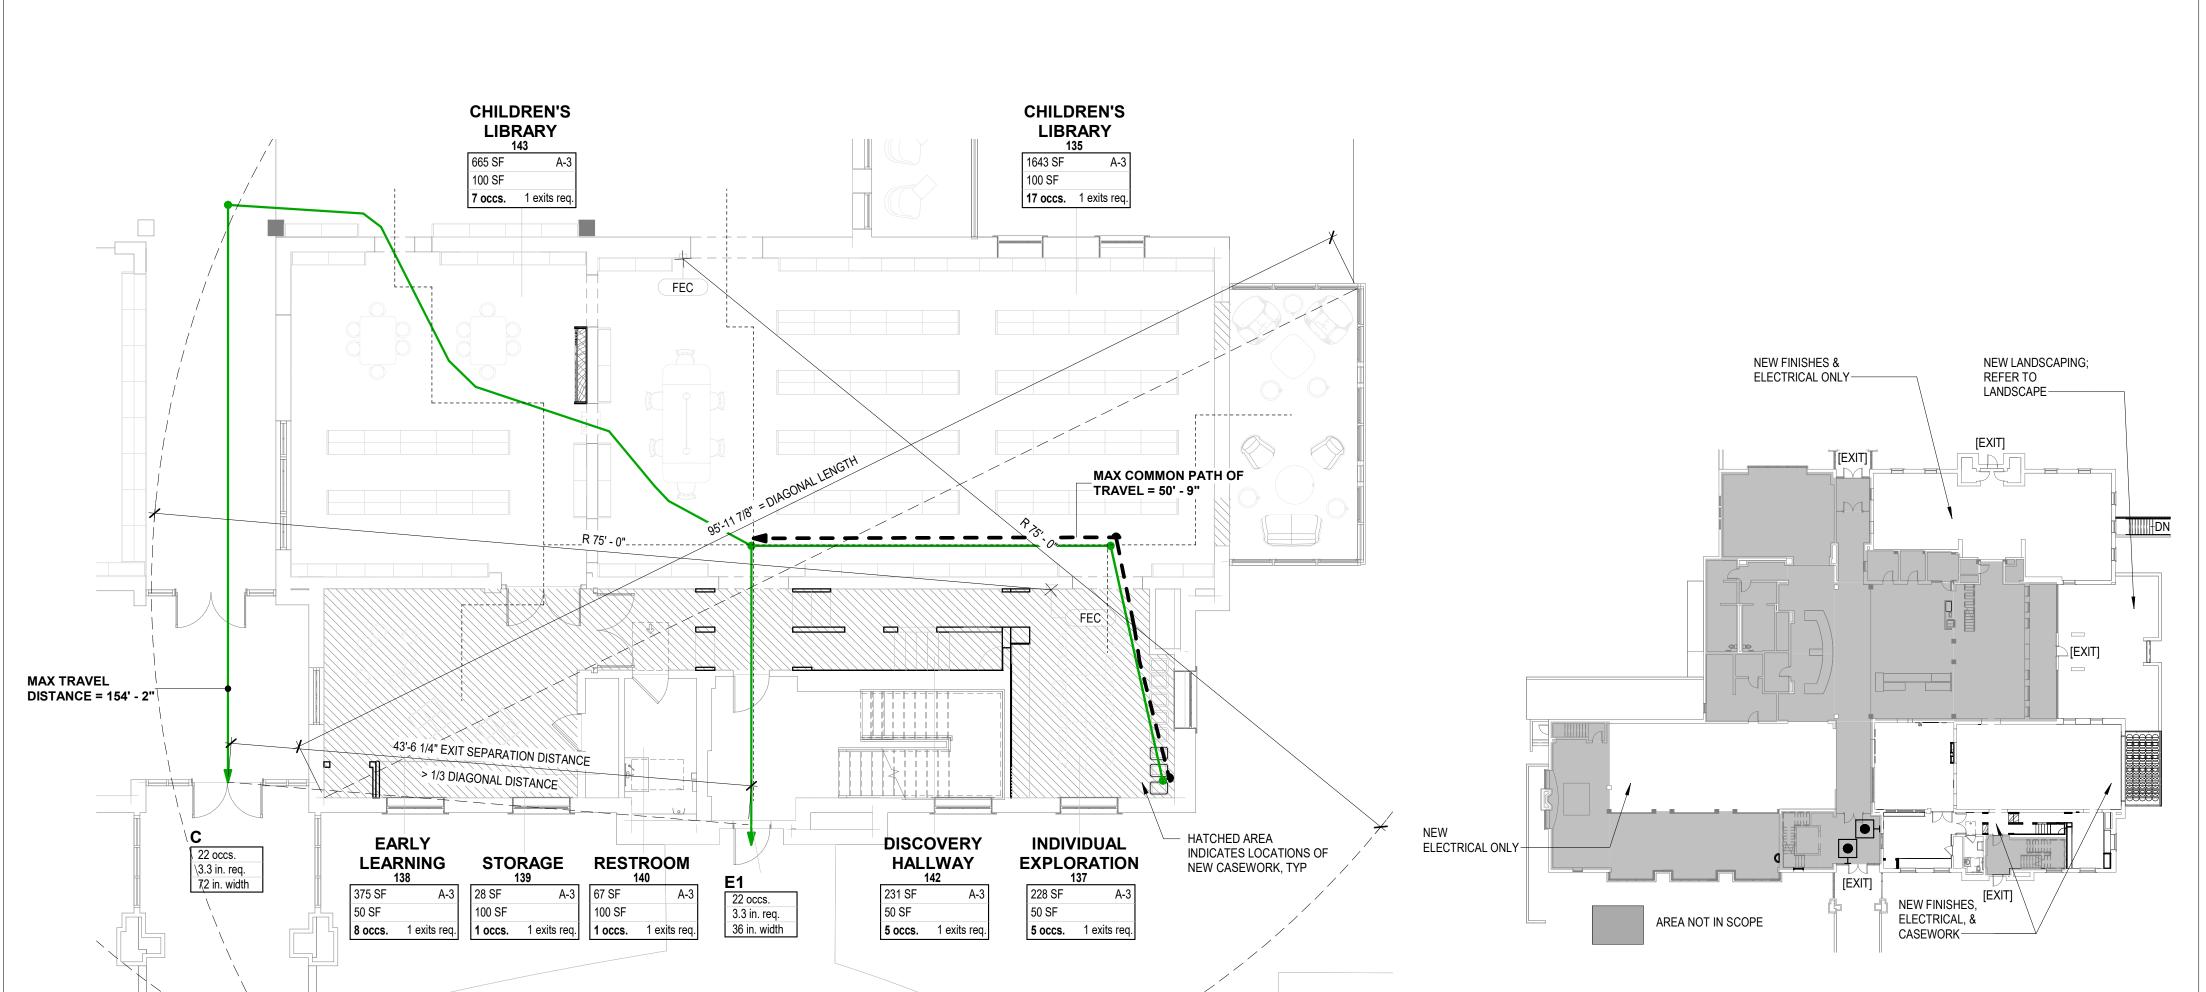

LEVEL 1 - EGRESS PLAN SCALE: 1/8" = 1'-0"

LEVEL 1 - SCOPE OF WORK SCALE: 1" = 30'-0"

BUILDING CODE SUMMARY:

PROJECT ADDRESS: 625 NE 4TH AVE CAMAS, WA 98607

DESCRIPTION: THIS PROJECT IS A PROPOSED RENOVATION OF AN EXISTING PUBLIC LIBRARY WITH ASSOCIATED BUSINESS AREAS. NO

CHANGE OF OCCUPANCY IS PROPOSED.

ORIGINAL PERMIT #:

ZONING: DC (DOWNTOWN COMMERCIAL)

CONSTRUCTION TYPE: V-A (EXISTING)

BUILDING HEIGHT: NO MAXIMUM HEIGHT FOR DC ZONE PER 18.09.030 TABLE 1 NO CHANGE TO STRUCTURE HEIGHT PROPOSED

SPRINKLER: FIRE ALARM:

BUILDING AREA (ABOVE GRADE): EXISTING LEVEL 1 EXISTING LEVEL 2 8,455 SF TOTAL BUILDING AREA 26,303 SF PROJECT AREA: 10,672 SF

CHAPTER 3: USE AND OCCUPANCY CLASSIFICATION

302: OCCUPANCY CLASSIFICATION

OCCUPANCY: LIBRARY - A-3 (NO PROPOSED CHANGE) OFFICE - B-2

CHAPTER 5: GENERAL BUILDING HEIGHTS AND AREAS

508.3: MIXED OCCUPANCY STRATEGY

NON-SEPERATED OCCUPANCIES CHAPTER 6: TYPES OF CONSTRUCTION

TABLE 601: FIRE-RESISTANCE RATING REQUIREMENTS FOR BUIDING ELEMENTS

EXISTING - TYPE VA (SPRINKLERED) STRUCTURAL FRAME: BEARING WALLS EXT: BEARING WALLS INT: 1 HR NON-BEARING WALLS EXT: NON-BEARING WALLS INT: 0 HR FLOORS: ROOF:

CHAPTER 9: FIRE PROTECTION SYSTEMS

• AS REQUIRED BY CODE - SEE PLANS FOR LOCATIONS AND SPECIFICATIONS FOR FIRE PROTECTION SPECIALTY EQUIPMENT

• TYPE: 2A10BC W/ 75' MAX TRAVEL DISTANCE

CHAPTER 10: MEANS OF EGRESS

OCCUPANCY LOAD: 295 (REFER TO OCCUPANCY LOAD TABLE) EMPLOYEE COUNT:

1004.3: POSTING OF OCCUPANT LOAD

EVERY ROOM OR SPACE THAT IS AN ASSEMBLY OCCUPANCY SHALL HAVE THE OCCUPANT LOAD OF THE SPACE POSTED IN A CONSPICUOUS PLACE, NEAR THE MAIN EXIT FROM THE ROOM OR SPACE. POSTED SIGNS SHALL BE OF AN APPROVED LEGIBLE PERMANENT DESIGN AND SHALL BE MAINTAINED BY THE OWERN. PROVIDE (1) SIGN PER ROOM OR SPACE.

SEE PLAN

3,239 SF 3,239 SF

1005.3.2: EGRESS DOOR MIN ALLOWABLE WIDTH

0.2X OCCUPANT LOAD EGRESS WIDTH (INCHES) REQUIRED: • EGRESS WIDTH (INCHES) PROVIDED: SEE PLAN

1006.2.1: COMMON PATH OF EGRESS

 MAXIMUM COMMON PATH OF TRAVEL: COMMON PATH OF TRAVEL PROVIDED:

1006.3.2: MINIMUM NUMBER OF EXITS OR ACCESS TO EXITS PER STORY • NUMBER OF EXITS REQUIRED:

NUMBER OF EXITS PROVIDED:

1007.1.1: EXIT ACCESS DOORWAYS SEPARATION • EXIT SEPARATION REQUIRED: > 1/2 DIAGONAL


• EXIT SEPARATION PROVIDED:

1017.2: EXIT ACCESS TRAVEL DISTANCE

• MAXIMUM EXIT ACCESS TRAVEL DISTANCE: 200' • EXIT ACCES TRAVEL DISTANCE PROVIDED: SEE PLAN

OCCUPANCY LOAD (IBC TABLE 1004.5)

RM#	ROOM NAME	OCCUPANCY TYPE	LOAD FACTOR	AREA	OCCUPANTS
135	CHILDREN'S LIBRARY	A-3	100 SF	1,643 SF	17
137	INDIVIDUAL EXPLORATION	A-3	50 SF	228 SF	5
138	EARLY LEARNING	A-3	50 SF	375 SF	8
139	STORAGE	A-3	100 SF	28 SF	1
140	RESTROOM	A-3	100 SF	67 SF	1
142	DISCOVERY HALLWAY	A-3	50 SF	231 SF	5
143	CHILDREN'S LIBRARY	A-3	100 SF	665 SF	7
LEVEL	1: 7			3,239 SF	44

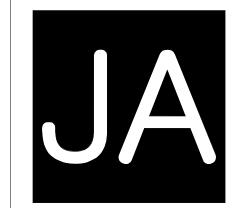


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DRAWING ISSUE # DATE DESCRIPTION 10/10/2025 100% CONSTRUCTION DOCUMENTS






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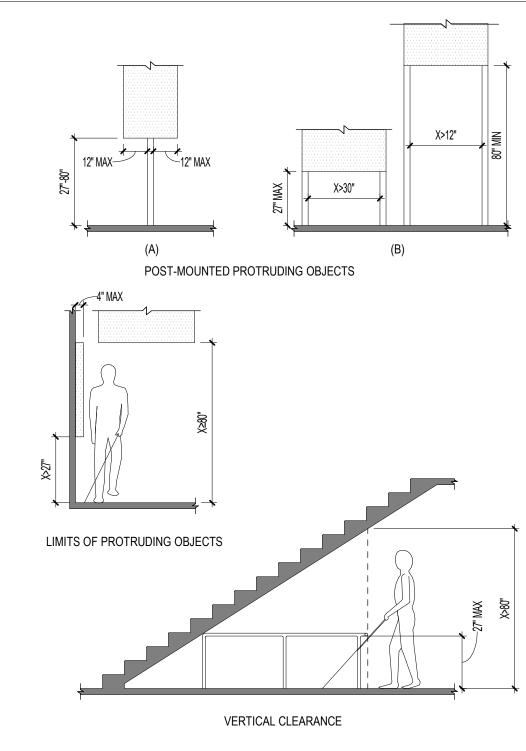
CODE SUMMARY

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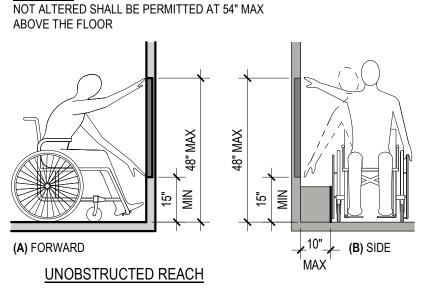
G002

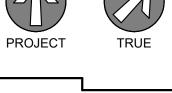
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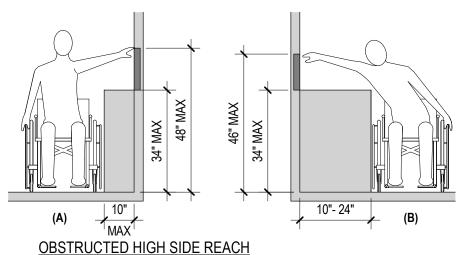







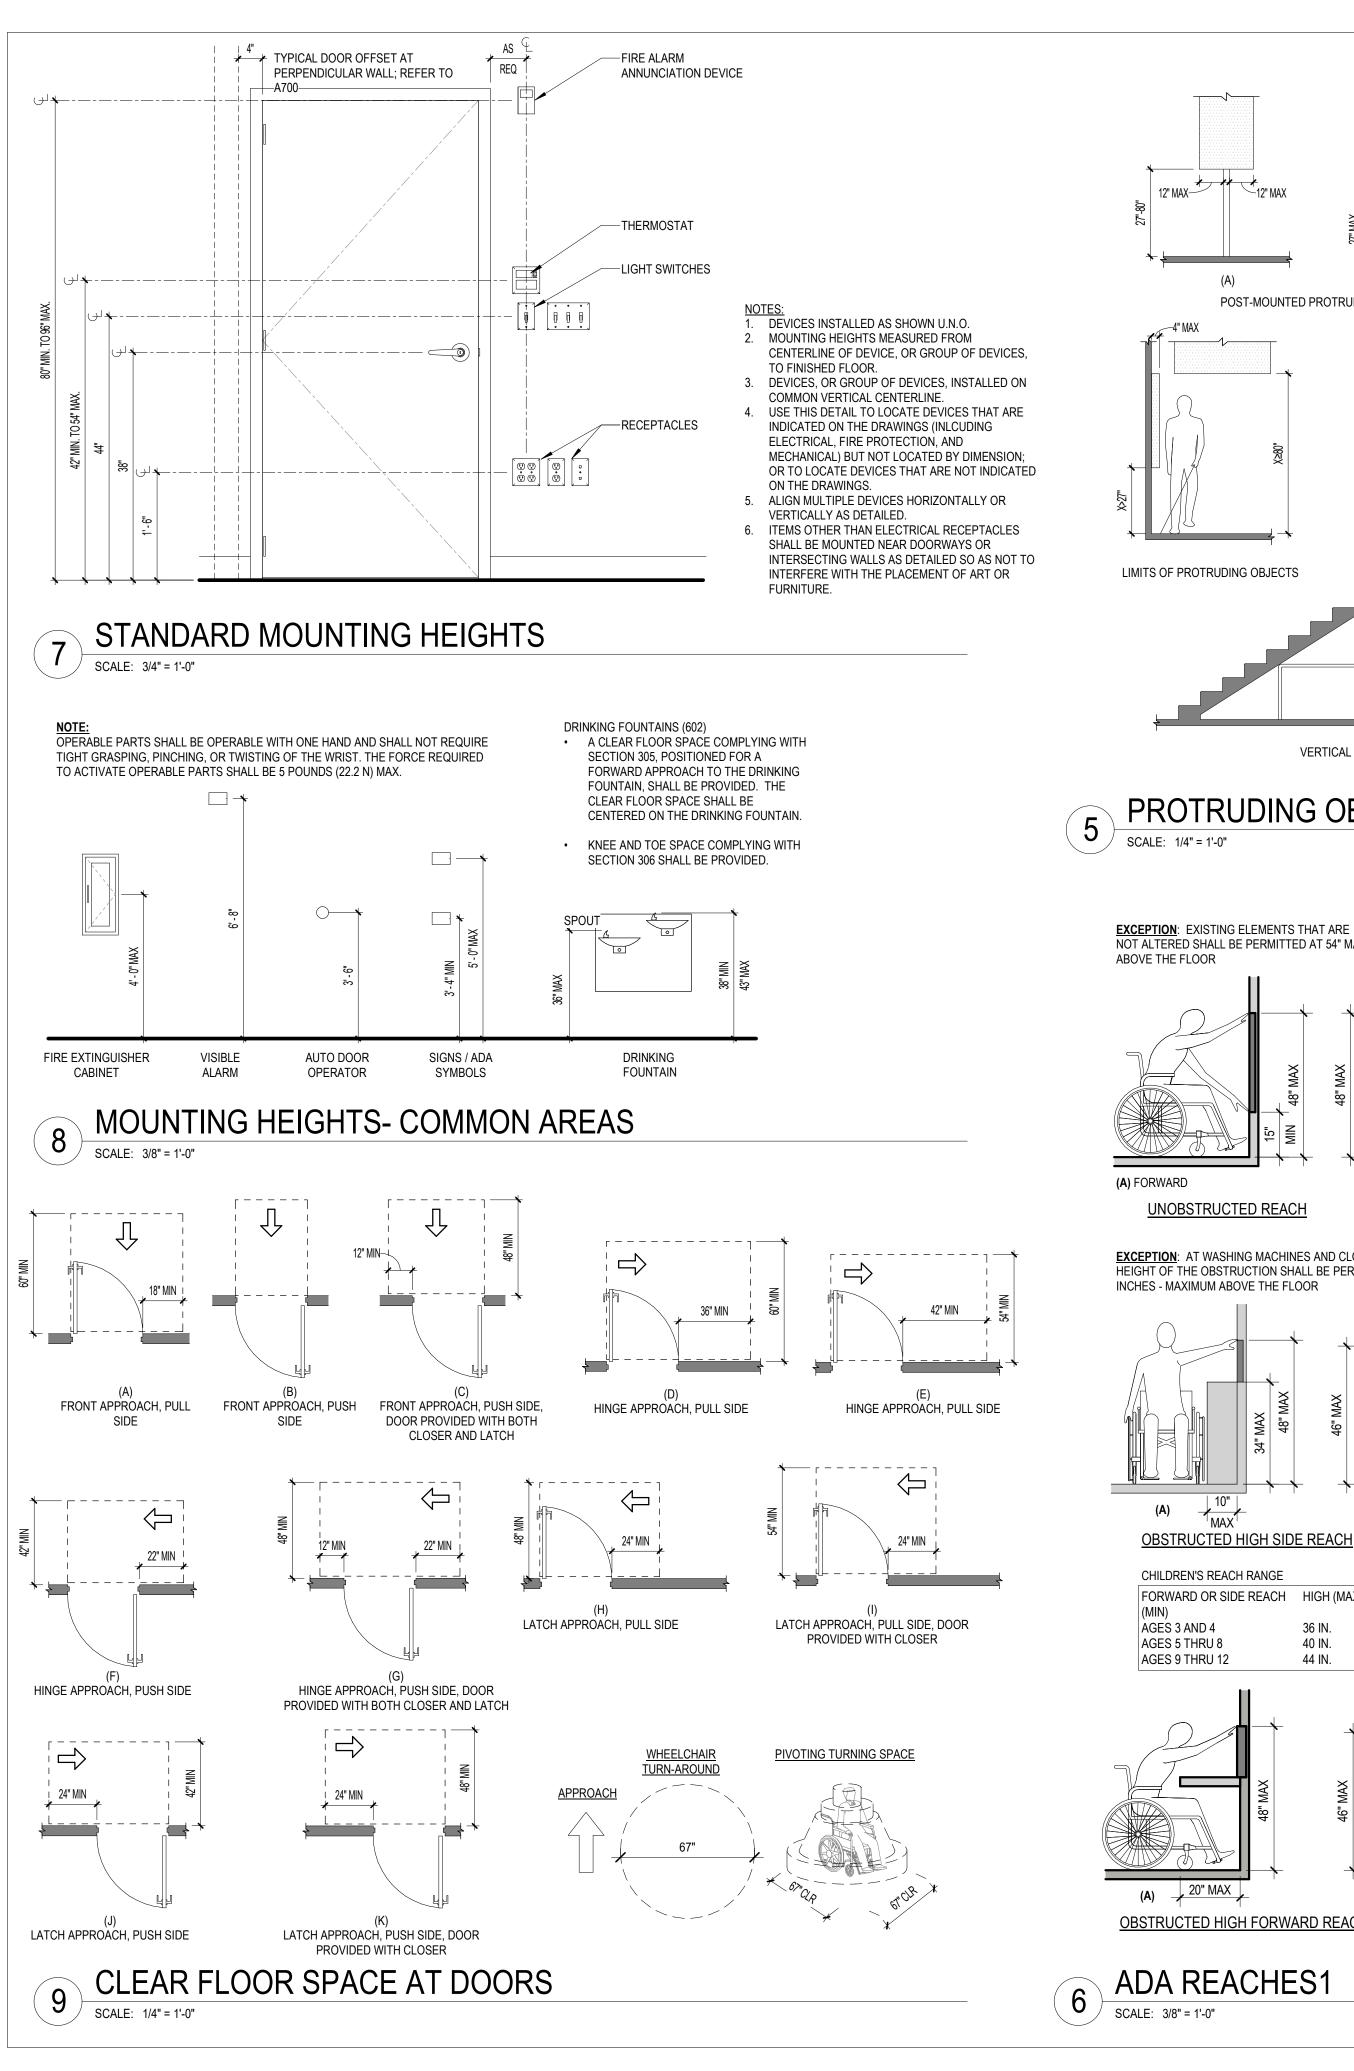



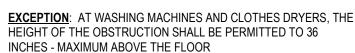

CHILDREN'S REACH RANGE FORWARD OR SIDE REACH HIGH (MAX) LOW 20 IN. 18 IN. AGES 3 AND 4 40 IN.

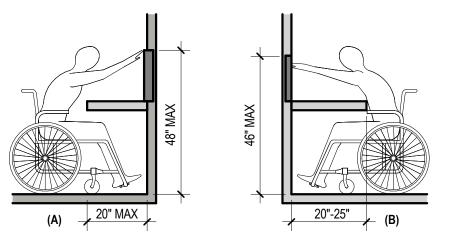


44 IN.


16 IN.

OBSTRUCTED HIGH FORWARD REACH




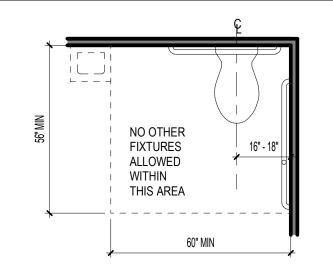


CLEARANCE FOR WATER CLOSET WHEELCHAIR ACCESSIBLE TOILET COMPARTMENTS

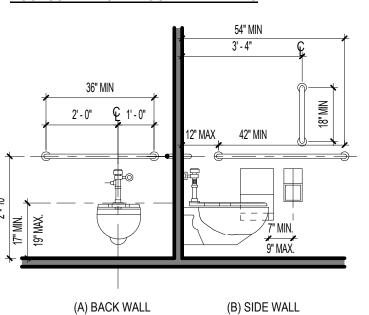


GRAB BAR LOCATIONS

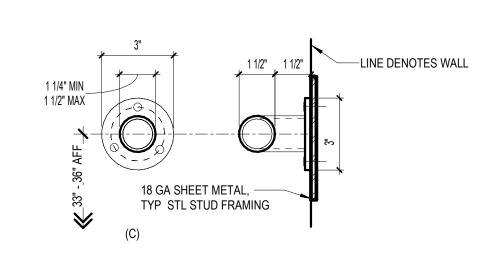


GRAB BAR SIZING & CONFIGURATION

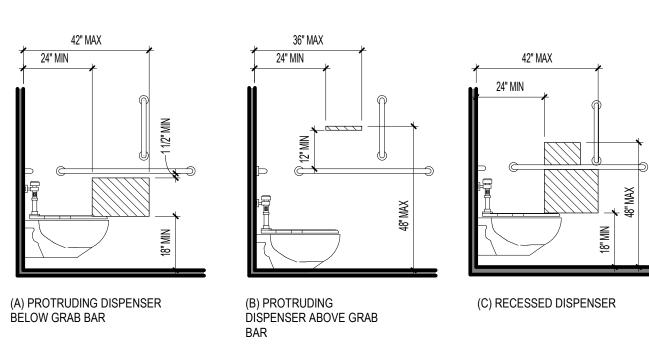


DISPENSER OUTLET LOCATION

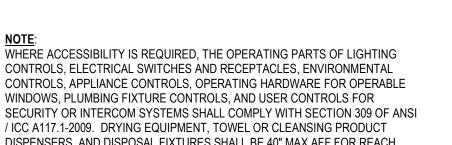

SECURITY OR INTERCOM SYSTEMS SHALL COMPLY WITH SECTION 309 OF ANSI / ICC A117.1-2009. DRYING EQUIPMENT, TOWEL OR CLEANSING PRODUCT DISPENSERS, AND DISPOSAL FIXTURES SHALL BE 40" MAX AFF FOR REACH DEPTHS LESS THAN 6" PER IBC 1101.2.7 AND WAC AMENDMENTS. HAND-OPERATED FAUCETS OPERABLE PARTS SHALL BE WITHIN REACH RANGE

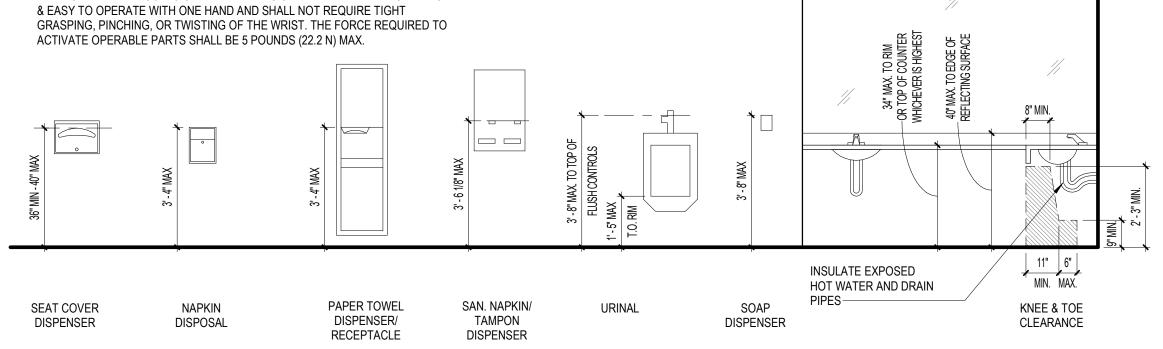




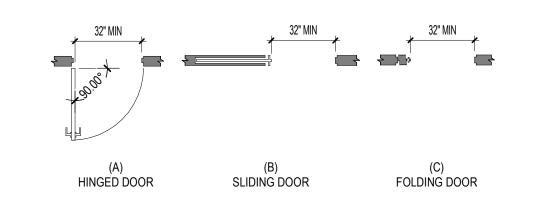



CHANGE OF LEVEL



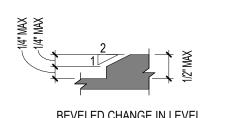




36" MIN

MANUEVERING CLEARANCE IN AN

ALCOVE, FORWARD APPROACH

CLEAR FLOOR OR GROUND

SPACE

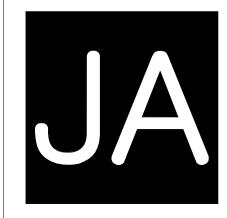

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SHEET TITLE ICC ACCESSIBILITY & MOUNTING **REQUIREMENTS**

SHEET NO.

52" MIN

(B) PARALLEL

POSITION OF CLEAR FLOOR OR

60" MIN

MANUEVERING CLEARANCE IN AN


ALCOVE, PARALLEL APPROACH


GROUND SPACE

(A) FORWARD

G003


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PREPARED BY:

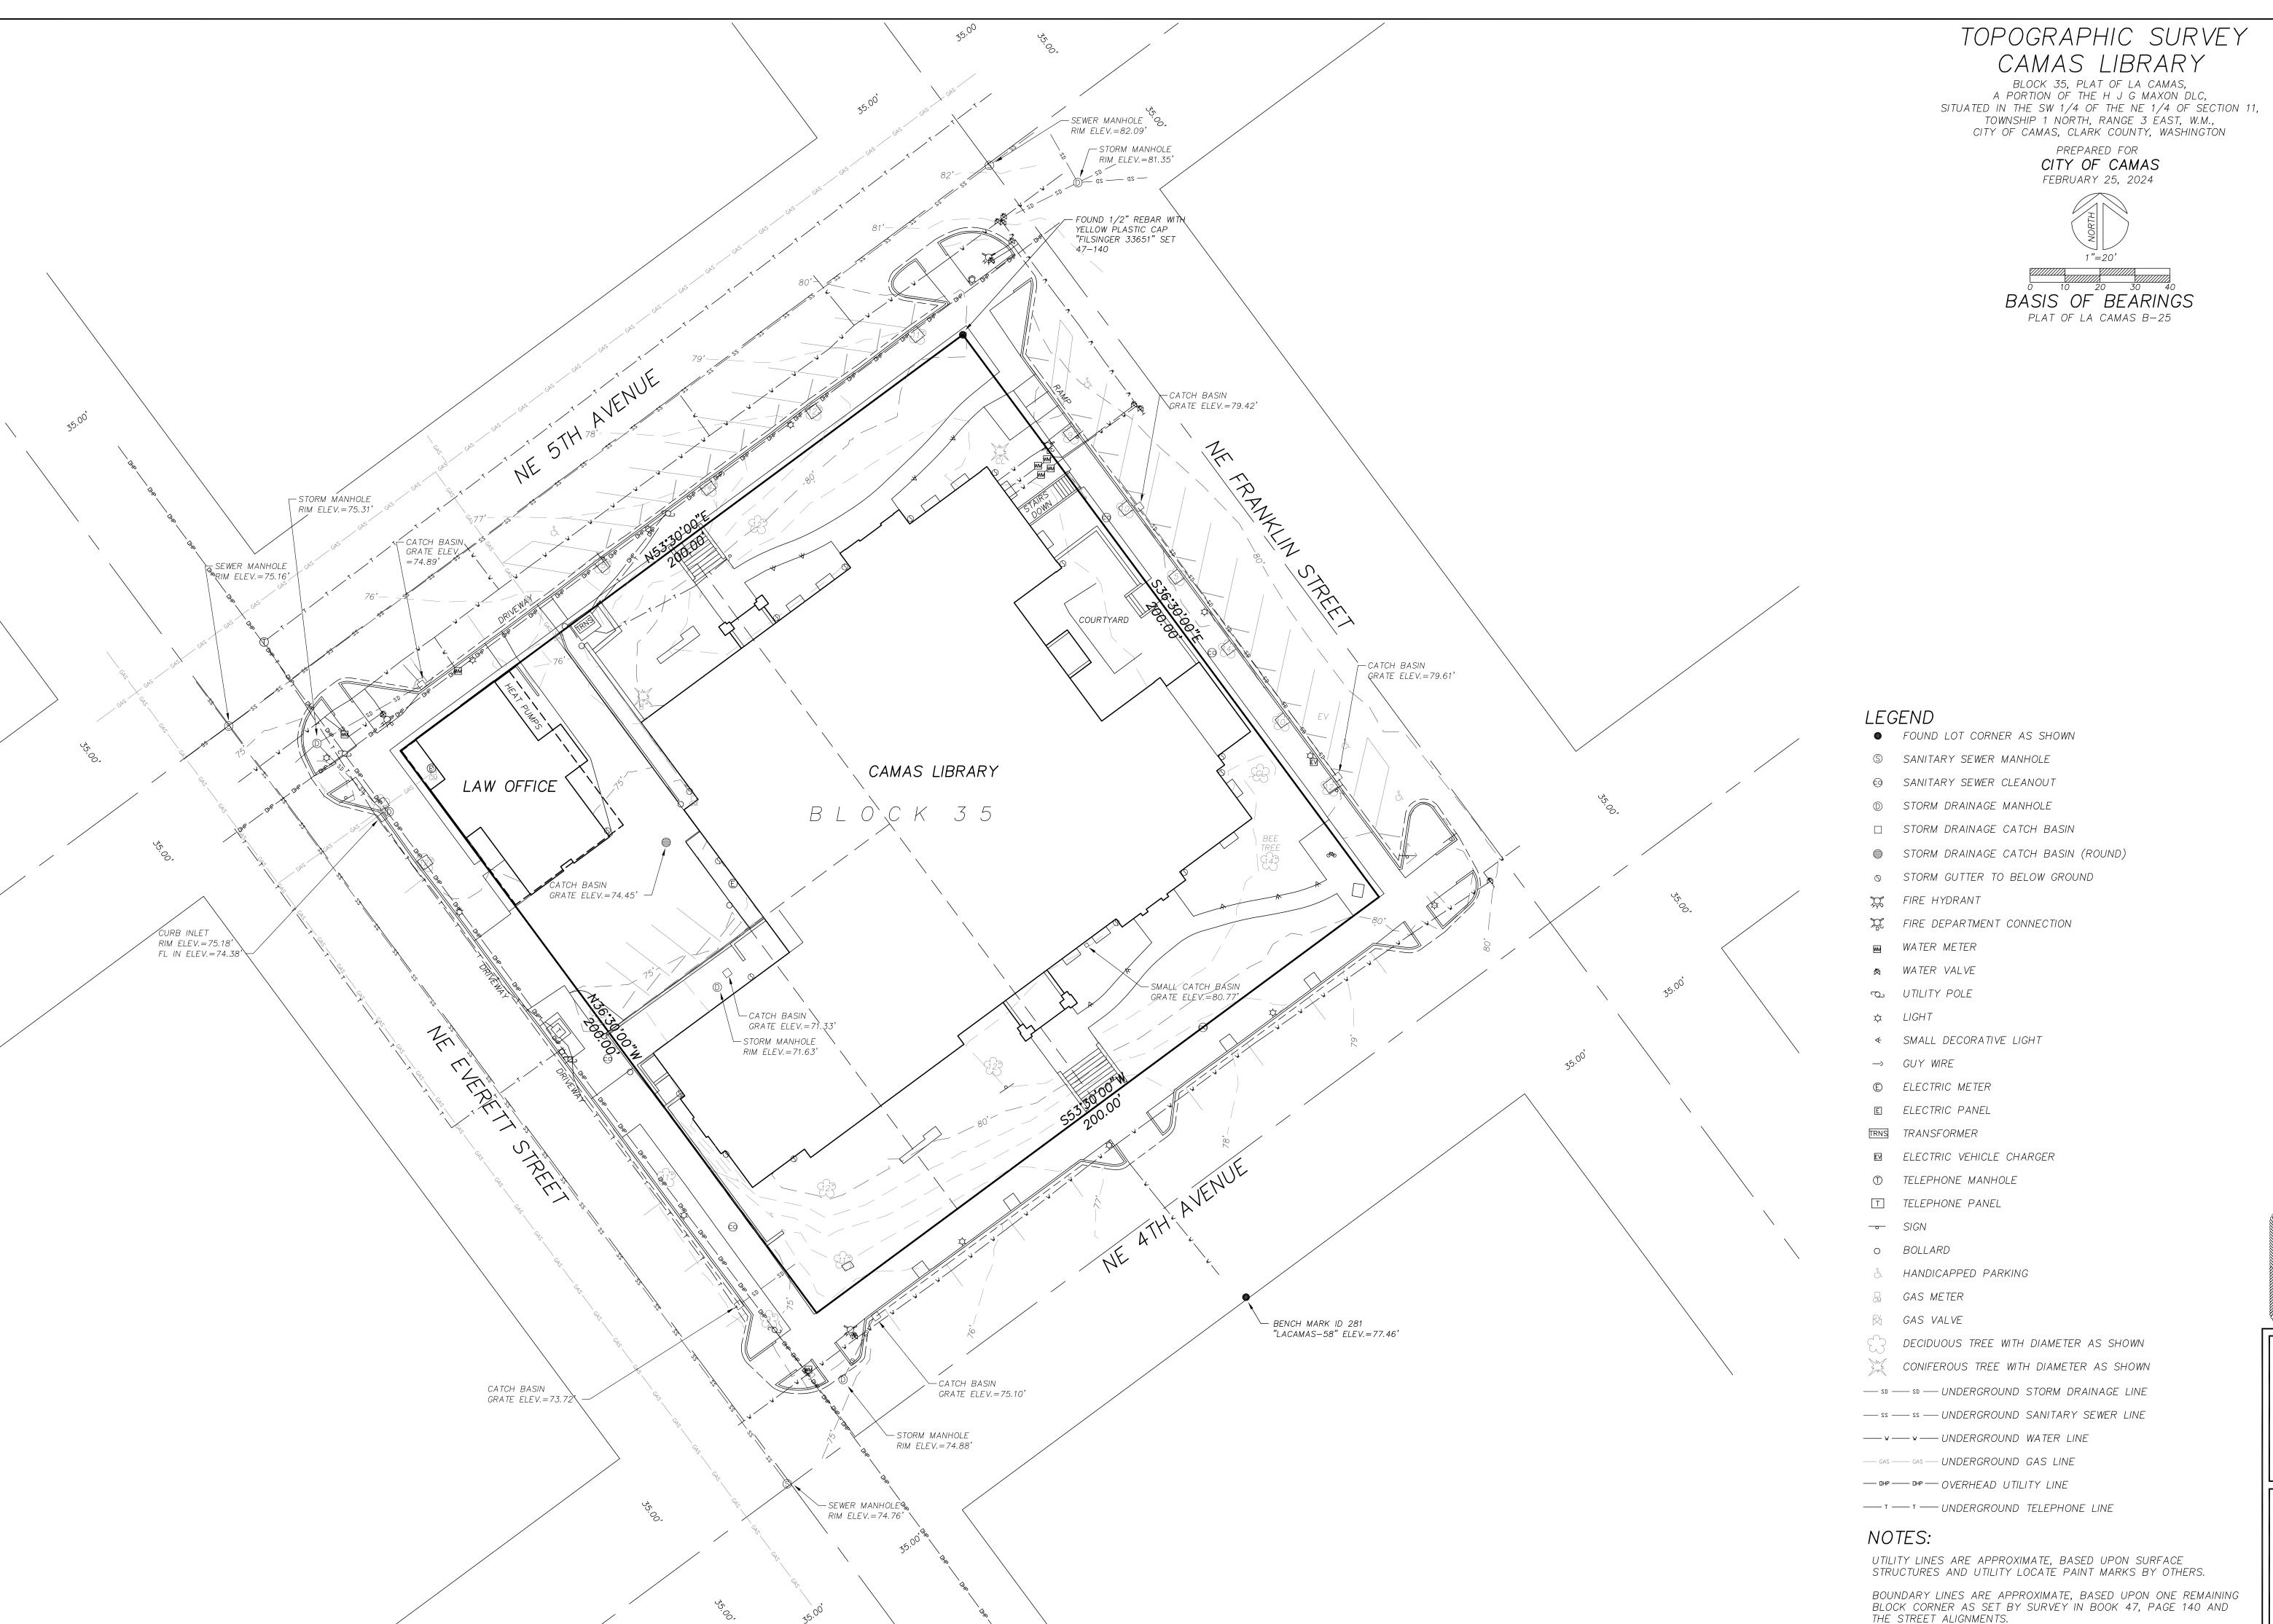DEVELOPMENT ~A CERTIFIED DBE & WBE

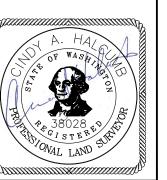

ADD ALTERNATES

INT:ALT-A FABRICATION AND INSTALLATION OF KID LIBRARIAN CASEWORK FEATURE
- CHILDREN'S LIBRARY 143

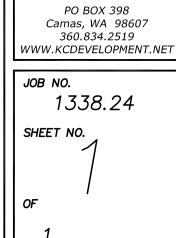DEMOLITION KEYNOTES


- D.14 REMOVE BOOK STACKS FOR FLOORING DEMOLITION; REINSTALL IN SAME LOCATION
- D.15 REMOVE CARRELS FOR FLOORING DEMOLITION; REINSTALL IN SAME LOCATION

NEW CONSTRUCTION KEYNOTES

- PATCH AND REPAIR ALL WALLS TO LIKE-NEW, UNIFORM, FINISH-READY APPEARANCE. ALL WALLS TO RECEIVE NEW PAINT AS SCHEDULED.
 PROVIDE AND INSTALL NEW CARPET TILE AS SCHEDULED.
- PROVIDE AND INSTALL NEW RUBBER BASE AS SCHEDULED.
 PROVIDE AND INSTALL NEW WOOD BASE AS SCHEDULED.

PLAN GENERAL NOTES

- REFER TO SHEET G001 FOR NOTES APPLICABLE TO ALL PORTIONS OF THE WORK.
- SEE ENLARGED PLANS FOR ADDITIONAL SCOPE OF WORK AND GENERAL NOTES. REFER TO DEMOLITION PLANS FOR DEMOLITION SCOPE.

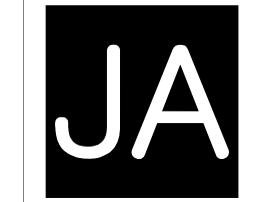

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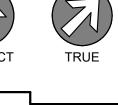
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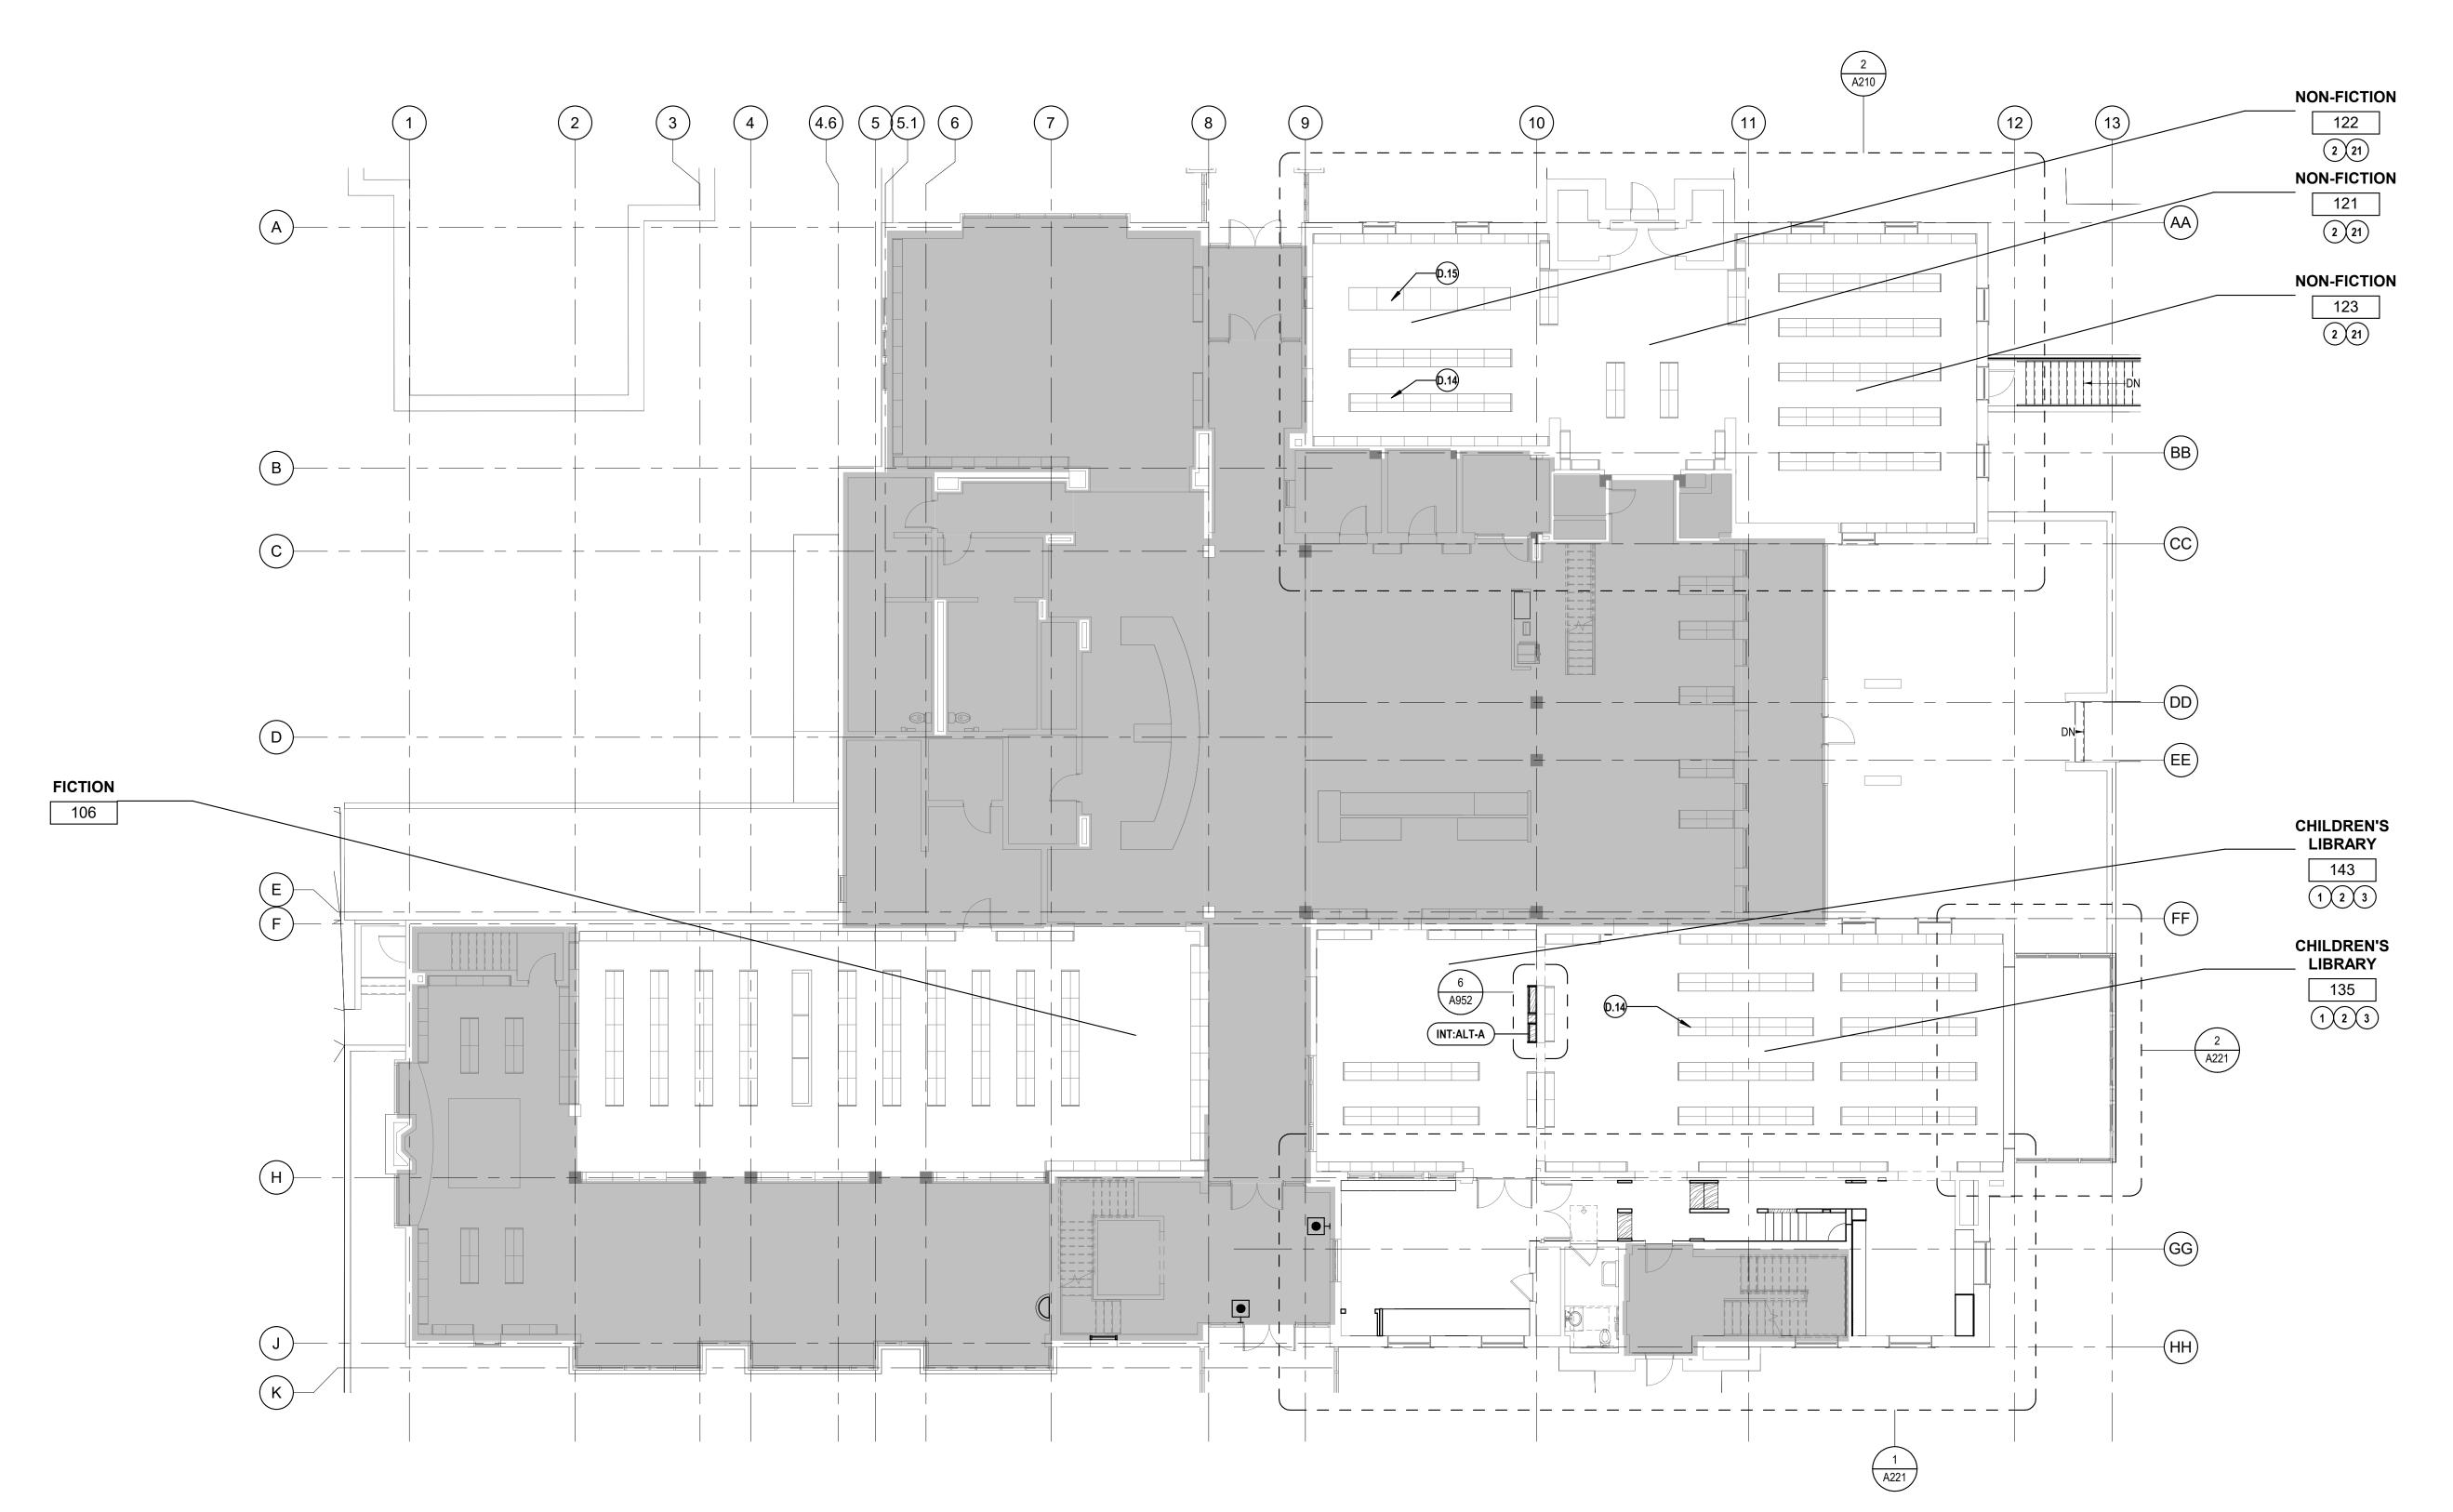
LEVEL 1 - OVERALL FLOOR PLAN


SHEET NO.

A201


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LEVEL 1 - DEMOLITION PLAN - CHILDREN'S LIBRARY SCALE: 1/8" = 1'-0"



2 LEVEL 1 - DEMOLITION PLAN - NON-FICTION

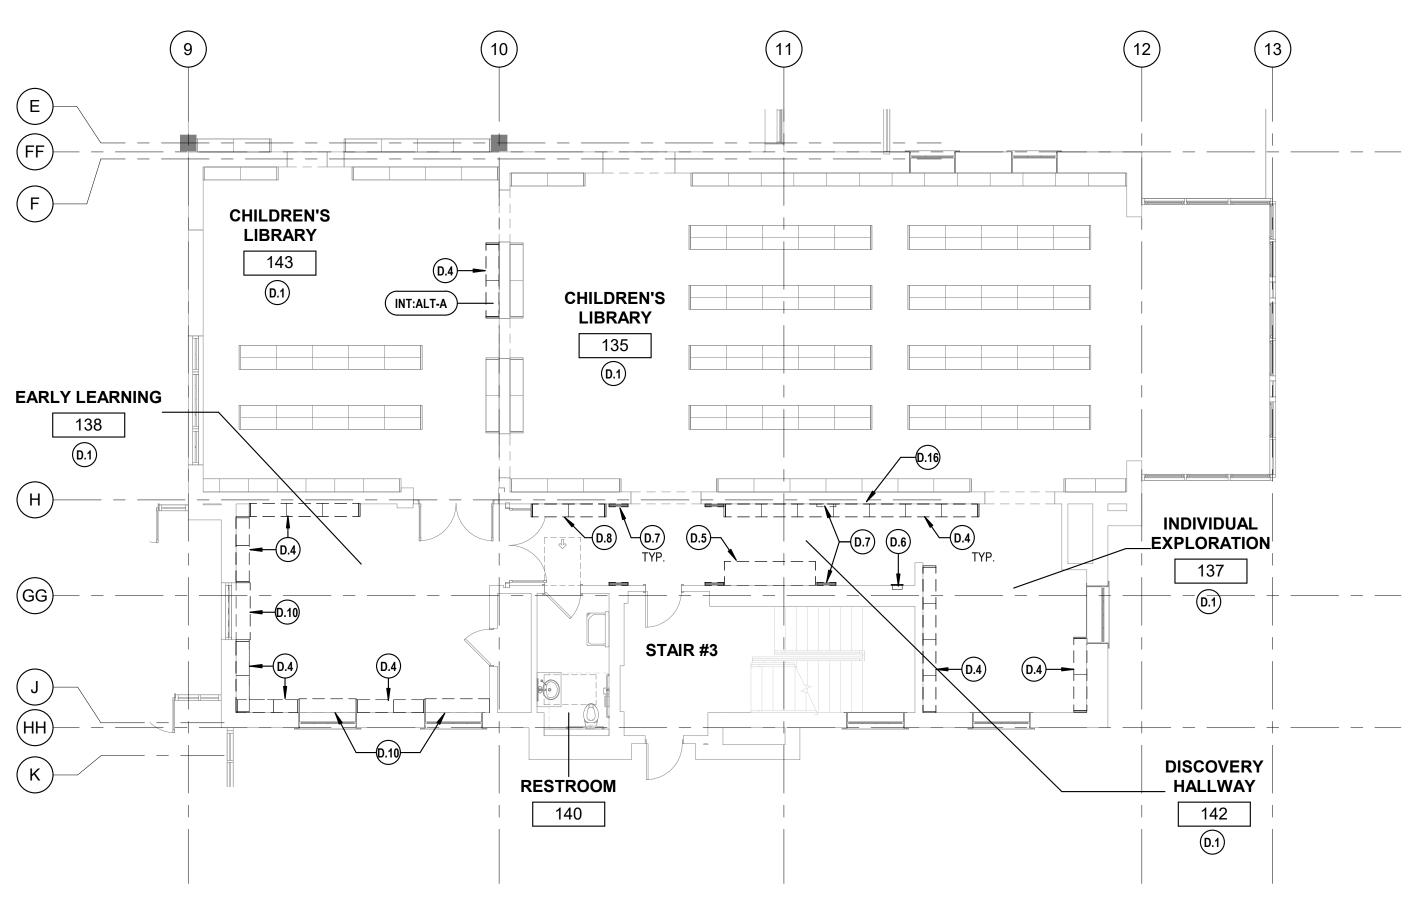SCALE: 1/8" = 1'-0"

DEMOLITION GENERAL NOTES

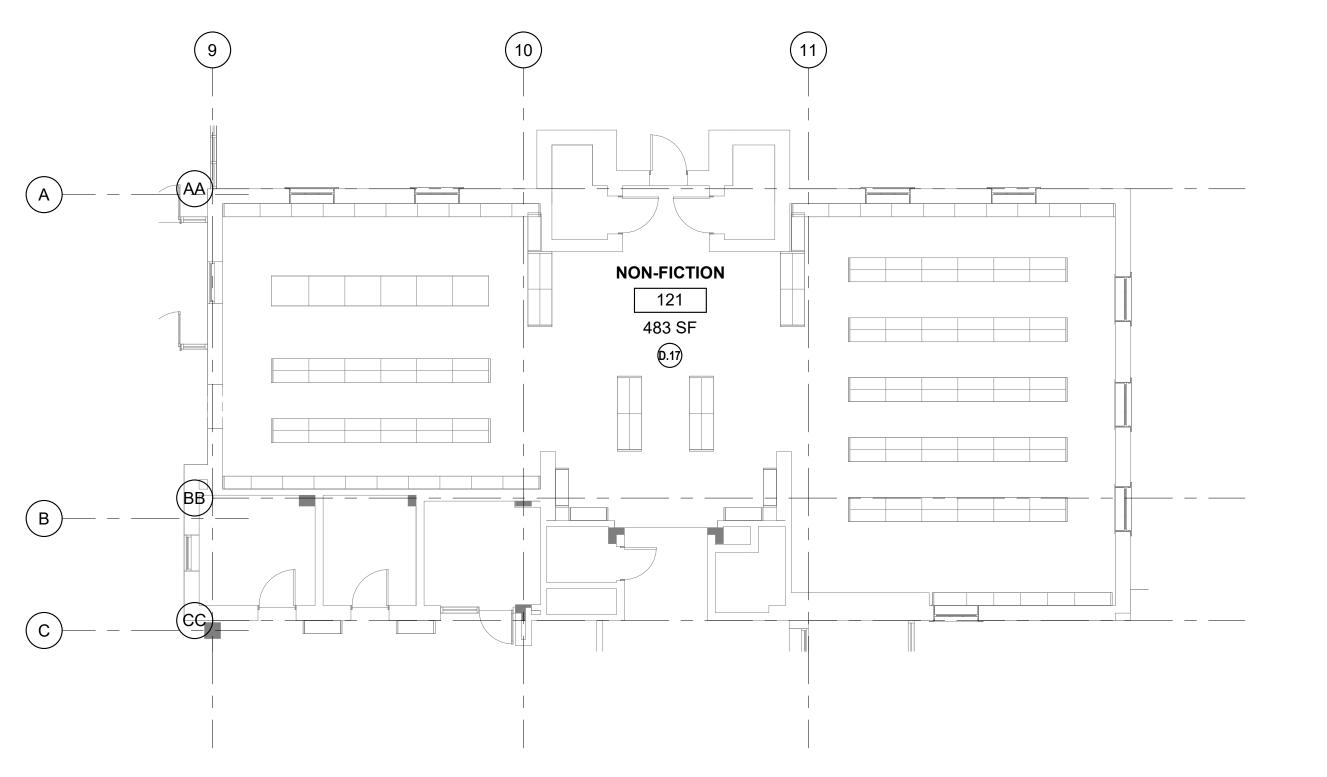
- 1. SEE G001 FOR NOTES APPLICABLE TO ALL PORTIONS OF THE WORK.
- 2. THE CONTRACTOR SHALL COORDINATE ALL DEMOLITION AND PHASING EFFORTS WITH THE ARCHITECT AND OWNER'S REPRESENTATIVE. EVERY EFFORT SHALL BE MADE TO MINIMIZE DISRUPTION OF OWNER'S OPERATIONS. EXCESSIVE NOISE OR VIBRATION SHALL BE PRE-APPROVED AND COORDINATED WITH THE OWNER'S REPRESENTATIVE. IN ALL CASES, PROVISIONS SHALL BE MADE FOR USER'S SAFETY.
- 3. MAINTAIN MEANS OF EGRESS THROUGHOUT THE WORK.
- 4. MAINTAIN A SECURE SPACE AT ALL TIMES.
- 5. VERIFY ALL EXISTING CONDITIONS, DIMENSIONS AND ELEVATIONS IN-FIELD AND NOTIFY THE ARCHITECT OF ANY DISCREPANCIES.
- 6. REMOVE IN THEIR ENTIRETY ALL EXISTING WALLS, DOORS, MILLWORK, PLUMBING FIXTURES, CEILINGS, SOFFITS, MARKERBOARDS, AND OTHER ITEMS, AS REQUIRED TO EXECUTE THE DEMOLITION AND CONSTRUCTION WORK DESCRIBED BY THE
- 7. OWNER HAS FIRST SALVAGE RIGHTS TO ALL ITEMS NOT BEING UTILIIZED IN THIS SCOPE OF WORK. VERIFY SALVAGE DESIRES PRIOR TO DISPOSAL.
- 8. EXISTING MATERIALS SHALL NOT BE REUSED UNLESS NOTED OTHERWISE OR AS AUTHORIZED BY ARCHITECT.
- 9. SEE MECHANICAL AND ELECTRICAL DRAWINGS AND NOTES FOR FURTHER SEQUENCING AND SCOPE OF WORK.
- 10. REMOVE ALL FURNITURE AND EQUIPMENT FROM AREA OF WORK; SALVAGE AS REQUIRED FOR NEW LAYOUT, SHEET XXXX. DISPOSE OF ITEMS NOT NEEDED FOR NEW SPACE.

KEYNOTES

- DEMOLISH EXISTING CARPET AND WOOD BASE. SALVAGE WOOD BASE FOR RELOCATION PER PLANS.
- INTERIOR ADD ALTERNATE-A: DEMOLISH EXISTING WALL-MOUNTED SHELF STANDARDS, SHELVES, AND ASSOCIATED TOP AND END CAPS; SALVAGE AS DIRECTED BY
- DEMOLISH EXISTING CASEWORK COUNTERTOP, CABINETS, AND
- ASSOCIATED WASTE BINS. DEMOLISH EXISTING FIRE EXTINGUISHER CABINET; SALVAGE
- AND REINSTALL EXTINGUISHER
- DEMOLISH EXISTING GWB ARCHWAY FEATURES AND WALL
- DEMOLISH EXISTING HVAC PLINTHS AND ASSOCIATED ELECTRICAL CONNECTIONS, RELOCATE PER MECHANICAL & ELECTRICAL.
- DEMOLISH UPHOLSTERED WINDOW SEAT AND ASSOCIATED CASEWORK. WHERE USED FOR HVAC DISTRIBUTION, RELOCATE PER MECHANICAL. RELOCATE ASSOCIATED POWER/DATA
- CONNECTIONS PER A211 AND ELECTRICAL. PARTIALLY DEMOLISH EXISTING WALL BACK TO STRUCTURE FOR ACTIVE PLAY INSTALLATION; SEE INTERIOR ELEVATION FOR
- ABATE LEAD PAINT AT WOOD BASE. DEMOLISH EXISTING

- CHILDREN'S LIBRARY 143

CARPET AND WOOD BASE. INT:ALT-A FABRICATION AND INSTALLATION OF KID LIBRARIAN CASEWORK

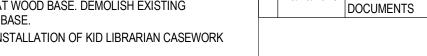





SHEET TITLE LEVEL 1 -**DEMOLITION**

FLOOR PLANS

Johnston Architects, LLC

REGISTERED

ARCHITECT

Mona Zellers

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12494

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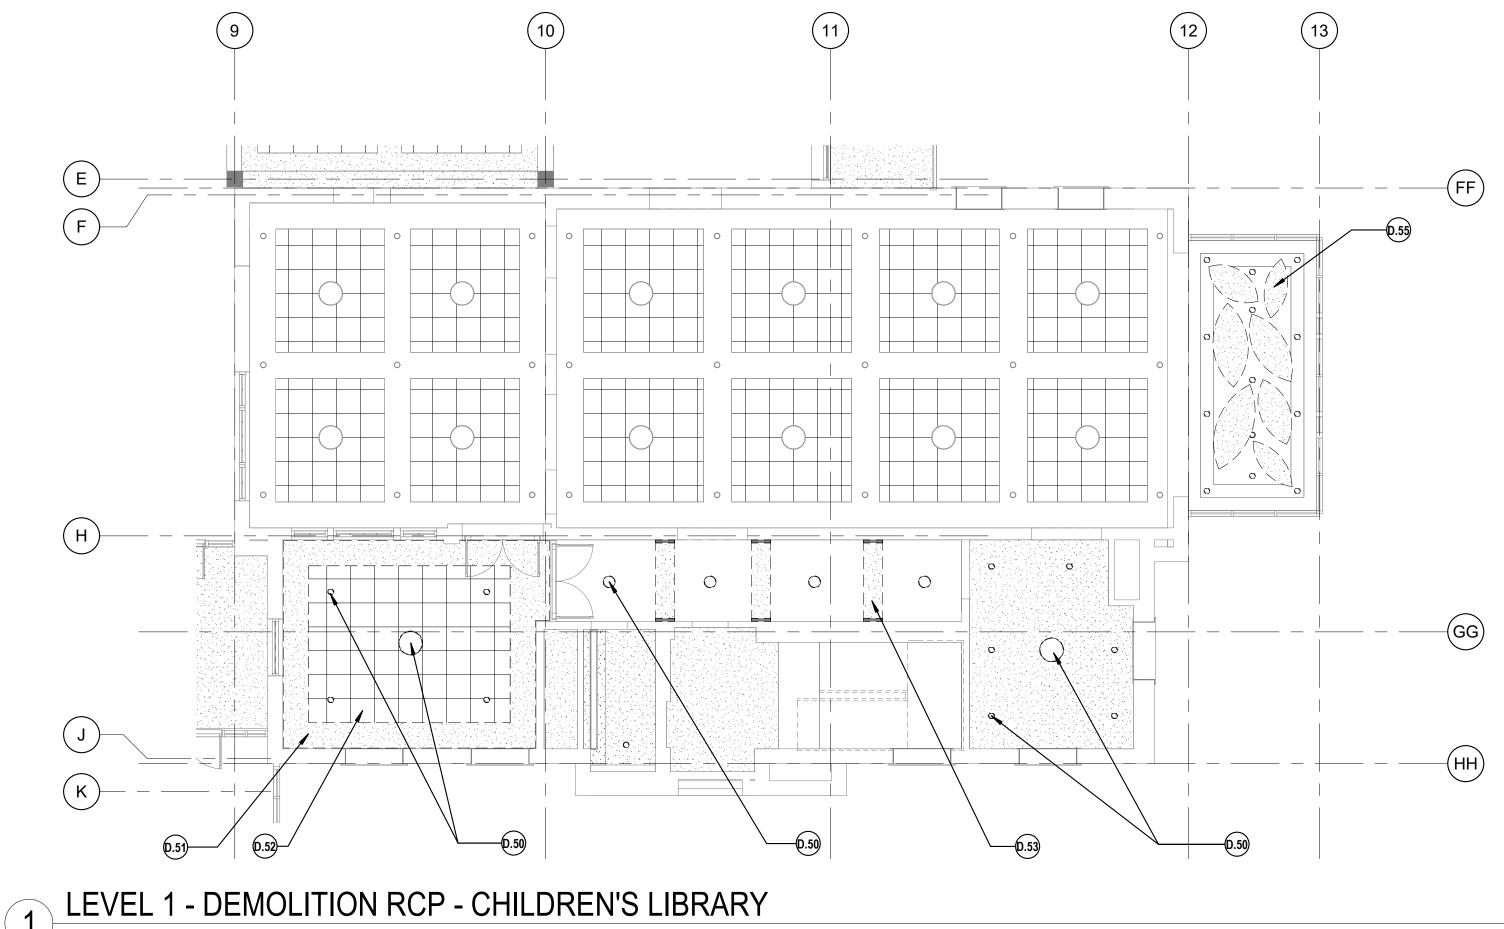
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Suite 510

SHEET NO.

A210



SCALE: 1/8" = 1'-0"

DEMOLITION GENERAL NOTES

- 1. SEE G001 FOR NOTES APPLICABLE TO ALL PORTIONS OF THE WORK.
- 2. THE CONTRACTOR SHALL COORDINATE ALL DEMOLITION AND PHASING EFFORTS WITH THE ARCHITECT AND OWNER'S REPRESENTATIVE. EVERY EFFORT SHALL BE MADE TO MINIMIZE DISRUPTION OF OWNER'S OPERATIONS. EXCESSIVE NOISE OR VIBRATION SHALL BE PRE-APPROVED AND COORDINATED WITH THE OWNER'S REPRESENTATIVE. IN ALL CASES, PROVISIONS SHALL BE MADE FOR USER'S SAFETY.
- 3. MAINTAIN MEANS OF EGRESS THROUGHOUT THE WORK.
- 4. MAINTAIN A SECURE SPACE AT ALL TIMES.
- 5. VERIFY ALL EXISTING CONDITIONS, DIMENSIONS AND ELEVATIONS IN-FIELD AND NOTIFY THE ARCHITECT OF ANY DISCREPANCIES.
- 6. REMOVE IN THEIR ENTIRETY ALL EXISTING WALLS, DOORS, MILLWORK, PLUMBING FIXTURES, CEILINGS, SOFFITS, MARKERBOARDS, AND OTHER ITEMS, AS REQUIRED TO EXECUTE THE DEMOLITION AND CONSTRUCTION WORK DESCRIBED BY THE DRAWINGS.
- OWNER HAS FIRST SALVAGE RIGHTS TO ALL ITEMS NOT BEING UTILIIZED IN THIS SCOPE OF WORK. VERIFY SALVAGE DESIRES PRIOR TO DISPOSAL.
- 8. EXISTING MATERIALS SHALL NOT BE REUSED UNLESS NOTED OTHERWISE OR AS AUTHORIZED BY ARCHITECT.
- 9. SEE MECHANICAL AND ELECTRICAL DRAWINGS AND NOTES FOR FURTHER SEQUENCING AND SCOPE OF WORK.
- 10. REMOVE ALL FURNITURE AND EQUIPMENT FROM AREA OF WORK; SALVAGE AS REQUIRED FOR NEW LAYOUT, SHEET XXXX. DISPOSE OF ITEMS NOT NEEDED FOR NEW SPACE.

DEMOLITION KEYNOTES

- D.50 DEMOLISH EXISTING LIGHT FIXTURES; SALVAGE J-BOX FOR NEW LIGHT FIXTURE. SEE RCP, COORDINATE WITH ELECTRICAL.
 - D.51 DEMOLISH EXISTING GWB SOFFITS AND ALL ASSOCIATED CEILING-MOUNTED MECHANICAL DIFFUSERS AND RETURN AIR GRILLES.
- D.52 DEMOLISH EXISTING ACOUSTIC CEILING TILE AND GRIDS.
- D.53 DEMOLISH EXISTING HALLWAY ARCHWAYSD.55 DEMOLISH EXISTING CEILING CLOUD, PENDANT LIGHTING, AND

FIBER OPTIC LIGHTING

JA

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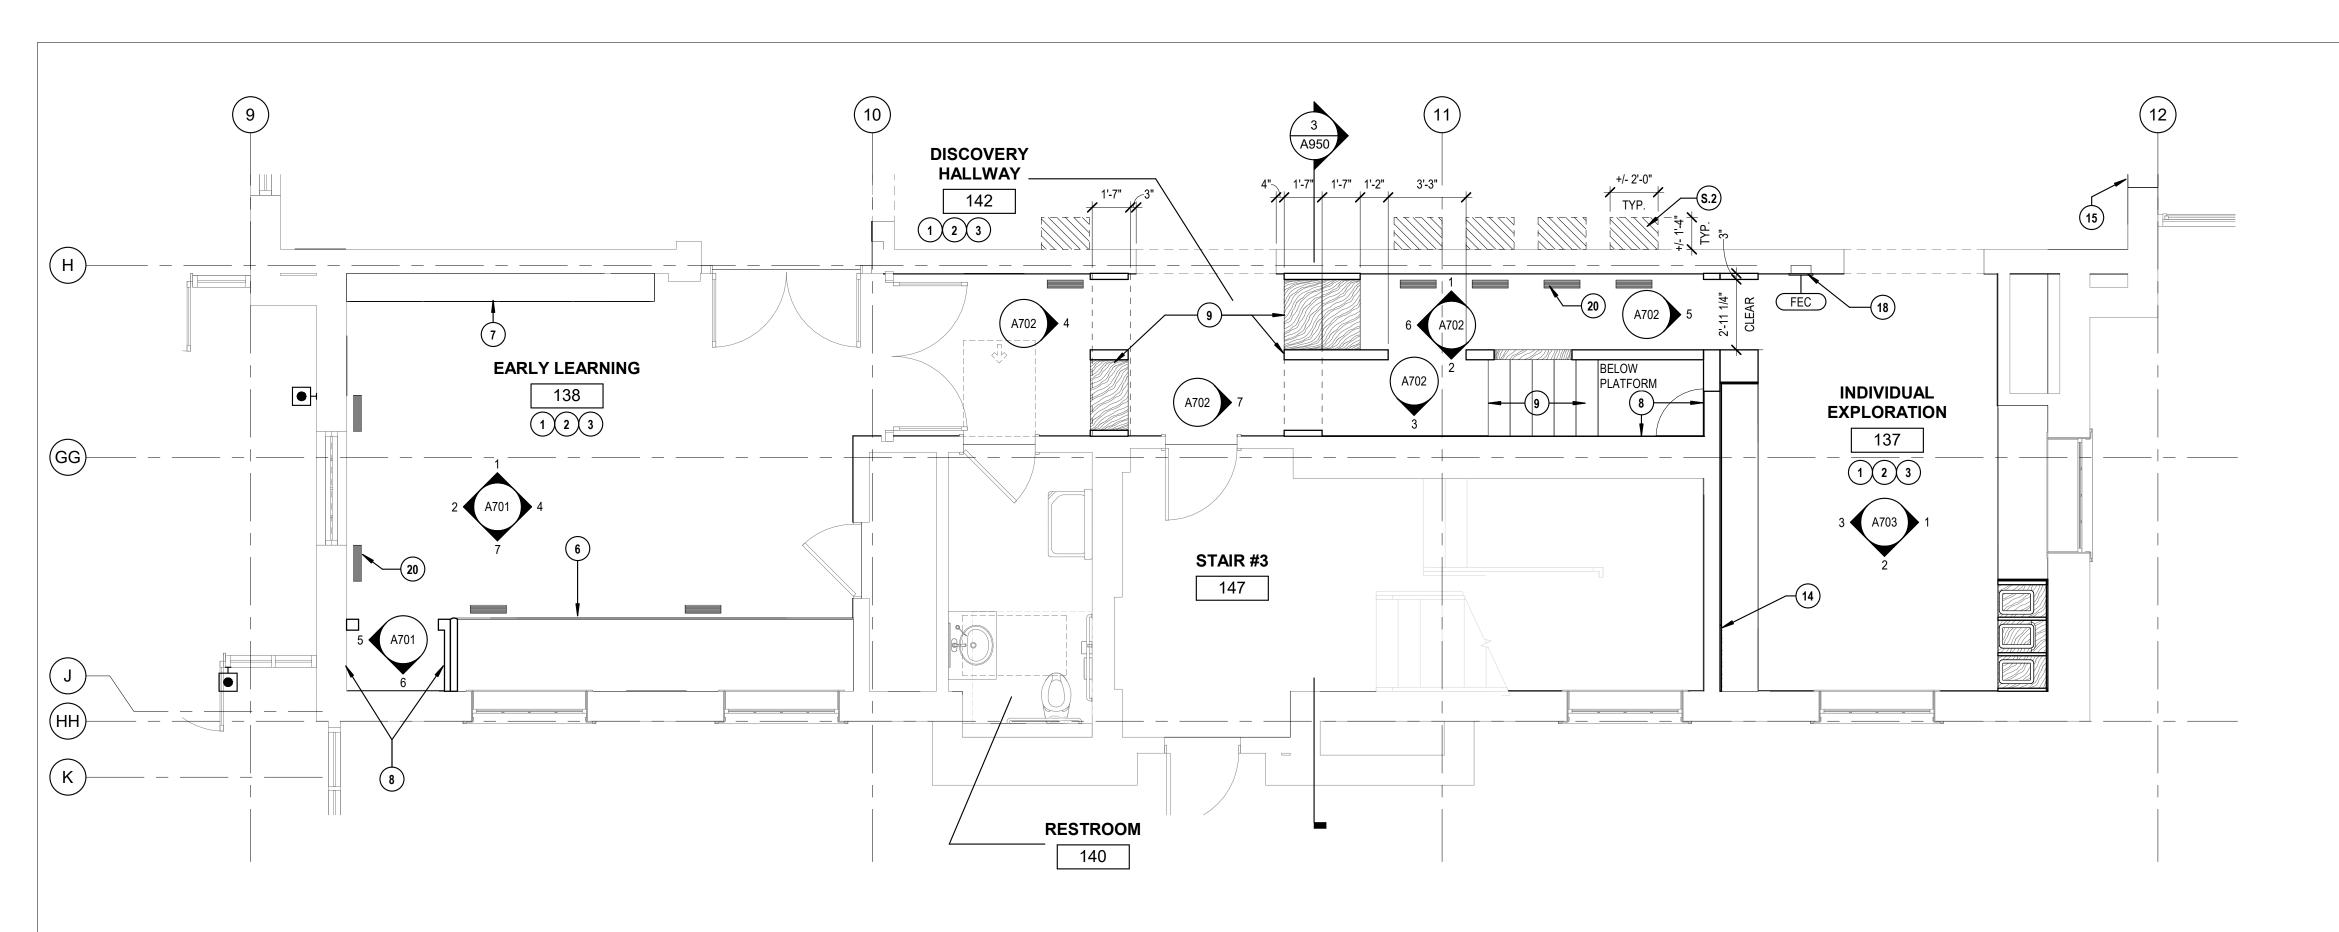


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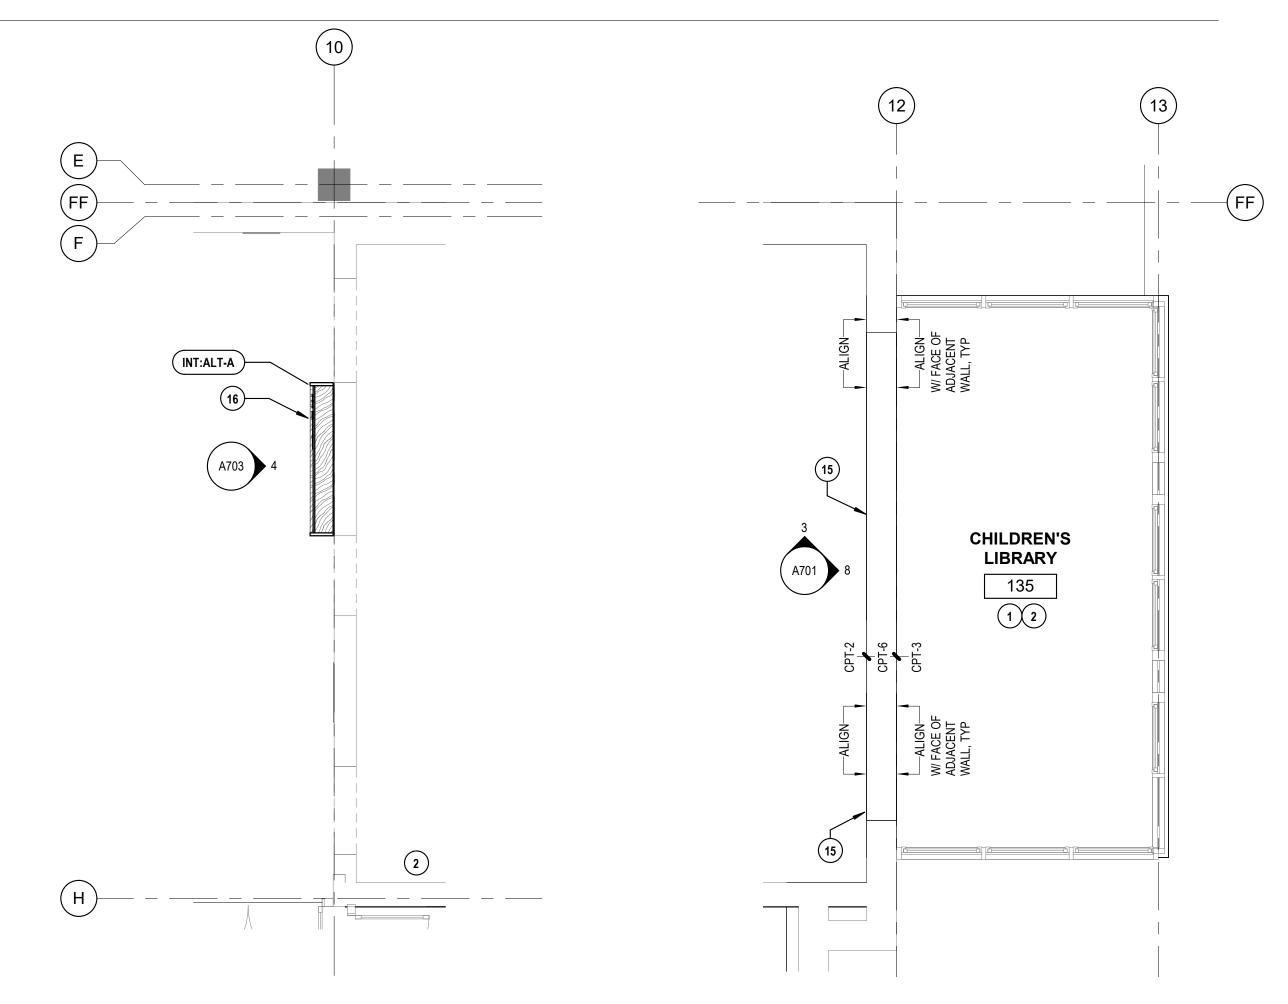
SHEET NO.

A211



LEVEL 1 - FLOOR PLAN - LEARNING HIVE

SCALE: 1/4" = 1'-0"



3 LEVEL 1 - FLOOR PLAN - KID LIBRARIAN

SCALE: 1/4" = 1'-0"

2 LEVEL 1 - FLOOR PLAN - COZY READING

SCALE: 1/4" = 1'-0"

PLAN GENERAL NOTES

- 1. REFER TO SHEET G001 FOR NOTES APPLICABLE TO ALL PORTIONS OF THE WORK.
- 2. REFER TO G300 SERIES FOR TYPICAL ACCESSIBILITY CLEARANCES AND REQUIREMENTS.
- 3. REFER TO A001 FOR WALL ASSEMBLIES. PATCH AND REPAIR ALL EXISTING WALLS AND NEW WALL INTERSECTIONS TO UNIFORM, LIKE-NEW APPEARANCE; PREPARE TO RECEIVE NEW PAINT AS
- 4. MAINTAIN ACOUSTIC AND/OR FIRE RATINGS AROUND RECESSED FIXTURES, PIPING, DUCTWORK, PENETRATIONS AND ALL
- 5. FLOOR TRANSITIONS TO OCCUR CENTERED UNDER DOOR PANEL. WHERE NO DOOR OCCURS, ALIGN FINISH TRANSITION WITH FINISHED FACE OF WALL BASE. FINISH TRANSITIONS MARKED WITH 'ALIGN' SHALL ALIGN WITH FACE OF ADJACENT WALL BASE, WHERE OCCURS, UNLESS NOTED OTHERWISE.
- 6. GWB LEVEL OF FINISH SCHEDULE FOR WALLS AND CEILINGS IN THE FOLLOWING LOCATIONS: A. LEVEL 4 (SMOOTH WALL): ALL AREAS NOT OTHERWISE
- B. LEVEL 5 (SMOOTH WALL): BEHIND ANY WALLCOVERING LOCATIONS; REFER TO ROOM FINISH SCHEDULE.
- 7. NEW POWER, DATA, AND PLUMBING CONNECTIONS TO BE COORDINATED WITH MEP.

KEYNOTES


- 1 PATCH AND REPAIR ALL WALLS TO LIKE-NEW, UNIFORM, FINISH-READY APPEARANCE. ALL WALLS TO RECEIVE NEW PAINT AS SCHEDULED.
- PROVIDE AND INSTALL NEW CARPET TILE AS SCHEDULED.
- PROVIDE AND INSTALL NEW RUBBER BASE AS SCHEDULED.
- NEW BUILT-IN CASEWORK FEATURE WITH UPHOLSTERED SEAT. SEE ELEVATIONS AND ROOM FINISH SCHEDULE FOR ADDITIONAL INFORMATION.
- PROVIDE AND INSTALL NEW CASEWORK STORAGE SHELVES AND CABINETS WITH SOLID SURFACE COUNTERTOP. SEE ELEVATIONS.
- PROVIDE AND INSTALL NEW WALLCOVERING; SEE ELEVATIONS FOR EXTENTS OF FINISH.
- PROVIDE AND INSTALL NEW CASEWORK PLAY STRUCTURE AND CARPETED RISER STAIRS. REFER TO ELEVATIONS, DETAILS, AND ROOM FINISH SCHEDULE. PASS-THROUGH CUT-OUT TO HAVE UPHOLSTERED EDGE OPENING.
- PROVIDE AND INSTALL NEW CUSTOM OVERSIZED PAINTED PEGBOARD AND FABRIC-WRAPPED ACOUSTIC WALL PANELS. SEE ELEVATIONS.
- PROVIDE AND INSTALL NEW CASEWORK PLINTHS AND UPHOLSTERED SURROUNDS. UPHOLSTERY TO WRAP ONTO NEW GWB SOFFIT (SEE RCP AND ELEVATIONS) AND TERMINATE AT FLOOR. JOINS BETWEEN CASEWORK AND ADJACENT GWB WALL TO BE FILLED WITH BONDO AND PAINTED TO MATCH; DESIGN INTENT IS FOR UNIFORM, SMOOTH FINISH ACROSS
- PROVIDE AND INSTALL NEW CASEWORK FEATURE WALL WITH LOCKING GLASS DOORS, ADJUSTABLE SHELVES, AND DISPLAY NOOKS. SEE ELEVATIONS.
- PROVIDE AND INSTALL NEW SEMI-RECESSED F.E.C., BOD: JL
- AMBASSADOR MODEL 1012 INSTALL NEW FLOOR GRILLS FOR SUPPLY; COORDINATE WITH
- INT:AL FABRICATION AND INSTALLATION OF KID LIBRARIAN T-A CASEWORK FEATURE

STRUCTURAL KEYNOTES

S.2 AT DUCT PENETRATION THROUGH (E) SLAB, SAWCUT AND REPLACE (E) SLAB WITH (N) CONC. SLAB ON GRADE TO MATCH THICKNESS OF EXISTING CONCRETE SLAB. REF DETAILS S-1; COORDINATE WITH HVAC SUB

ADD ALTERNATES

INT:ALT-A FABRICATION AND INSTALLATION OF KID LIBRARIAN CASEWORK FEATURE
- CHILDREN'S LIBRARY 143

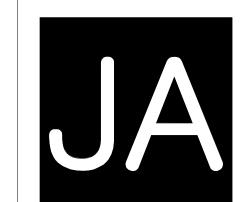

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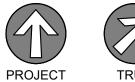
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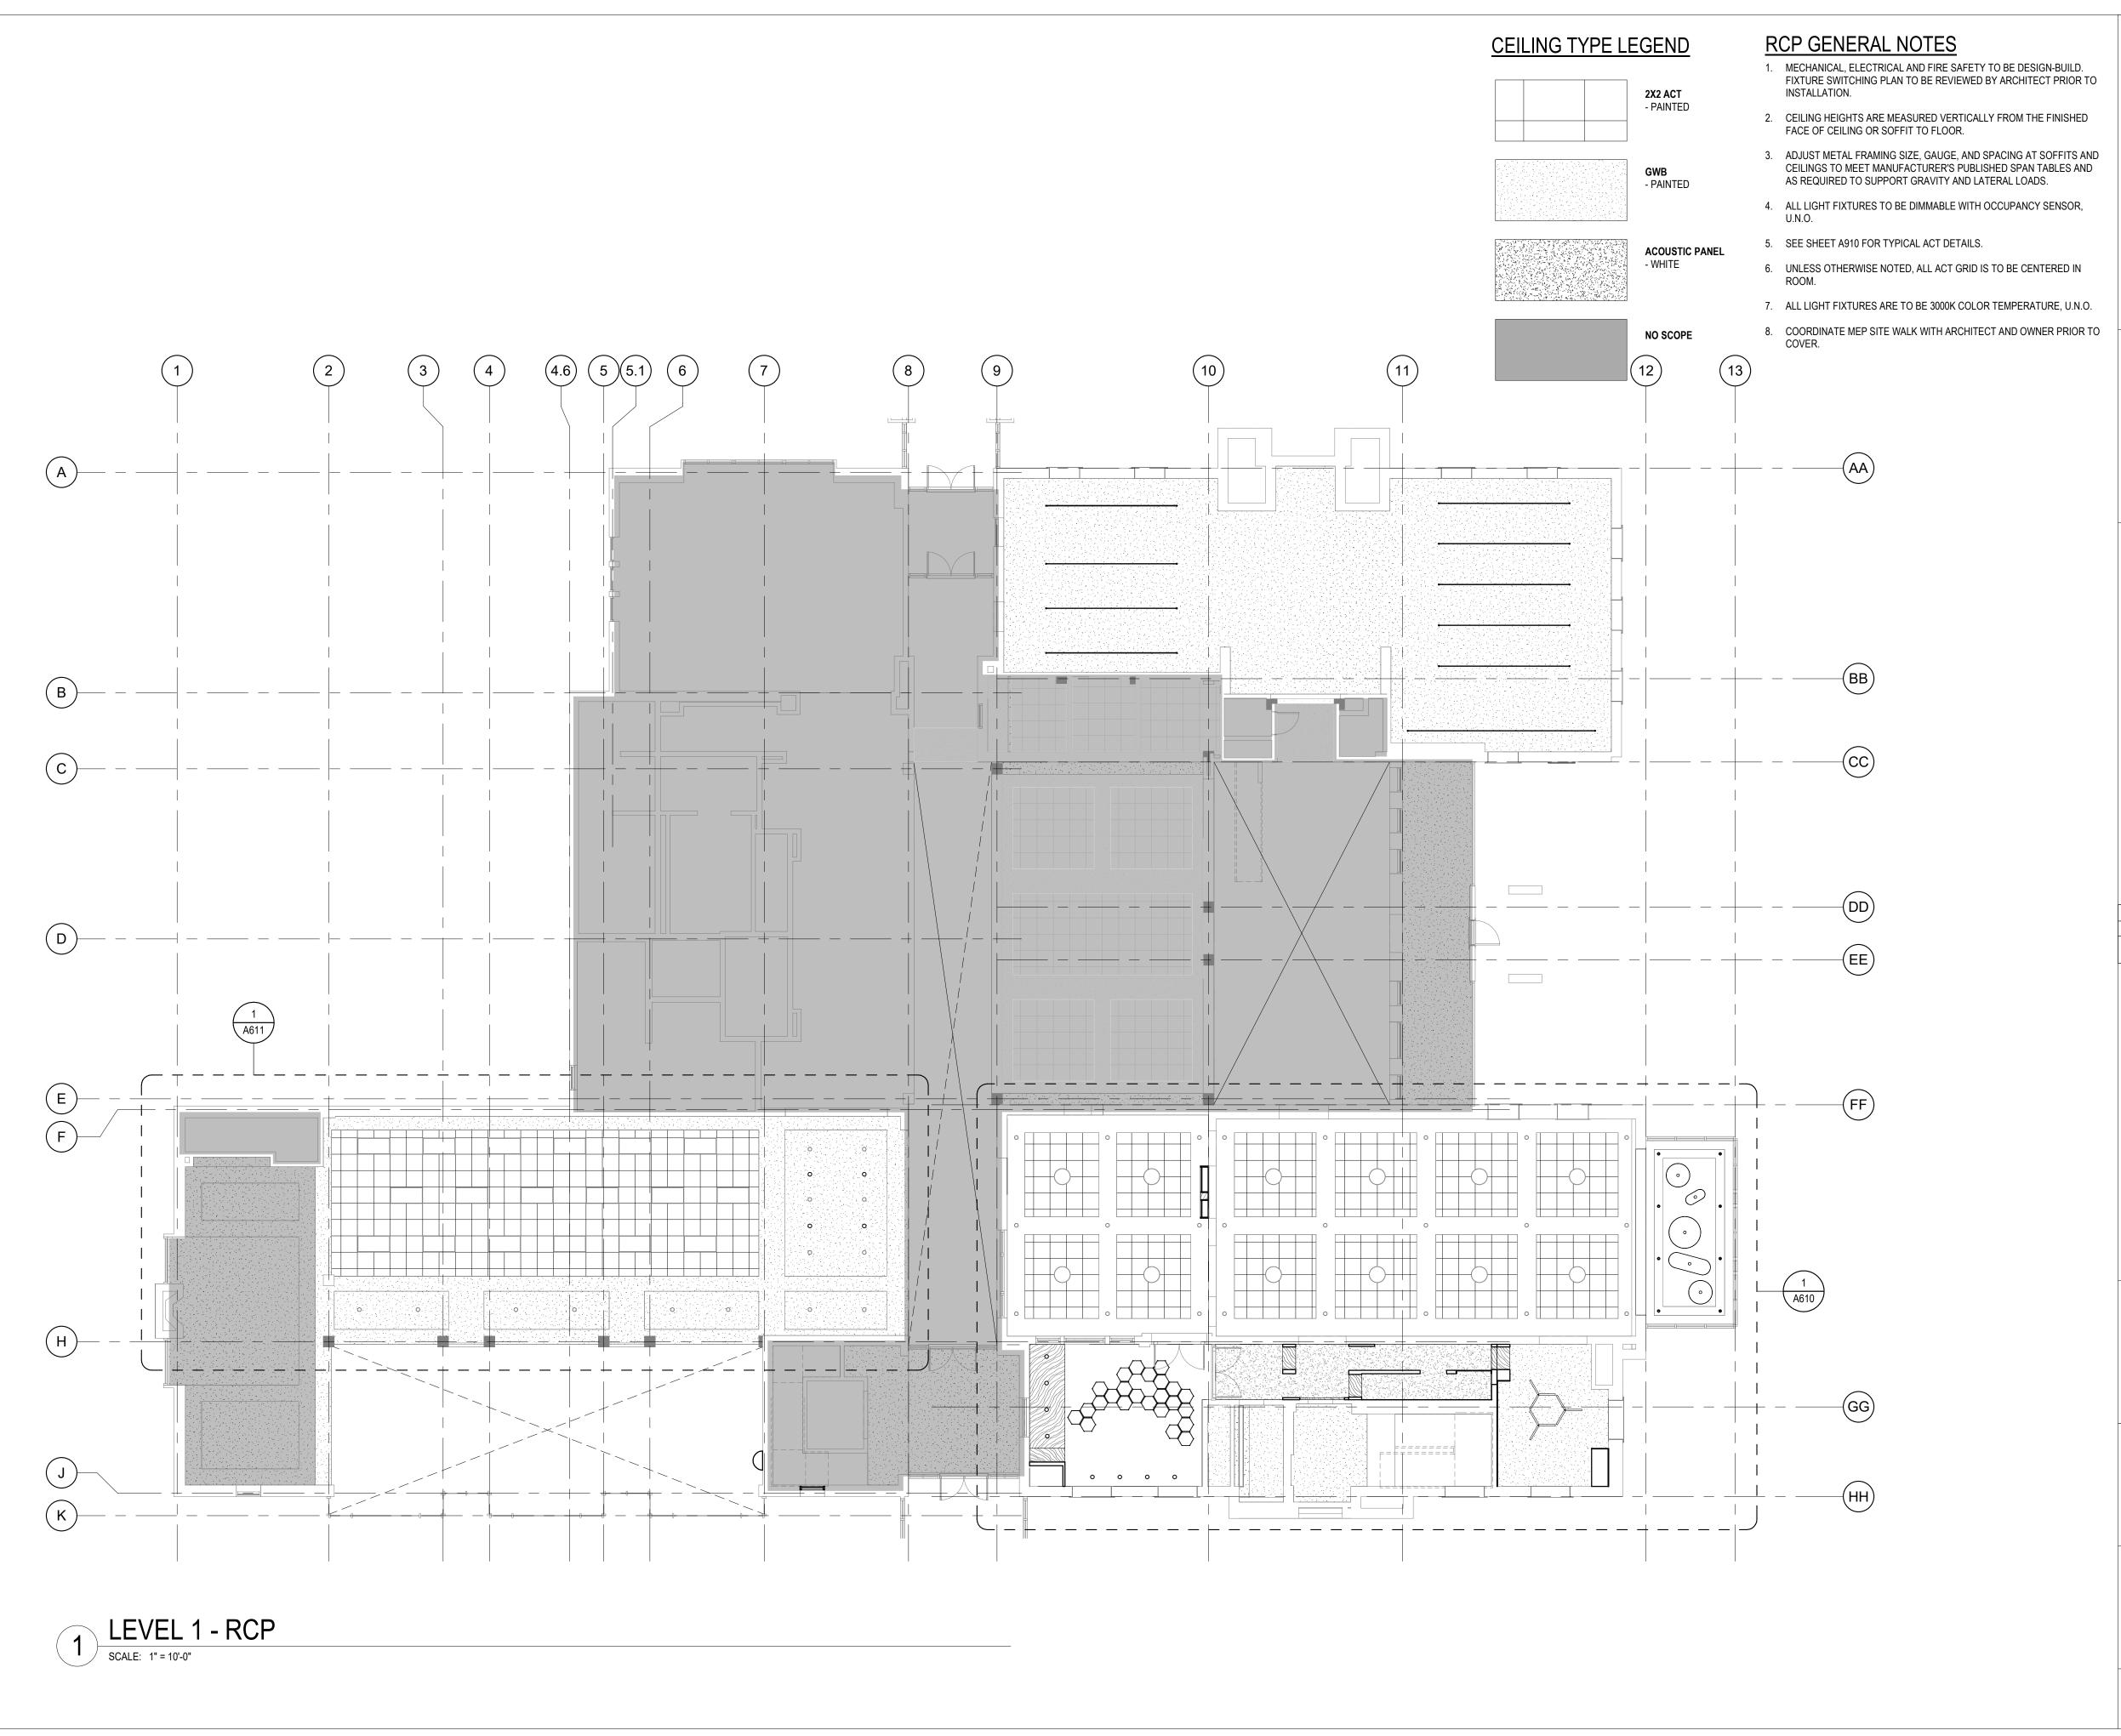


SHEET TITLE

LEVEL 1 -**ENLARGED PLANS**

SHEET NO.

A221



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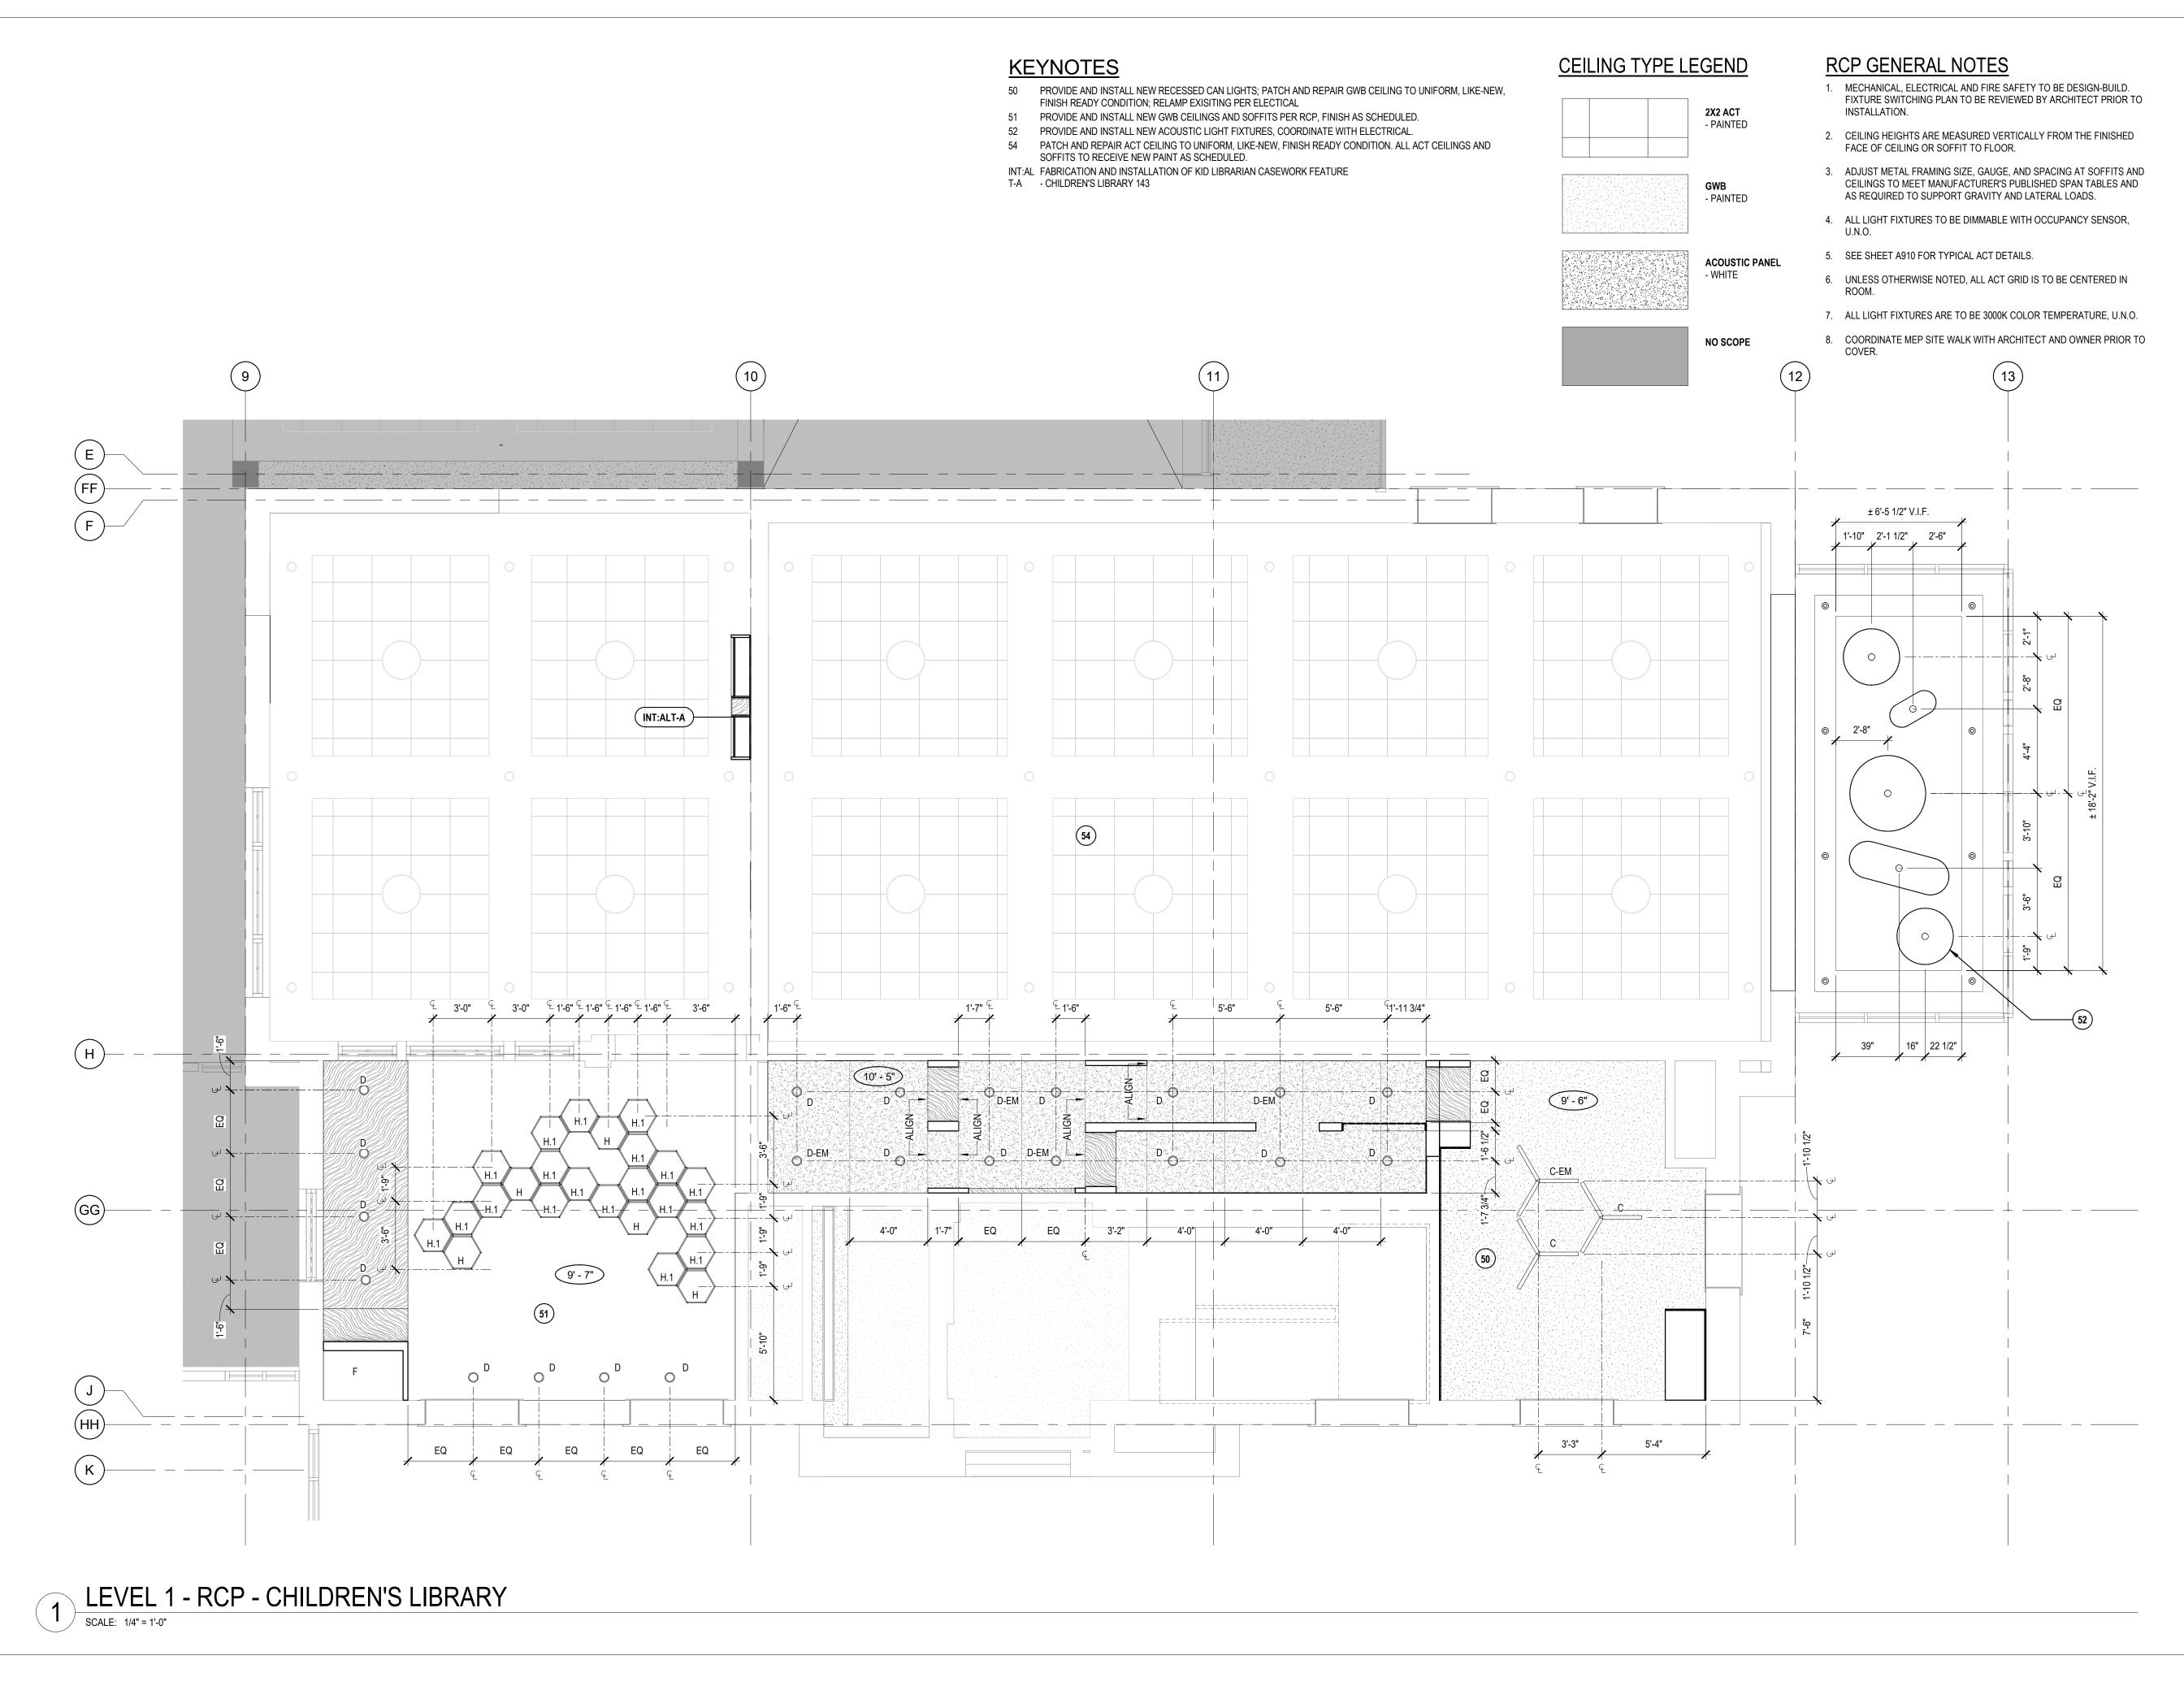
CEILING PLAN

SHEET NO.

A600

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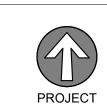


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A610


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CEILING TYPE LEGEND

2X2 ACT - PAINTED






NO SCOPE

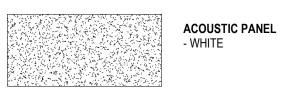RCP GENERAL NOTES

- 1. MECHANICAL, ELECTRICAL AND FIRE SAFETY TO BE DESIGN-BUILD. FIXTURE SWITCHING PLAN TO BE REVIEWED BY ARCHITECT PRIOR TO INSTALLATION.
- 2. CEILING HEIGHTS ARE MEASURED VERTICALLY FROM THE FINISHED FACE OF CEILING OR SOFFIT TO FLOOR.
- 3. ADJUST METAL FRAMING SIZE, GAUGE, AND SPACING AT SOFFITS AND CEILINGS TO MEET MANUFACTURER'S PUBLISHED SPAN TABLES AND AS REQUIRED TO SUPPORT GRAVITY AND LATERAL LOADS.
- 4. ALL LIGHT FIXTURES TO BE DIMMABLE WITH OCCUPANCY SENSOR,
- 5. SEE SHEET A910 FOR TYPICAL ACT DETAILS.
- 6. UNLESS OTHERWISE NOTED, ALL ACT GRID IS TO BE CENTERED IN
- 7. ALL LIGHT FIXTURES ARE TO BE 3000K COLOR TEMPERATURE, U.N.O.
- 8. COORDINATE MEP SITE WALK WITH ARCHITECT AND OWNER PRIOR TO

KEYNOTES

50 PROVIDE AND INSTALL NEW RECESSED CAN LIGHTS; PATCH AND REPAIR GWB CEILING TO UNIFORM, LIKE-NEW, FINISH READY CONDITION; RELAMP EXISITING PER ELECTICAL

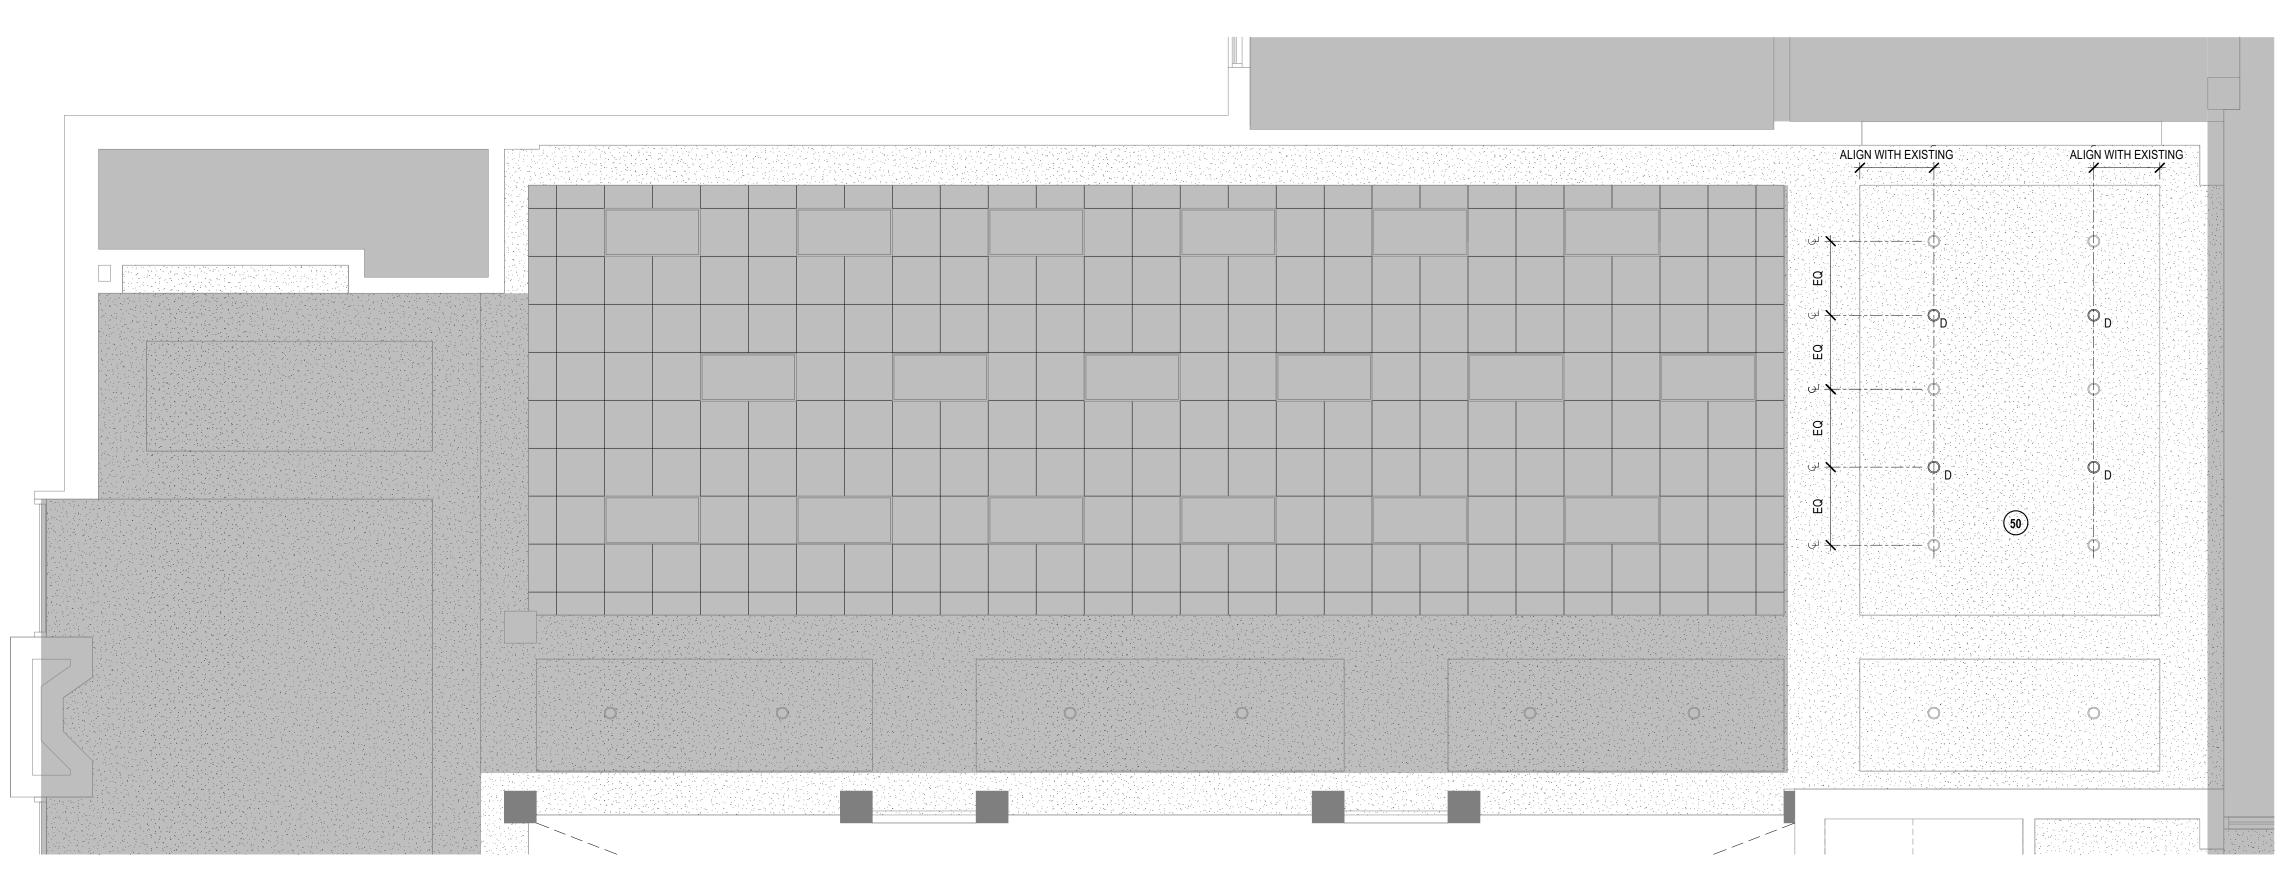

1 LEVEL 1 - RCP - FICTION

SCALE: 1/4" = 1'-0"

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SHEET TITLE

LEVEL 1 -ENLARGED RCPS

SHEET NO.

MATERIALS & FINISHES LEGEND

SPEC. SECTIONS NOTED BELOW FOR REFERENCE

SECTION 06 41 00 - ARCHITECTURAL WOOD CASEWORK WOOD CONTROL SAMPLES WD-1 DESCRIPTION: VENEERED PLYWOOD

VENEER SPECIES: BALTIC BIRCH CUT: FLAT SAWN FINISH: BONA NATURAL SEAL, MATCH ARCHITECT CONTROL SAMPLE

WB-1 DESCRIPTION: WOOD WALL BASE STYLE: MATCH EXISTING FINISH: PAINT, MATCH EXISTING

MANUFACTURER: ULTRAFABRICS PATTERN: BRISA DISTRESSED COLOR: 535-3869 MUSLIN CONTENT: 100% POLYURETHANE WIDTH: 54" REPEAT: 8"V X 10.5"H RAILROADED: NO FIRE RESISTANCE: CA TB 117-2013 CONTACT: LARA BERGSTROM | LARA@BENNETTASSOCS.COM

MANUFACTURER: DESIGNTEX F-2 PATTERN: MONTREAL CRYPTON COLOR: 3102-105 CONTENT: 100% POLYESTER WIDTH: 54" REPEAT: NONE RAILROADED: NO FIRE RESISTANCE: CA TB 117-2013 CONTACT: LINDSAY WILLINGHAM | LWILLINGHAM@DESIGNTEX.COM

MANUFACTURER: DESIGNTEX PATTERN: SALT LAKE CRYPTON COLOR: 3110-201 STRAW CONTENT: 100% POLYESTER WIDTH: 54" REPEAT: NONE RAILROADED: NO FIRE RESISTANCE: CA TB 117-2013 CONTACT: LINDSAY WILLINGHAM | LWILLINGHAM@DESIGNTEX.COM

MANUFACTURER: DESIGNTEX PATTERN: MONTREAL CRYPTON COLOR: 3102-201 MARIGOLD CONTENT: 100% POLYESTER WIDTH: 54" REPEAT: NONE RAILROADED: NO FIRE RESISTANCE: CA TB 117-2013 CONTACT: LINDSAY WILLINGHAM | LWILLINGHAM@DESIGNTEX.COM

MANUFACTURER: DESIGNTEX PATTERN: NAGANO CRYPTON COLOR: 3114-201 CANARY CONTENT: 100% POLYESTER WIDTH: 54" REPEAT: NONE RAILROADED: NO FIRE RESISTANCE: CA TB 117-2013 CONTACT: LINDSAY WILLINGHAM | LWILLINGHAM@DESIGNTEX.COM

MANUFACTURER: WOLF-GORDON PATTERN: BARRINGTON GOH 33089341 COLOR: CANARY CONTENT: 100% POLYESTER WIDTH: 54" REPEAT: NONE RAILROADED: NO FIRE RESISTANCE: CAL TB 117-2013 CONTACT: CASSIE KLIEN I CASSIE.KLIEN@WOLFGORDON.COM

SECTION 09 51 00 - ACOUSTICAL CEILINGS

FELT PANELING **PET-1** MANUFACTURER: FSORB PRODUCT: 1" CEILING PANEL COLOR: WHITE #100 SIZE: 4'-0" X 8'-0" STANDARD INSTALLATION: ACOUSTIC ADHESIVE PER MANUFACTUER INSTALLATION

SECTION 09 65 00 - RESILIENT FLOORING

RESILIENT BASE **RB-1** MANUFACTURER: ROPPE TYPE: CONTOURS PROFILED RUBBER BASE STYLE: 1/4" CANDID PROFILE: SQUARE SIZE: 4" COLOR: P161 SNOW

SECTION 09 68 13 – TILE CARPETING CPT-1 MANUFACTURER: SHAW CONTRACT STYLE: SPOKEN TILE 5T406 COLOR: SCRIPT 05210

SIZE: 9" X 36" DYE METHOD: 100% SOLUTION DYED PRIMARY BACKING: SYNTHETIC PILE HEIGHT: 0.315" INSTALLATION: BRICK CONTACT: BRODEN STAPLES | BRODEN.STAPLES@SHAWCONTRACT.COM

CPT-2 MANUFACTURER: SHAW CONTRACT STYLE: TRANSLATE TILE 5T408 COLOR: SCRIPT 05210 SIZE: 9" X 36" DYE METHOD: 100% SOLUTION DYED PRIMARY BACKING: SYNTHETIC PILE HEIGHT: 0.266" INSTALLATION: BRICK CONTACT: BRODEN STAPLES | BRODEN.STAPLES@SHAWCONTRACT.COM

CPT-3 MANUFACTURER: FLOR STYLE: STONE'S THROW COLOR: SEAFOAM SIZE: 50CM X 50CM DYE METHOD: 100% SOLUTION DYED PRIMARY BACKING: GLASBAC PILE HEIGHT: 0.16" INSTALLATION: MONOLITHIC NOTE: FEATHER AT TRANSITION FOR LEVEL SURFACE CONTACT: SHELLY STREIBICK | SHELLY.STREIBICK@INTERFACE.COM

CPT-4 MANUFACTURER: SHAW CONTRACT STYLE: FORM TILE 5T136 **COLOR: CONERSTONE COPPER 33555** SIZE: 24" X24" DYE METHOD: 100% SOLUTION DYED PRIMARY BACKING: SYNTHETIC INSTALLATION: ASHLAR CONTACT: BRODEN STAPLES | BRODEN.STAPLES@SHAWCONTRACT.COM

CPT-5 <u>NOT USED</u>

CPT-6 MANUFACTURER: SHAW CONTRACT STYLE: TRU COLORS EW24 - 59368 COLOR: NORDIC - 68447 SIZE: 24" X 24" DYE METHOD: 100% SOLUTION DYED PRIMARY BACKING: ECOWORX PILE HEIGHT: 0.093" INSTALLATION: MONOLITHIC CONTACT: BRODEN STAPLES | BRODEN.STAPLES@SHAWCONTRACT.COM SECTION 09 72 00 - WALL COVERINGS

WC-1 MANUFACTURER: SPOONFLOWER DESIGN NAME: CUTE FOREST ANIMALS WALLPAPER DESIGN NUMBER: #15422652 SUBSTRATE: NON-PASTED TRADITIONAL PEBBLE CONTENT: TYPE II PVC-FREE FIRE RATING: CLASS A CONTACT: MARCY SULLIVAN | MARCY.SULLIVAN@SPOONFLOWER.COM

WC-2 MANUFACTURER: SPOONFLOWER DESIGN NAME: SHIBORI STARS ON DARK INDIGO (LARGE SCALE) DESIGN NUMBER: #12300607 SUBSTRATE: NON-PASTED TRADITIONAL PEBBLE CONTENT: TYPE II PVC-FREE FIRE RATING: CLASS A CONTACT: MARCY SULLIVAN |

MARCY.SULLIVAN@SPOONFLOWER.COM

SECTION 09 77 00 - STRETCHED FABRIC **AWC-1** MANUFACTURER: SNAPTEX PROFILE: 3/4" SQUARE TOP LOAD

SUBSTRATE: MICORE TACKABLE FIBERBOARD CONTACT: KEN HUBER | KEN@SNAPTEX.COM TEXTILE: F-6, SEE SECTION 06 41 00

FINISH SCHEDULE COMMENTS:

1. NO FINISH UPDATES; SEE RCP FOR EXTENT OF SCOPE.

AT EXISTING PAINTED GWB WALLS ONLY.

HEIGHT TRANSITION.

ELEVATED.

10. NOT USED

11. NOT USED

4. ABATE LEAD PAINT AT WOOD BASE.

2. EXISTING WOOD WALL PANELING TO REMAIN AS-IS; PAINT SCOPE

3. P-1 CEILING PAINT TO TERMINATE AT INSIDE CORNER OF SOFFIT

5. P-1 CEILING PAINT AT EXISTING GWB SOFFITS ONLY. EXISTING

6. CPT-3 TRANSITION TO ALIGN WITH FACES OF ADJACENT WALLS AT

TRANSITION TO COZY READING AREA. CPT-6 TO BE IN COZY

READING AREA; SEE A221 FOR TRANSITION LOCATIONS.

8. P-2 FINISH AT OVERSIZED PEGBOARD ONLY. SEE ELEVATION FOR

9. F-2 UPHOLSTERY FABRIC AT BANQUETTE SEAT, EXTENTS AS

12. P-2 PAINTED BACKS AT FEATURE CASEWORK; SEE ELEVATIONS

ACOUSTIC CEILING TILE & GRID TO REMAIN AS-IS.

7. P-1B MARKERBOARD PAINT EXTENTS PER ELEVATIONS.

TERMINATE PAINT AT INSIDE CORNERS.

AND DETAILS FOR EXTENTS OF FINISHES.

SECTION 09 91 23 - INTERIOR PAINTING

P-1 MANUFACTURER: BENJAMIN MOORE COLOR: OC-65 CHANTILLY LACE SHEEN: EGGSHELL

P-1A MANUFACTURER: BENJAMIN MOORE COLOR: OC-65 CHANTILLY LACE SHEEN: SEMI-GLOSS

MANUFACTURER: SHERWIN WILLIAMS COLOR: SW 6902 DECISIVE YELLOW SHEEN: EGGSHELL

MANUFACTURER: SHERWIN WILLIAMS COLOR: SW 0048 BUNGLEHOUSE BLUE

SHEEN: EGGSHELL

ERASE PAINT

MAGNETIC DRY-ERASE PAINT

P-1B MANUFACTURER: IDEAPAINT OR EQUAL PRIMER: MAGNETIC PRIMER COLOR LAYER: P-1 TOPCOAT: IDEAPAINT CREATE CLEAR INTERIOR DRY

SECTION 12 36 00 – COUNTERTOPS

SOLID SURFACE **\$\$-1** MANUFACTURER: FORMICA PRODUCT: EVERFORM SOLID SURFACE PATTERN: 601 BLEACHED CONCRETE SIZE: 30" X 144" X 0.48" THICK

				R00	M FIN	IISH S	SCHE	DULE			
RM.#	NAME	FLOOR	BASE		WALL F	FINISH		CASEWORK	COUNTERTOP	CEILING	NOTES
KIVI.#	INAIVIE	FLOOR	DAGE	NORTH	EAST	SOUTH	WEST	CASEVVORK	COUNTERTOP	CEILING	NOTES

LEVEL	1										
106	FICTION	-	-	-	-	-	-	-	-	MATCH EXISTING	1
121	NON-FICTION	CPT-4	WB-1	-	-	-	-	-	-	-	4
122	NON-FICTION	CPT-4	WB-1	-	-	-	-	-	-	-	4
123	NON-FICTION	CPT-4	WB-1	-	-	-	-	-	-	-	4
135	CHILDREN'S LIBRARY	CPT-2/CPT-3/CPT-6	RB-1	P-1	P-1/P-3	P-1	P-1	P-3/F-7	-	P-1	6, 14
137	INDIVIDUAL EXPLORATION	CPT-1	RB-1	P-1	P-1/P-1B	P-1	P-2/AWC-1	WD-1/P-2	SS-1	P-1	7, 8
138	EARLY LEARNING	CPT-1	RB-1	P-1	P-1	P-1	P-1	WD-1/F-1/F-2/F-3/F-4/-F-5	SS-1	P-1	9, 10
142	DISCOVERY HALLWAY	CPT-1	RB-1	P-1	WD-1	P-1	P-1	WD-1/CPT-1	-	PET-1	11,13
143	CHILDREN'S LIBRARY	CPT-2	RB-2	P-1	P-1	P-1	P-1	WD-1/P-2	-	P-1	12

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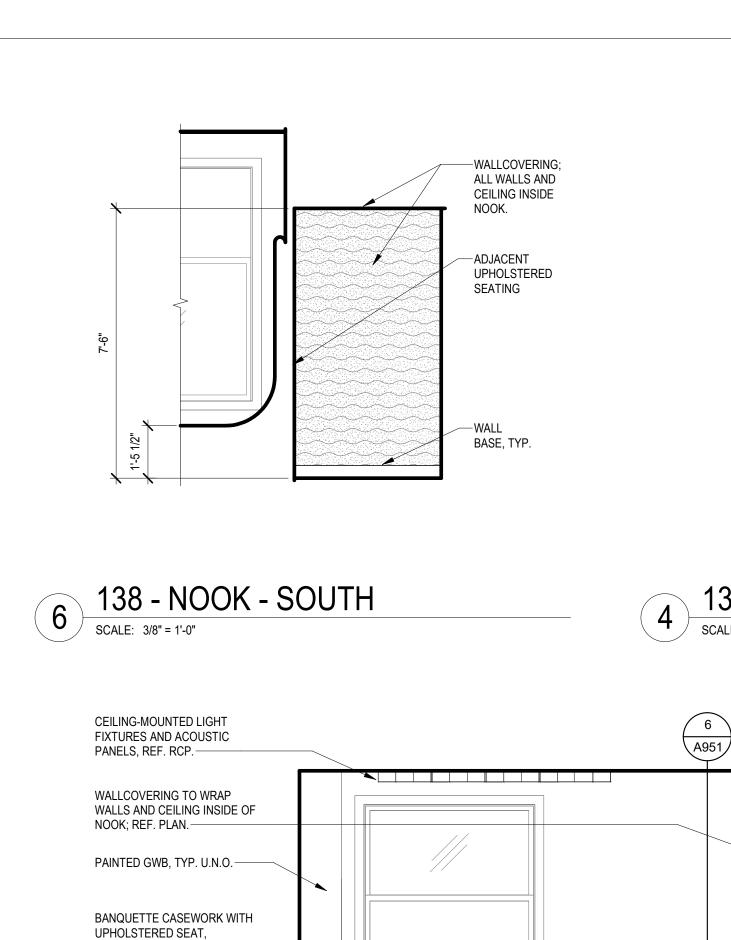
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SHEET TITLE

FINISH SCHEDULE & LEGEND

SHEET NO.



BOLSTERS AND PLYWOOD


F-2


F-4

138 - EARLY LEARNING - SOUTH

SCALE: 3/8" = 1'-0"

FINISHED FACES-

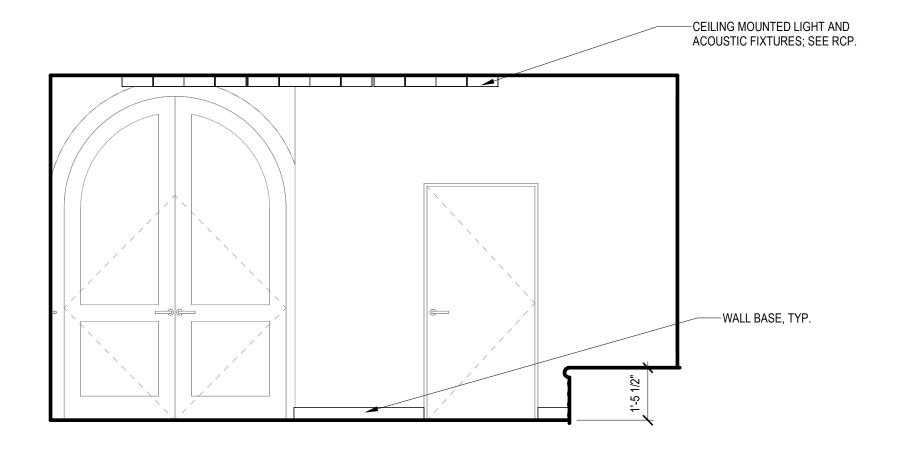


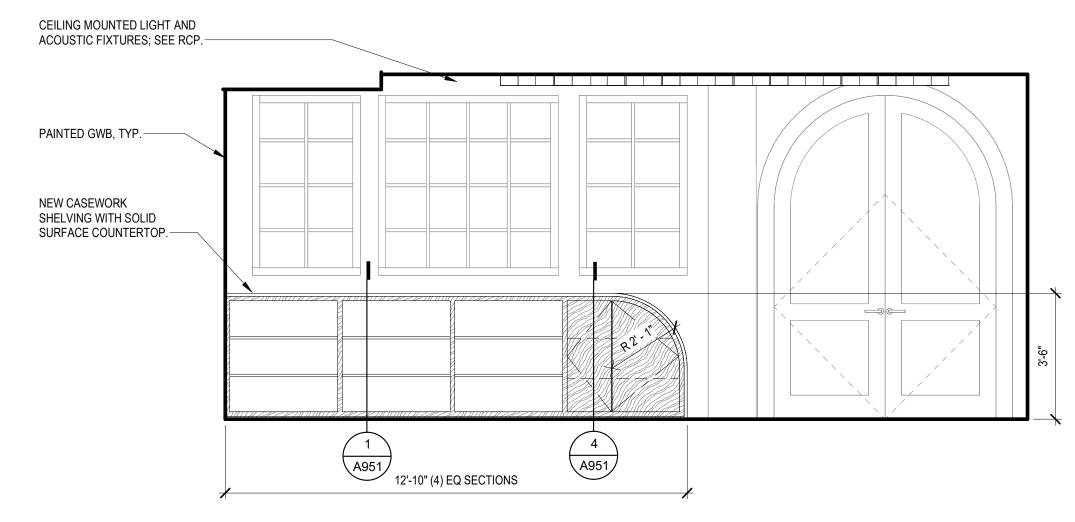

A951



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BUILDING

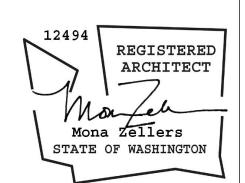-PLYWOOD SOFFIT

-UPHOLSTERED

-WALL BASE, TYP.

BANQUETTE SEAT WITH PLYWOOD FINISHED FACES; REF. DETAILS.

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138 - EARLY LEARNING - NORTH

SCALE: 3/8" = 1'-0"


A951

4' - 8"

3' - 0"

4 138 - EARLY LEARNING - EAST

SCALE: 3/8" = 1'-0"

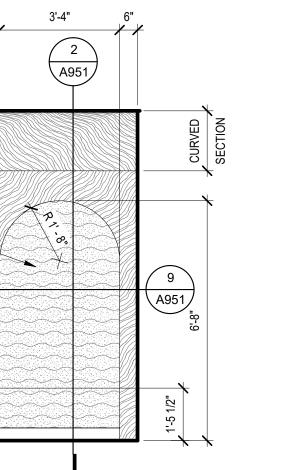

PLYWOOD FINISHED FACES AT OPENING, SEE DETAILS.— WALLCOVERING; ALL WALLS AND CEILING INSIDE NOOK-WALL BASE, TYP.—

2 138 - EARLY LEARNING - WEST

SCALE: 3/8" = 1'-0"


5 138 - NOOK - WEST

SCALE: 3/8" = 1'-0"

NEW GWB SOFFIT; PAINT TO TERMINATE AT INSIDE CORNERS— NEW ACOUSTIC LIGHTING FIXTURES PER RCP; COORDINATE WITH

3 135 - CHILDREN'S COZY READING - NORTH

SCALE: 3/8" = 1'-0"

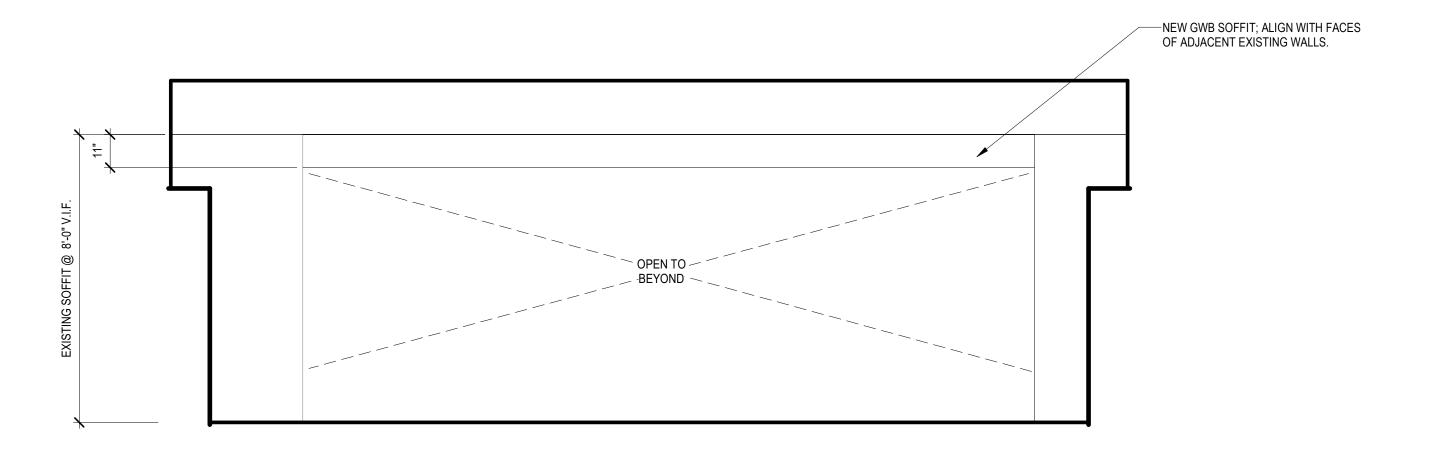


8 135 - CHILDREN'S COZY READING
SCALE: 3/8" = 1'-0"

SHEET TITLE

INTERIOR **ELEVATIONS**

SHEET NO.

A701

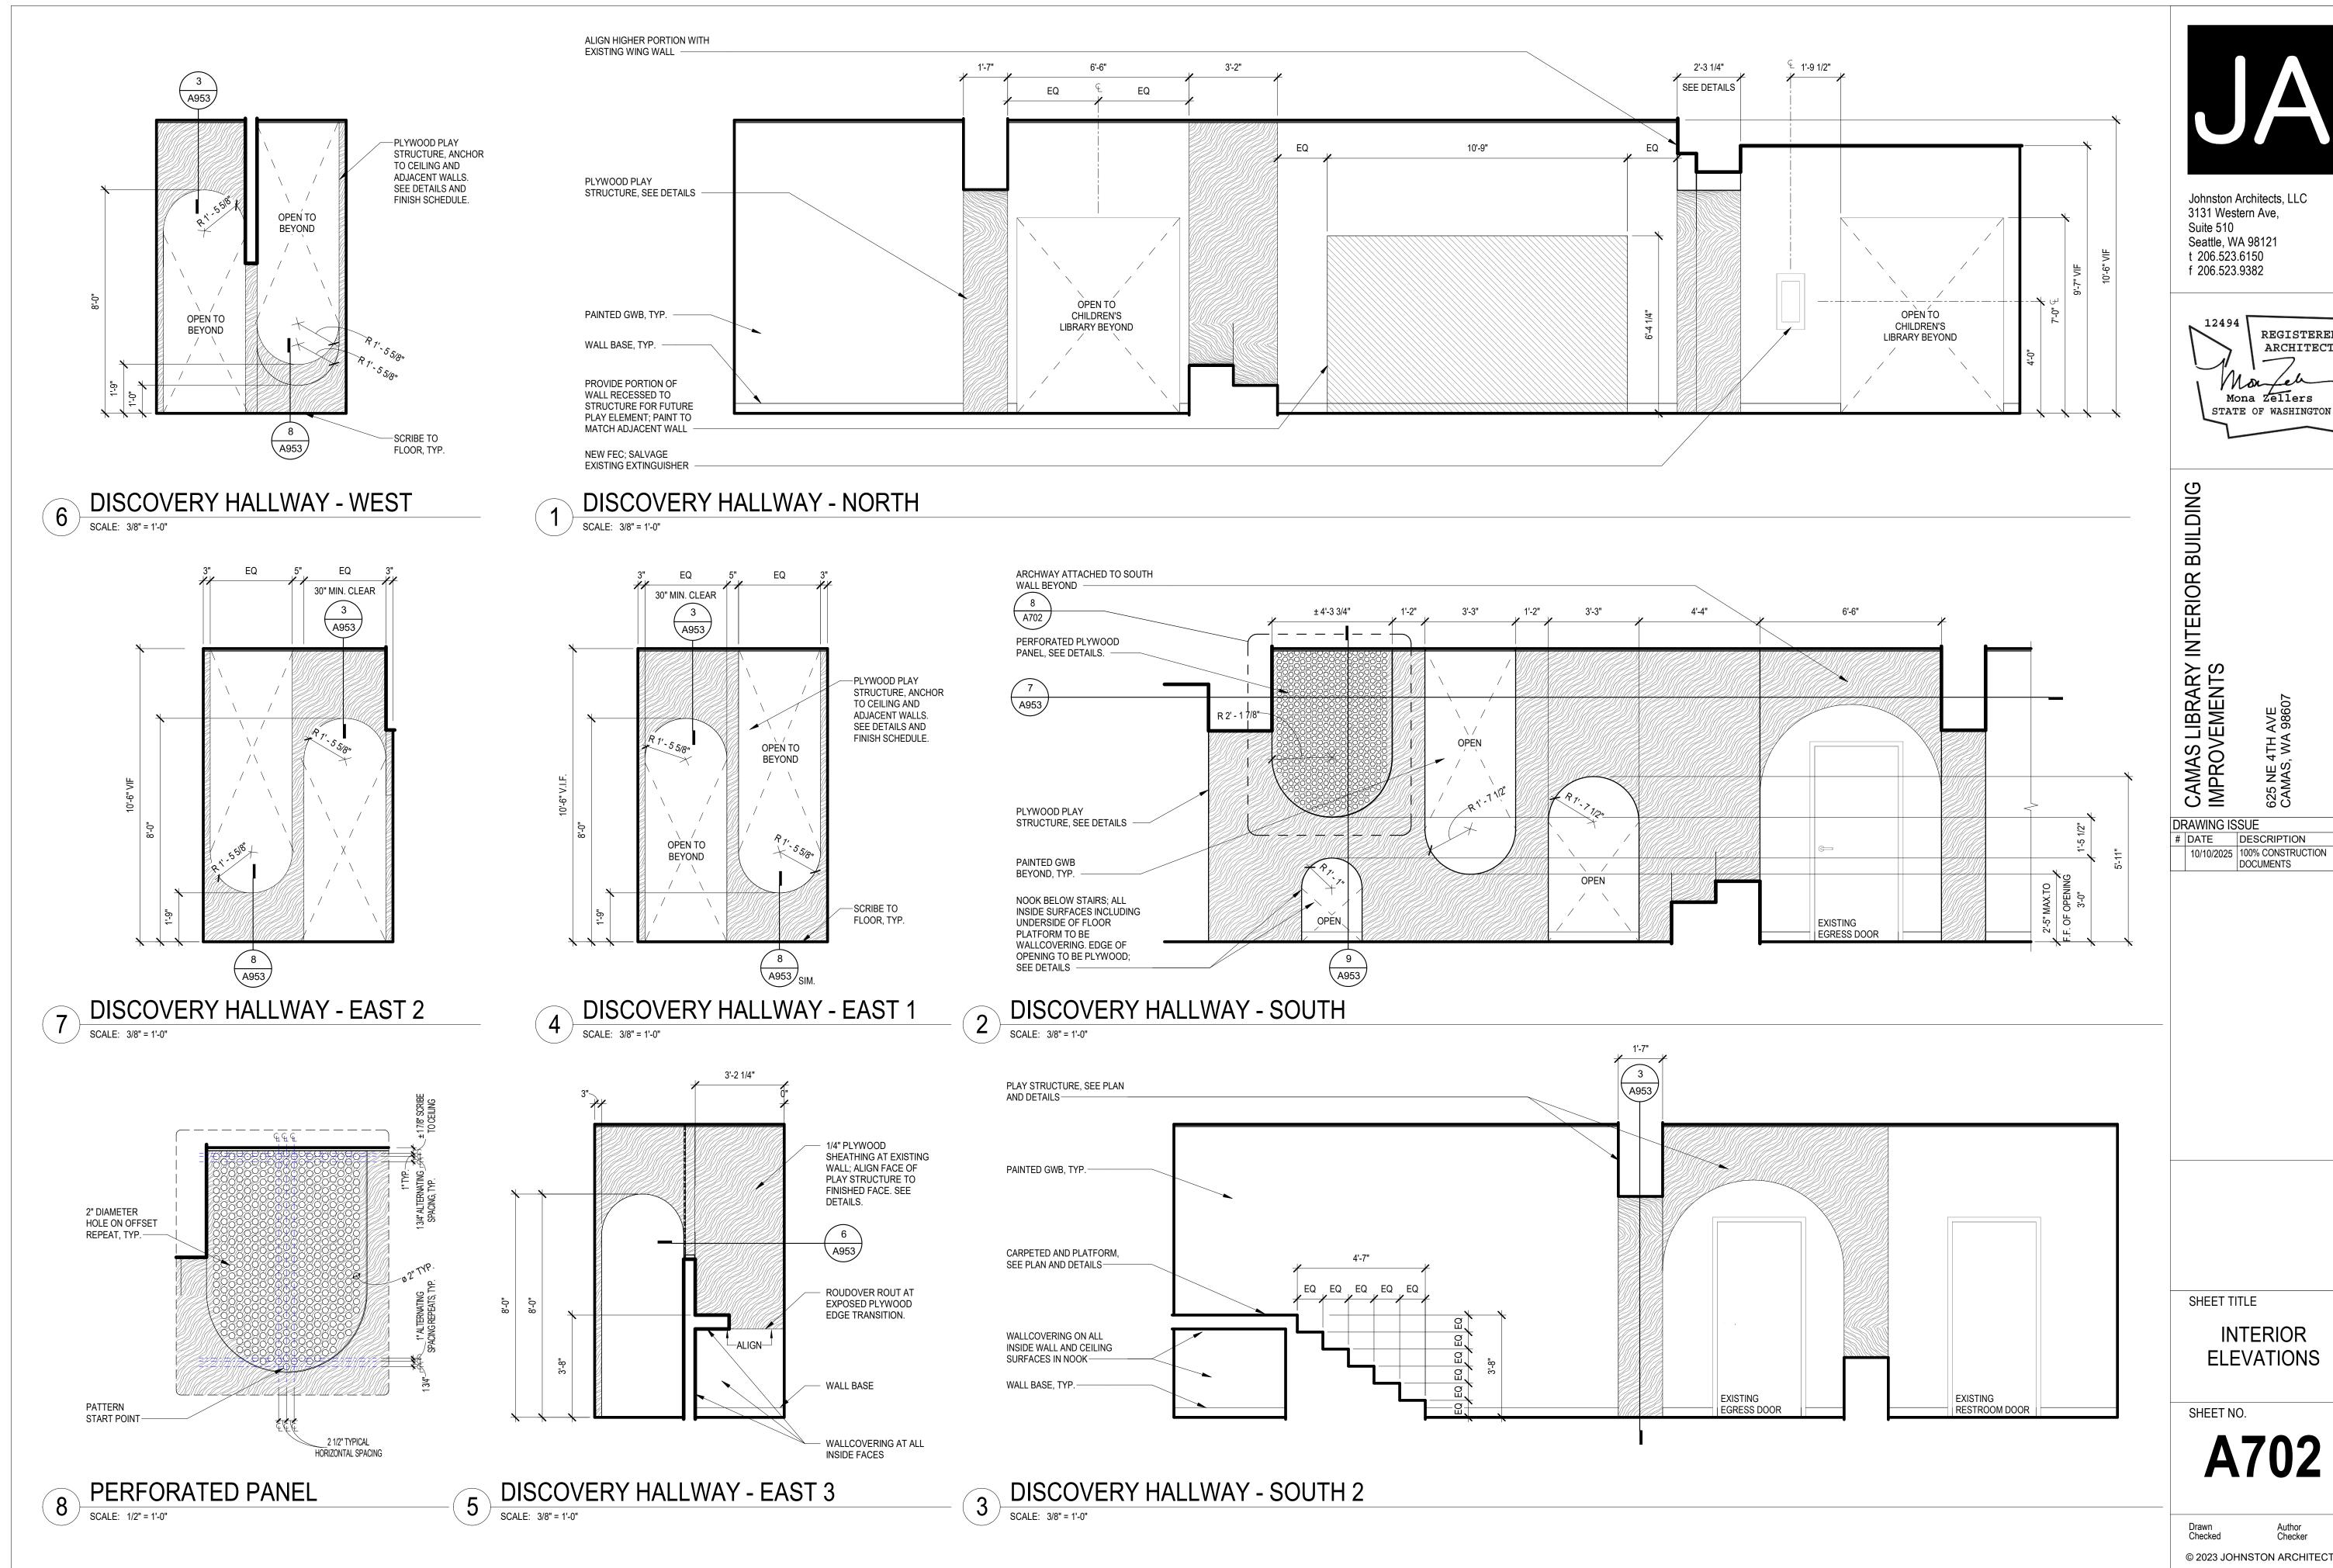

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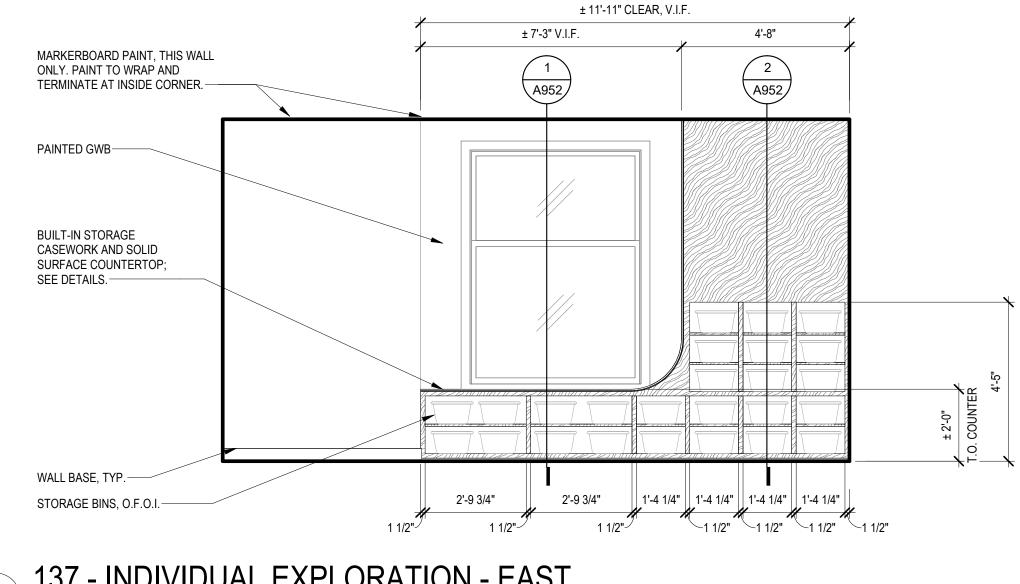
INTERIOR

REGISTERED


ARCHITECT

Mona Zellers


DOCUMENTS




137 - INDIVIDUAL EXPLORATION - EAST SCALE: 3/8" = 1'-0"

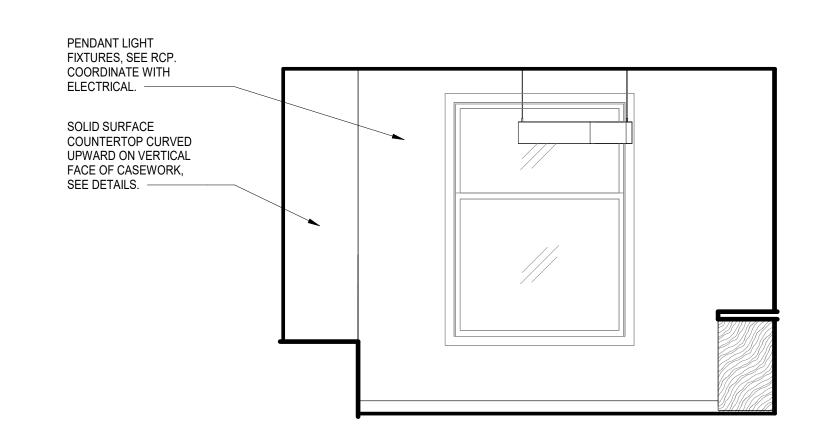

2 137 - INDIVIDUAL EXPLORATION - SOUTH SCALE: 3/8" = 1'-0"

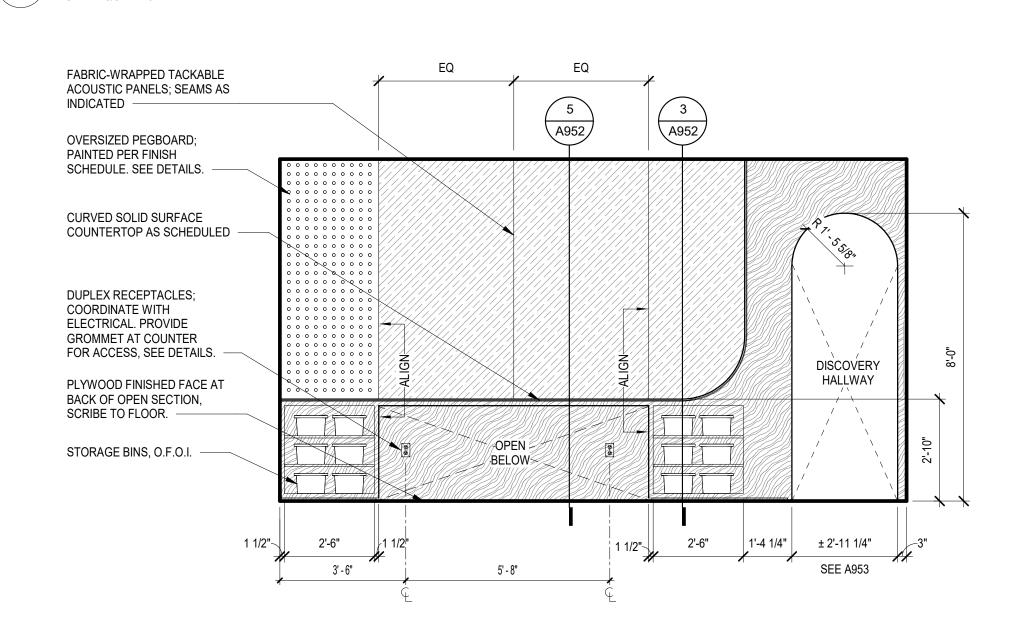

137 - INDIVIDUAL EXPLORATION - WEST SCALE: 3/8" = 1'-0"

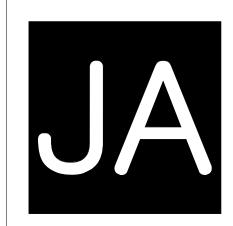

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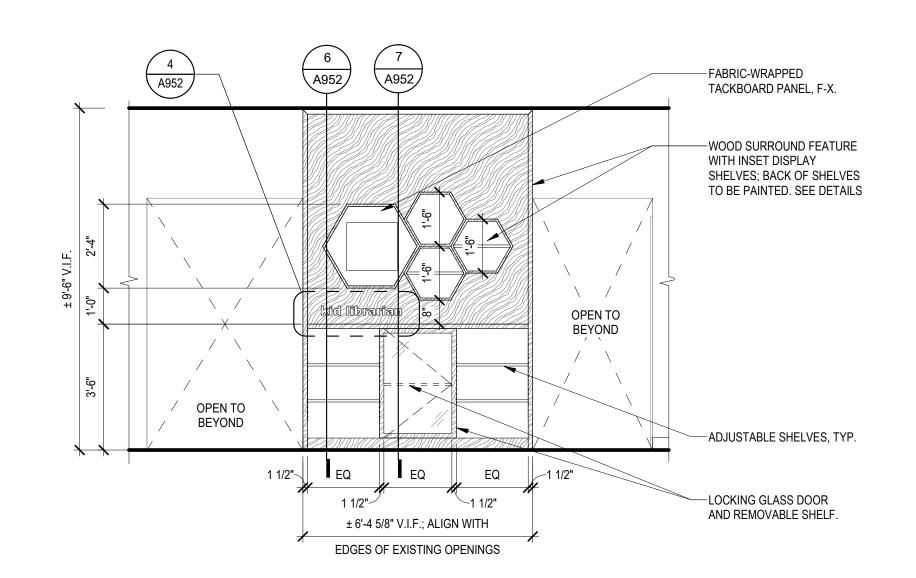
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INTERIOR **ELEVATIONS**

SHEET NO.


A703

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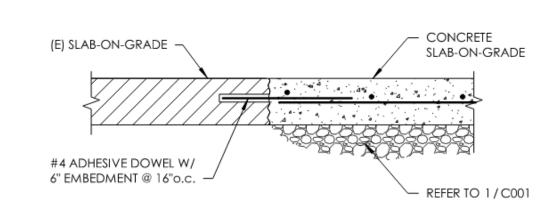



KID LIBRARIAN - EAST

SCALE: 3/8" = 1'-0"



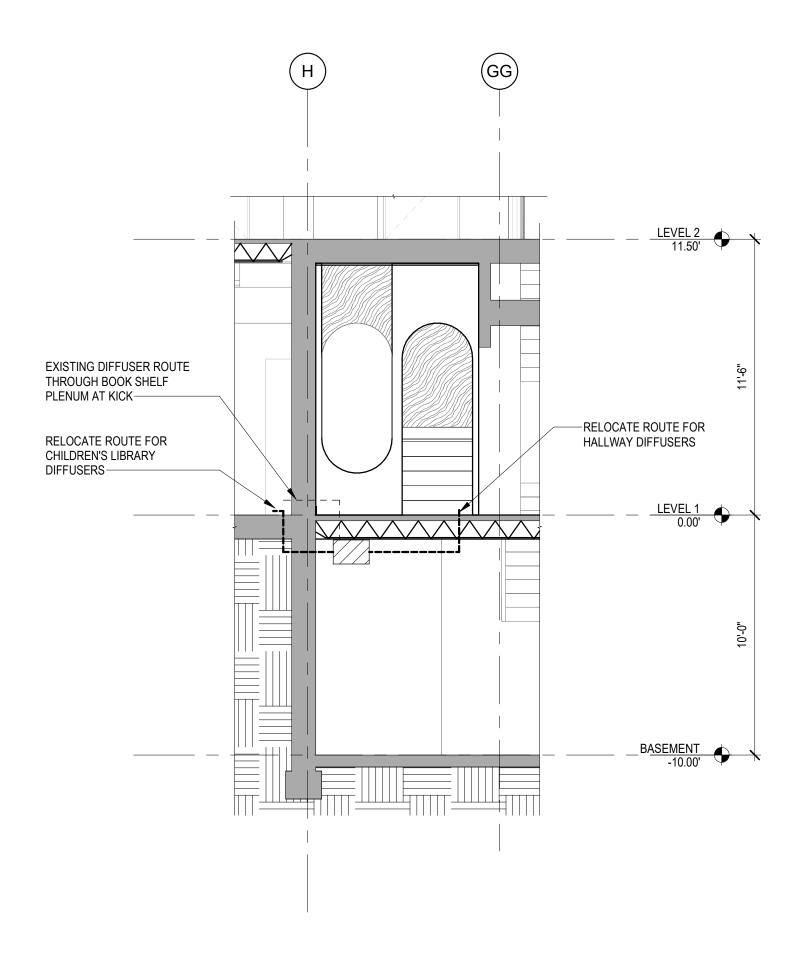



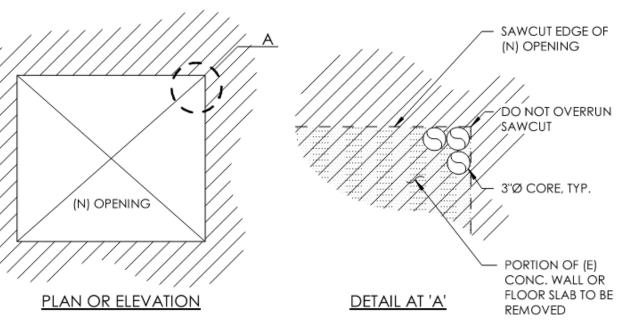


NOTES:

1. CUT OPENINGS IN (E) CONCRETE ONLY AS INDICATED IN THE STRUCTURAL DRAWINGS.

- CUT NEW OPENINGS AS FOLLOWS:
 - A. CORE HOLES AT EACH CORNER;
 - B. SAWCUT BETWEEN CORNERS; C. CHIP AWAY REMAINING CONCRETE AT CORED HOLES.
- 3. WHERE CUT REINFORCING WILL BE EXPOSED TO EARTH OR WEATHER, CHIP AWAY CONCRETE AROUND BAR TO 3/4" DEPTH ALL AROUND. CUT REINFORCING AND FILL HOLE WITH EPOXY.
- 4. DO NOT CUT NEW OPENINGS THROUGH (E) BEAMS, JOISTS, COLUMNS, OR PILASTERS, UNLESS SPECIFICALLY SHOWN AND NOTED ON THE STRUCTURAL DRAWINGS.
- 5. CONCRETE COMPRESSIVE STRENGTH, F'c = 3,000 PSI MINIMUM.
- 6. REINFORCING STEEL MINIMUM YIELD STRENGTH, Fy = 60,000 PSI MINIMUM
- 7. SPECIAL INSPECTION OF ADHESIVE DOWEL INSTALLATION REQUIRED.

(N) OPENINGS AND INFILL AT (E) CONCRETE WALL

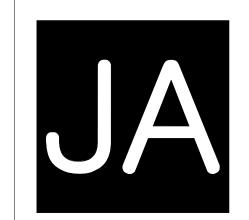

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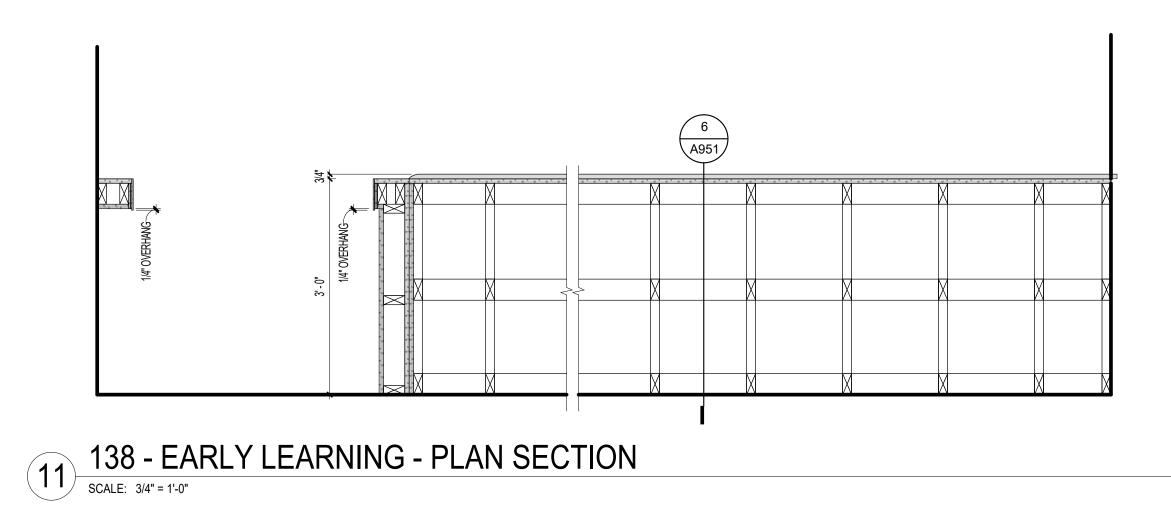
DING.

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SHEET TITLE


HVAC RELOCATION

SHEET NO.




SOLID SURFACE COUNTERTOP WITH 1/8" EASED SELF-EDGE; THICKNESS PER MANUFACTURER ROUTED REVEAL - 3/4" SOLID WOOD FACE FRAME, KEYED CYLINDER LOCK **₩** DOOR; 3/4" VENEERED PLYWOOD SHELVES; 1" VENEERED MELAMINE, FIXED HEIGHT TYP. SOLID WOOD EDGE BLOCK, FINISH TO MATCH BLOCKING AS REQUIRED; FACE AT REVEAL TO BE (1) LAYER OF 1/4" VENEERED PLYWOOD

4 138 - EARLY LEARNING - LOCKING CABINET SCALE: 1 1/2" = 1'-0"

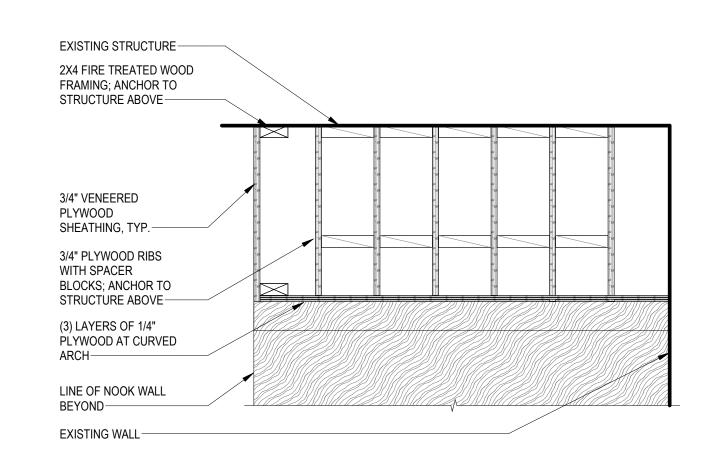


5 138 - PLYWOOD SOFFIT @ ARCH

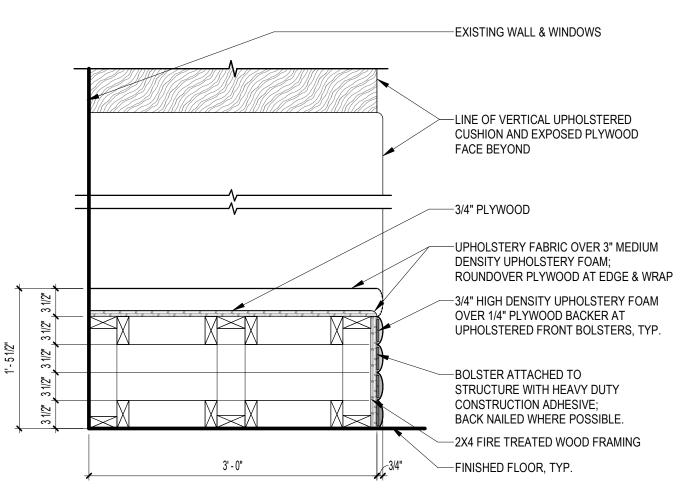


6 138 - EARLY LEARNING - BANQUETTE 1 SCALE: 1" = 1'-0"

SOLID SURFACE COUNTERTOP 1'-2" WITH 1/8" EASED SELF-EDGE; THICKNESS PER MANUFACTURER ROUTED REVEAL - 3/4" SOLID WOOD FACE FRAME, U.N.O. 1" VENEERED MELAMINE ADJUSTABLE SHELVES SOLID WOOD EDGE BLOCK, FINISH TO MATCH BLOCKING AS REQUIRED; FACE AT REVEAL TO BE (1) LAYER OF 1/4" VENEERED PLYWOOD

138 - EARLY LEARNING - OPEN SHELVES

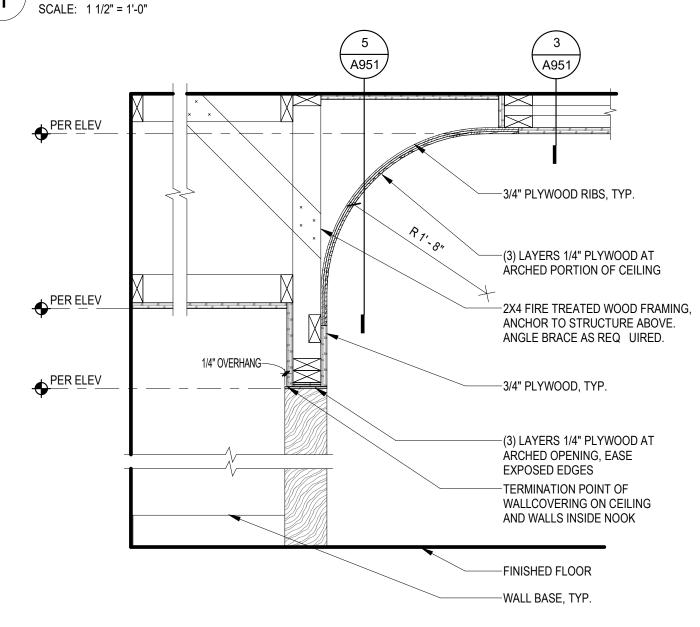

2 138 - EARLY LEARNING - SOFFIT @ NOOK SCALE: 1" = 1'-0"

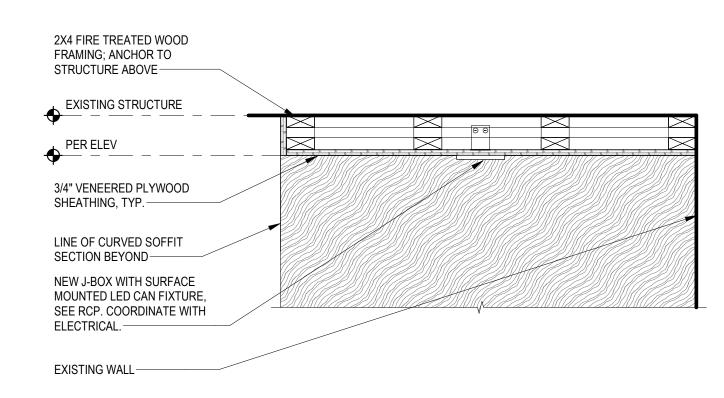

138 - EARLY LEARNING - PLYWOOD SOFFIT

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A951

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9 138 - EARLY LEARNING - BANQUETTE 2

SCALE: 1" = 1'-0"

EXISTING ADJACENT WALL/WINDOW-

2x4 FIRE TREATED

3/4" PLYWOOD, TYP.-

UPHOLSTERY FABRIC

UPHOLSTERY FOAM;

AT EDGE & WRAP-


ROUNDOVER PLYWOOD


LINE OF UPHOLSTERED


SEAT BELOW-

OVER 3" MEDIUM DENSITY


WOOD FRAMING-

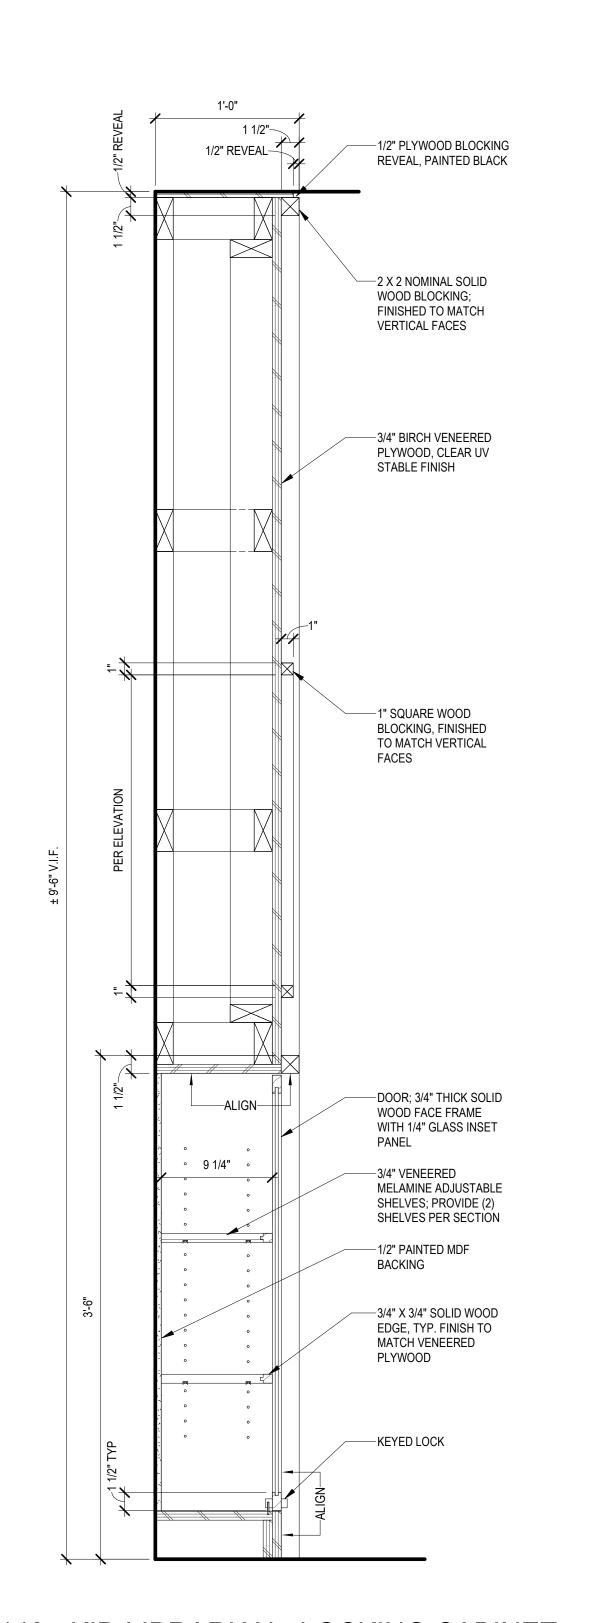

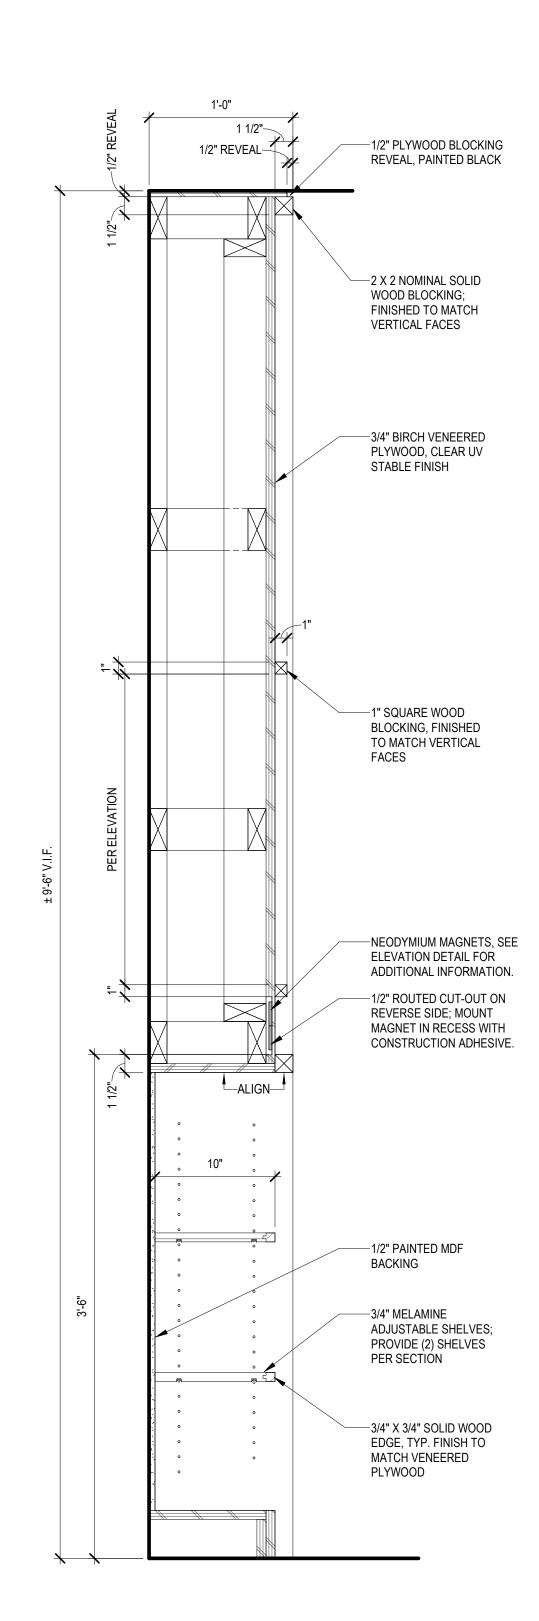


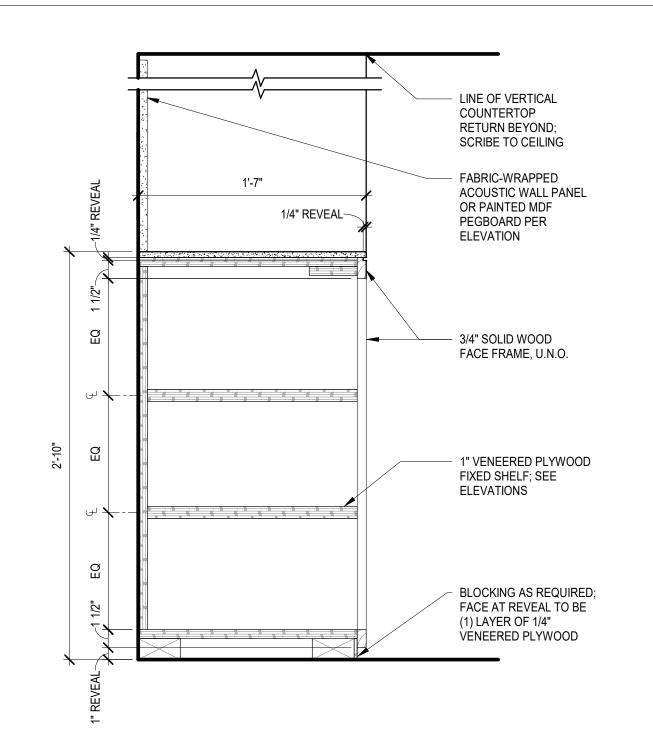


137 - WEST WALL STORAGE SCALE: 1 1/2" = 1'-0"

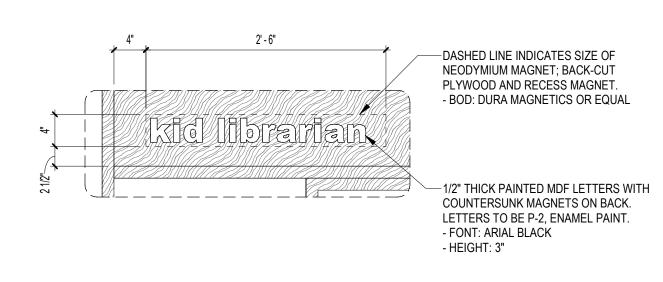


143 - KID LIBRARIAN - SIGNAGE DETAIL SCALE: 1" = 1'-0"

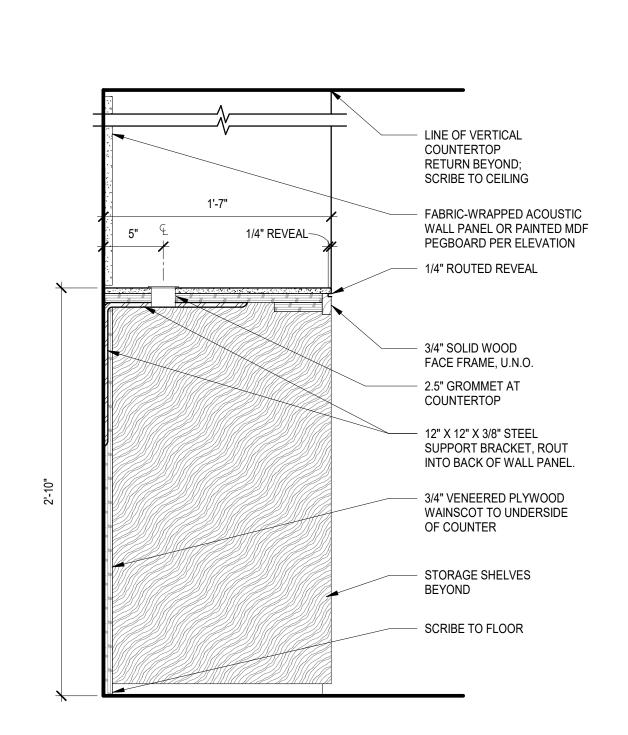

5 137 - WEST WALL OPEN COUNTER SCALE: 1 1/2" = 1'-0"

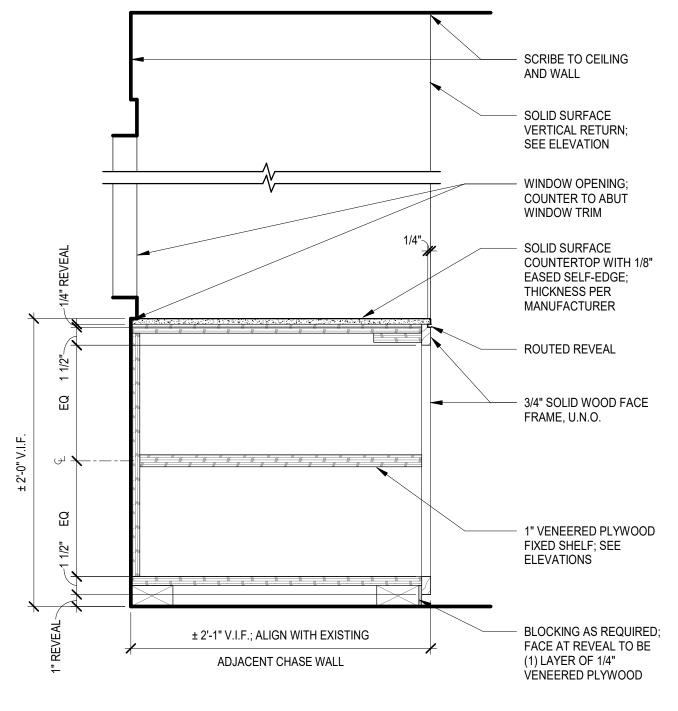

137 - EAST STORAGE, BELOW WINDOW SCALE: 1 1/2" = 1'-0"

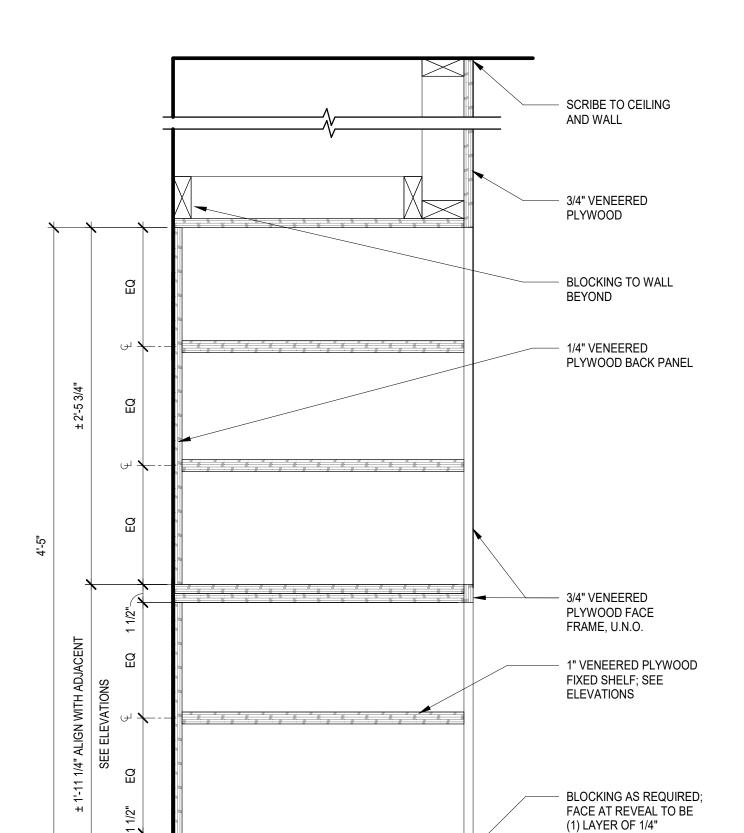

2 137 - EAST STORAGE, TALL SHELVES

SCALE: 1 1/2" = 1'-0"

± 2'-1" ALIGN WITH FACE OF EXISTING CHASE WALL

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INTERIOR DETAILS

SHEET NO.

VENEERED PLYWOOD

A952


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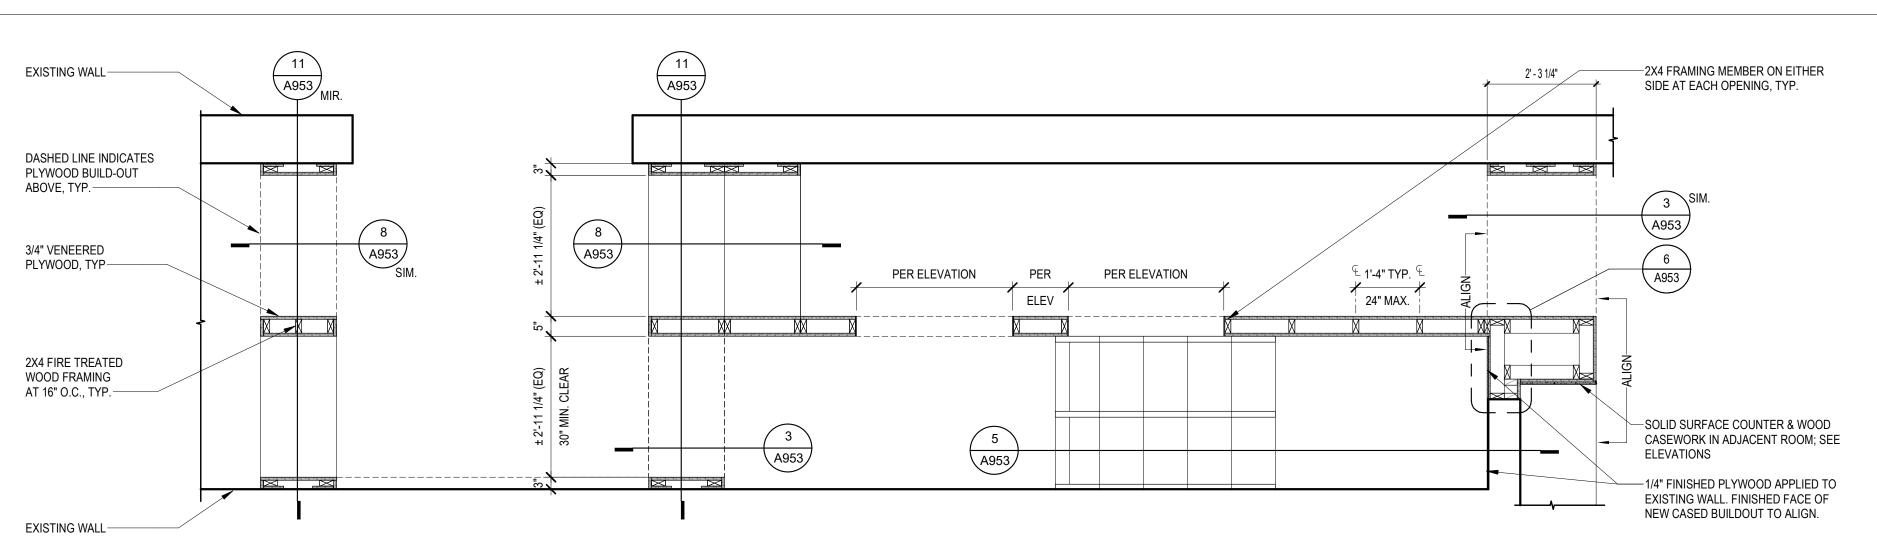
7 143 - KID LIBRARIAN - LOCKING CABINET

SCALE: 1 1/2" = 1'-0"


6 143 - KID LIBRARIAN - OPEN SHELVES


SCALE: 1 1/2" = 1'-0"



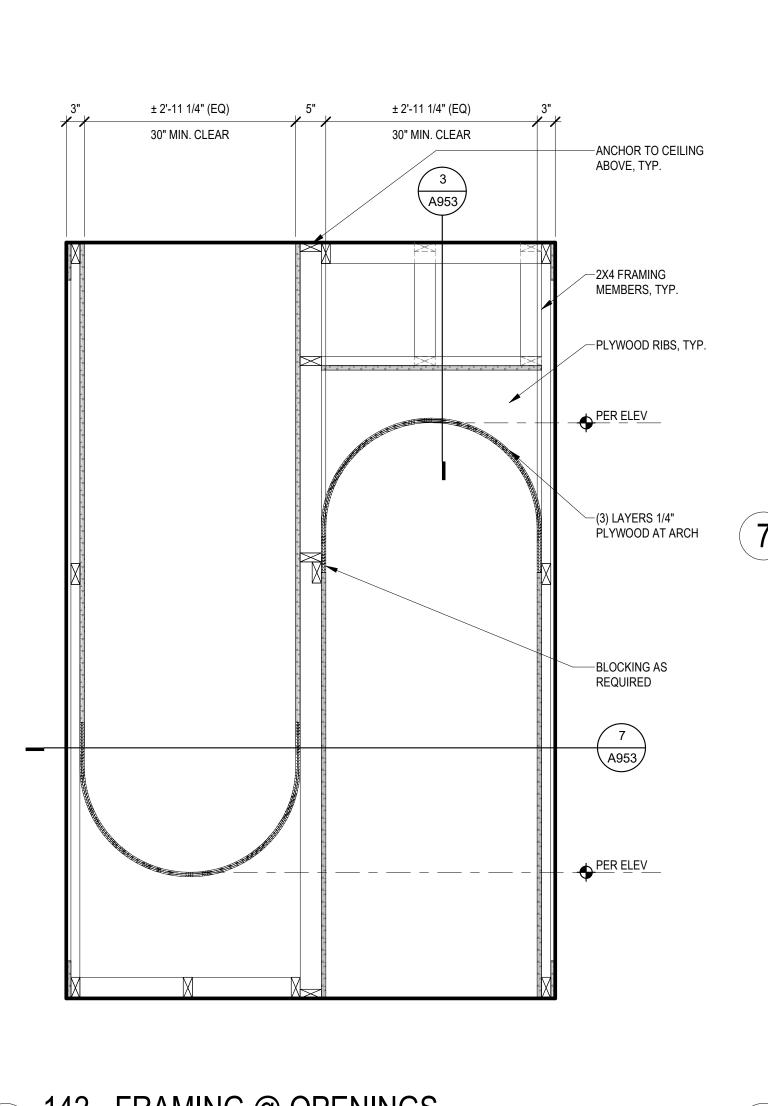




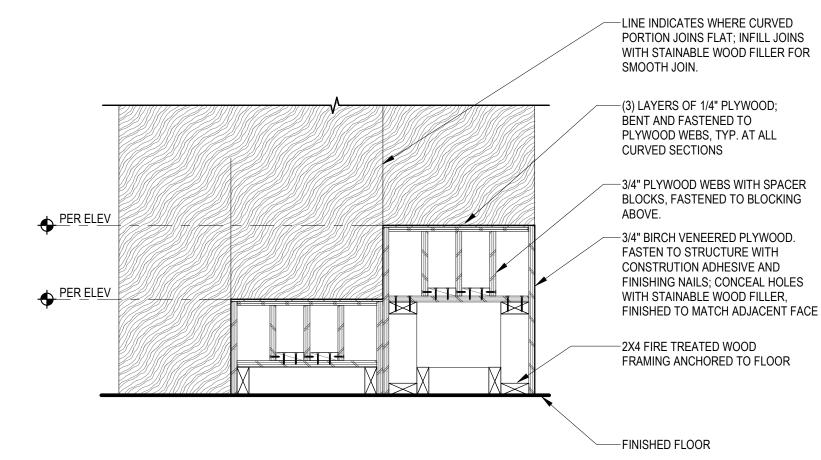

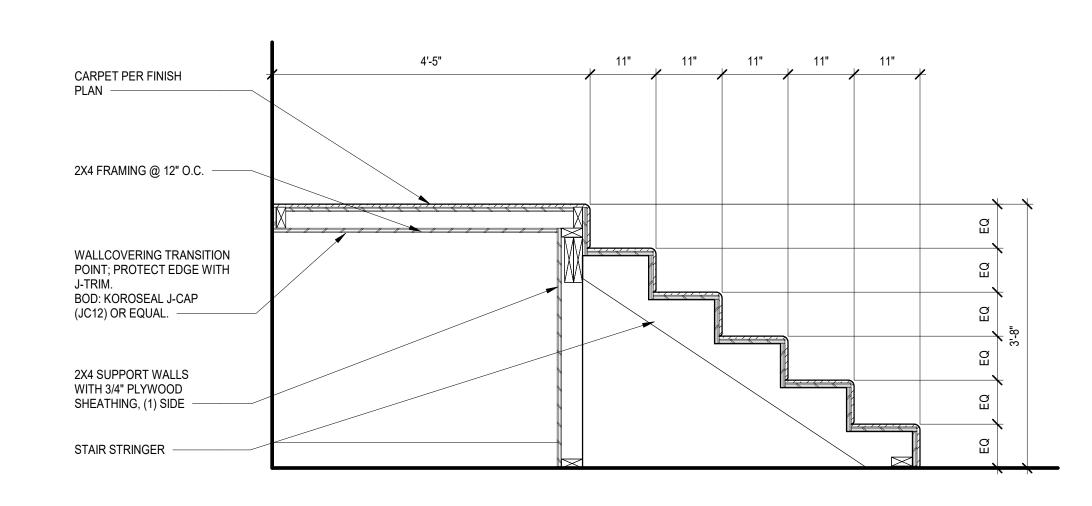




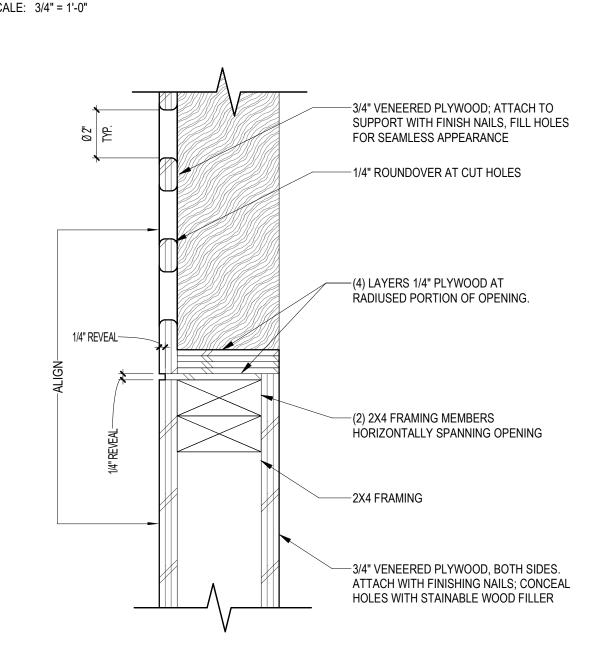

142 - PERFORATED PANEL ATTACHMENT

142 - SEATING ELEMENT


SCALE: 1/2" = 1'-0"

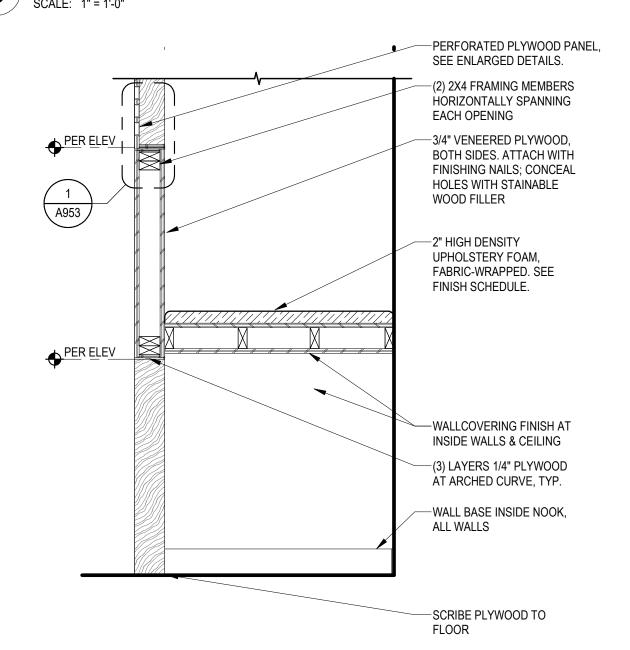


9 142 - FRAMING @ NOOK


SCALE: 3/4" = 1'-0"

142 - DISCOVERY HALLWAY - STAIR SECTION

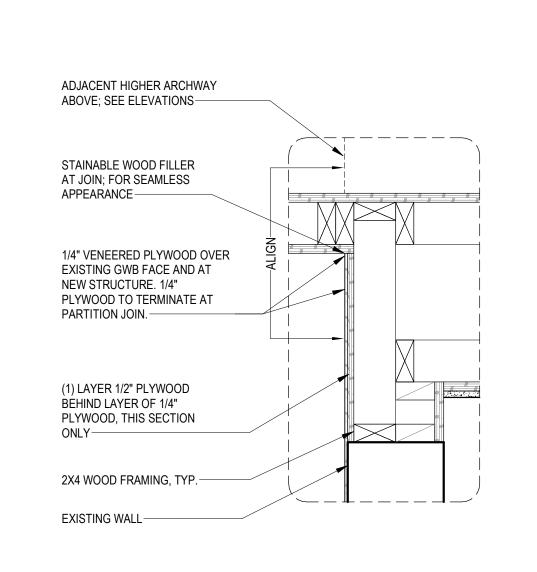


6 142 - TRANSITION @ EXISTING WALL
3 142 - TYPICAL HEADER
SCALE: 1 1/2" = 1'-0"

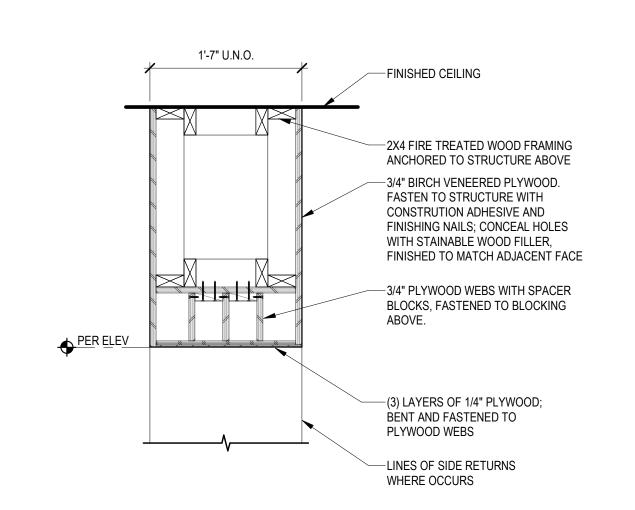

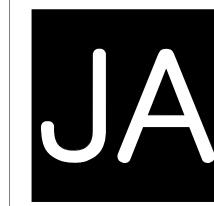

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SHEET TITLE **INTERIOR DETAILS** - DISCOVERY **HALLWAY**

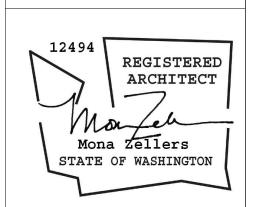SHEET NO.

A953

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ELEC

NOTE: This is a standard symbol list and not all items listed may be used.

AFC AFF ANSI	ons	Connections	<u>/ Equipment</u>
	ABOVE FINISHED FLOOR	Lv.	COMBINATION ADJUSTABLE FREQUENCY DRIVE WITH SAFETY
	ABOVE FINISHED FLOOR AMERICAN NATIONAL STANDARDS INSTITUTE	VFD	DISCONNECT SWITCH. FURNISHED BY DIVISION 23 AND INSTALLED BY DIVISION 26.
AWG	AMERICAN WIRE GAUGE		
A	AMPERES, AMBER	\boxtimes	COMBINATION MOTOR STARTER/FUSED DISCONNECT SWITCH
AHJ AIC	AUTHORITY HAVING JURISDICTION AVAILABLE INTERRUPTING CAPACITY		
BAS	BUILDING AUTOMATION SYSTEM	Н	HANDICAP ACCESS BUTTON BY OTHERS - SHOWN FOR
CA	CABLE		REFERENCE ONLY
CAT	CATEGORY		
CLG C	CEILING CONDUIT, CLOSE, CONTROL	F	HEAVY DUTY FUSED DISCONNECT SWITCH
COORD	COORDINATE		
CU	COPPER	\Diamond	MOTOR CONNECTION
dB	DECIBEL	O	
(X) DTL	DEMOLISH DETAIL		
DIA	DIAMETER		NON-FUSED DISCONNECT SWITCH
DIM	DIMENSION		
DIV	DIVISION	Т	TRANSFORMER
DN DWG	DOWN DRAWING		
EA	EACH		
EMT	ELECTRICAL METALLIC TUBING	FSD	FIRE SMOKE DAMPER
EL	ELEVATION		
E	EMERGENCY	(SD)	SMOKE DAMPER
EF (E)	EXHAUST FAN EXISTING		
FF	FINISH FLOOR	^	
FA	FIRE ALARM	0	CEILING MOUNTED JUNCTION BOX
FACP	FIRE ALARM CONTROL PANEL		
FMC FT	FLEXIBLE METAL CONDUIT FOOT, FEET	J	FLOOR MOUNTED JUNCTION BOX
FBO	FURNISHED BY OTHERS	_	
G, GND	GROUND		
GFCI	GROUND FAULT CIRCUIT INTERRUPTER	${\mathbb Q}$	WALL-MOUNTED JUNCTION BOX
GFI GFP	GROUND FAULT INTERRUPTER GROUND FAULT PROTECTION	Ciro Alores	
HH	HANDHOLE	Fire Alarm	
HT	HEIGHT	/ FACP	FIRE ALARM CONTROL PANEL
ID	IDENTIFICATION		TINE ALANW CONTROL LANCE
IN	INCH, INCHES	General	
IEEE	INSTITUTE OF ELECTRICAL AND ELECTRONICS ENGINEERS		
IMC	INTERMEDIATE METAL CONDUIT	$\left(\begin{array}{c} X \\ X \end{array}\right)$	DETAIL NUMBER AND SHEET LOCATION
IG	ISOLATED GROUND		
KV	KILOVOLT AMPERES	$\langle xx-x \rangle$	FOURDMENT IDENTIFICATION
KVA KW	KILOVOLT AMPERES KILOWATT	LOCATION	EQUIPMENT IDENTIFICATION
LED	LIGHT EMITTING DIODE	200/11/01/	
LFMC	LIQUIDTIGHT FLEXIBLE METAL CONDUIT	$\langle 1 \rangle$	KEYED NOTE
LV	LOW VOLTAGE MAXIMUM OVERCURRENT PROTECTION	_	
MOCP mA	MILLIAMPERES	V V	DEMOLISH
MIN	MINIMUM	—××	DEMOLISH
MCA	MINIMUM CIRCUIT AMPS		
MISC MCC	MISCELLANEOUS		EXISTING WORK
MT, MTD	MOTOR CONTROL CENTER MOUNT, MOUNTED		
NEC	NATIONAL ELECTRIC CODE		NEW WORK
NESC	NATIONAL ELECTRIC SAFETY CODE		NEW WORK
NEMA	NATIONAL ELECTRICAL MANUFACTURERS ASSOCIATION	<u>Lighting</u>	
N	NEUTRAL	<u> Ligitiiig</u>	COMBINATION EXIT SIGN CEILING MOUNTED AND DUAL HEAD
(N)	NEW	⋈	EMERGENCY EGRESS LIGHTING WITH BATTERY PACK.
N/A	NOT APPLICABLE		ARROW(S) INDICATES DIRECTION IF SHOWN
N.I.C.	NOT IN CONTRACT	4-4	COMBINATION EXIT SIGN WALL MOUNTED AND DUAL HEAD
	NOT TO SCALE ON CENTER	★	EMERGENCY EGRESS LIGHTING WITH BATTERY PACK. ARROW(S) INDICATES DIRECTION IF SHOWN
NTS	OWNER FURNISHED, CONTRACTOR INSTALLED		<i>、,</i>
OC OFCI	PANEL		EXIT SIGN CEILING MOUNTED, ARROW(S) INDICATES DIRECTION IF SHOWN
ОС		igotimes	
OC OFCI PNL PH	PHASE	፟	DIRECTION IF SHOWN
OC OFCI PNL PH PVC	POLY-VINYL-CHLORIDE		
OC OFCI PNL PH PVC PWR	POLY-VINYL-CHLORIDE POWER	⊗ <u>₹</u>	EXIT SIGN WALL MOUNTED, ARROW(S) INDICATES DIRECTION IF SHOWN
OC OFCI PNL PH PVC	POLY-VINYL-CHLORIDE		EXIT SIGN WALL MOUNTED, ARROW(S) INDICATES DIRECTION
OC OFCI PNL PH PVC PWR QTY REF (R)	POLY-VINYL-CHLORIDE POWER QUANTITY		EXIT SIGN WALL MOUNTED, ARROW(S) INDICATES DIRECTION
OC OFCI PNL PH PVC PWR QTY REF (R) RFI	POLY-VINYL-CHLORIDE POWER QUANTITY REFERENCE RELOCATE REQUEST FOR INFORMATION		EXIT SIGN WALL MOUNTED, ARROW(S) INDICATES DIRECTION IF SHOWN
OC OFCI PNL PH PVC PWR QTY REF (R) RFI REQD	POLY-VINYL-CHLORIDE POWER QUANTITY REFERENCE RELOCATE REQUEST FOR INFORMATION REQUIRED		EXIT SIGN WALL MOUNTED, ARROW(S) INDICATES DIRECTION IF SHOWN RECESSED 1' X 4' LUMINAIRE RECESSED 1' X 4' LUMINAIRE CONNECTED TO
OC OFCI PNL PH PVC PWR QTY REF (R) RFI	POLY-VINYL-CHLORIDE POWER QUANTITY REFERENCE RELOCATE REQUEST FOR INFORMATION		EXIT SIGN WALL MOUNTED, ARROW(S) INDICATES DIRECTION IF SHOWN RECESSED 1' X 4' LUMINAIRE
OC OFCI PNL PH PVC PWR QTY REF (R) RFI REQD RMC RM SHT	POLY-VINYL-CHLORIDE POWER QUANTITY REFERENCE RELOCATE REQUEST FOR INFORMATION REQUIRED RIGID METAL CONDUIT ROOM SHEET		EXIT SIGN WALL MOUNTED, ARROW(S) INDICATES DIRECTION IF SHOWN RECESSED 1' X 4' LUMINAIRE RECESSED 1' X 4' LUMINAIRE CONNECTED TO EMERGENCY/LIFE SAFETY CIRCUIT OR WITH INTEGRAL
OC OFCI PNL PH PVC PWR QTY REF (R) RFI REQD RMC RM SHT SIM	POLY-VINYL-CHLORIDE POWER QUANTITY REFERENCE RELOCATE REQUEST FOR INFORMATION REQUIRED RIGID METAL CONDUIT ROOM SHEET SIMILAR		EXIT SIGN WALL MOUNTED, ARROW(S) INDICATES DIRECTION IF SHOWN RECESSED 1' X 4' LUMINAIRE RECESSED 1' X 4' LUMINAIRE CONNECTED TO EMERGENCY/LIFE SAFETY CIRCUIT OR WITH INTEGRAL EMERGENCY BATTERY CONNECTED TO UNSWITCHED CIRCUIT
OC OFCI PNL PH PVC PWR QTY REF (R) RFI REQD RMC RM SHT SIM STD	POLY-VINYL-CHLORIDE POWER QUANTITY REFERENCE RELOCATE REQUEST FOR INFORMATION REQUIRED RIGID METAL CONDUIT ROOM SHEET SIMILAR STANDARD		EXIT SIGN WALL MOUNTED, ARROW(S) INDICATES DIRECTION IF SHOWN RECESSED 1' X 4' LUMINAIRE RECESSED 1' X 4' LUMINAIRE CONNECTED TO EMERGENCY/LIFE SAFETY CIRCUIT OR WITH INTEGRAL EMERGENCY BATTERY CONNECTED TO UNSWITCHED
OC OFCI PNL PH PVC PWR QTY REF (R) RFI REQD RMC RM SHT SIM STD SPD	POLY-VINYL-CHLORIDE POWER QUANTITY REFERENCE RELOCATE REQUEST FOR INFORMATION REQUIRED RIGID METAL CONDUIT ROOM SHEET SIMILAR STANDARD SURGE PROTECTION DEVICE		EXIT SIGN WALL MOUNTED, ARROW(S) INDICATES DIRECTION IF SHOWN RECESSED 1' X 4' LUMINAIRE RECESSED 1' X 4' LUMINAIRE CONNECTED TO EMERGENCY/LIFE SAFETY CIRCUIT OR WITH INTEGRAL EMERGENCY BATTERY CONNECTED TO UNSWITCHED CIRCUIT RECESSED 2' X 2' LUMINAIRE
OC OFCI PNL PH PVC PWR QTY REF (R) RFI REQD RMC RM SHT SIM STD	POLY-VINYL-CHLORIDE POWER QUANTITY REFERENCE RELOCATE REQUEST FOR INFORMATION REQUIRED RIGID METAL CONDUIT ROOM SHEET SIMILAR STANDARD		EXIT SIGN WALL MOUNTED, ARROW(S) INDICATES DIRECTION IF SHOWN RECESSED 1' X 4' LUMINAIRE RECESSED 1' X 4' LUMINAIRE CONNECTED TO EMERGENCY/LIFE SAFETY CIRCUIT OR WITH INTEGRAL EMERGENCY BATTERY CONNECTED TO UNSWITCHED CIRCUIT RECESSED 2' X 2' LUMINAIRE RECESSED 2' X 2' LUMINAIRE CONNECTED TO EMERGENCY/LIFE SAFETY CIRCUIT OR WITH INTEGRAL
OC OFCI PNL PH PVC PWR QTY REF (R) RFI REQD RMC RM SHT SIM STD SPD SWBD TBD XFMR	POLY-VINYL-CHLORIDE POWER QUANTITY REFERENCE RELOCATE REQUEST FOR INFORMATION REQUIRED RIGID METAL CONDUIT ROOM SHEET SIMILAR STANDARD SURGE PROTECTION DEVICE SWITCHBOARD TO BE DETERMINED TRANSFORMER		EXIT SIGN WALL MOUNTED, ARROW(S) INDICATES DIRECTION IF SHOWN RECESSED 1' X 4' LUMINAIRE RECESSED 1' X 4' LUMINAIRE CONNECTED TO EMERGENCY/LIFE SAFETY CIRCUIT OR WITH INTEGRAL EMERGENCY BATTERY CONNECTED TO UNSWITCHED CIRCUIT RECESSED 2' X 2' LUMINAIRE RECESSED 2' X 2' LUMINAIRE CONNECTED TO EMERGENCY/LIFE SAFETY CIRCUIT OR WITH INTEGRAL EMERGENCY BATTERY CONNECTED TO UNSWITCHED
OC OFCI PNL PH PVC PWR QTY REF (R) RFI REQD RMC RM SHT SIM STD SPD SWBD TBD XFMR TVSS	POLY-VINYL-CHLORIDE POWER QUANTITY REFERENCE RELOCATE REQUEST FOR INFORMATION REQUIRED RIGID METAL CONDUIT ROOM SHEET SIMILAR STANDARD SURGE PROTECTION DEVICE SWITCHBOARD TO BE DETERMINED TRANSFORMER TRANSIENT VOLTAGE SURGE SUPPRESSOR		EXIT SIGN WALL MOUNTED, ARROW(S) INDICATES DIRECTION IF SHOWN RECESSED 1' X 4' LUMINAIRE RECESSED 1' X 4' LUMINAIRE CONNECTED TO EMERGENCY/LIFE SAFETY CIRCUIT OR WITH INTEGRAL EMERGENCY BATTERY CONNECTED TO UNSWITCHED CIRCUIT RECESSED 2' X 2' LUMINAIRE RECESSED 2' X 2' LUMINAIRE CONNECTED TO EMERGENCY/LIFE SAFETY CIRCUIT OR WITH INTEGRAL
OC OFCI PNL PH PVC PWR QTY REF (R) RFI REQD RMC RM SHT SIM STD SPD SWBD TBD XFMR TVSS TYP	POLY-VINYL-CHLORIDE POWER QUANTITY REFERENCE RELOCATE REQUEST FOR INFORMATION REQUIRED RIGID METAL CONDUIT ROOM SHEET SIMILAR STANDARD SURGE PROTECTION DEVICE SWITCHBOARD TO BE DETERMINED TRANSFORMER TRANSIENT VOLTAGE SURGE SUPPRESSOR TYPICAL		EXIT SIGN WALL MOUNTED, ARROW(S) INDICATES DIRECTION IF SHOWN RECESSED 1' X 4' LUMINAIRE RECESSED 1' X 4' LUMINAIRE CONNECTED TO EMERGENCY/LIFE SAFETY CIRCUIT OR WITH INTEGRAL EMERGENCY BATTERY CONNECTED TO UNSWITCHED CIRCUIT RECESSED 2' X 2' LUMINAIRE RECESSED 2' X 2' LUMINAIRE CONNECTED TO EMERGENCY/LIFE SAFETY CIRCUIT OR WITH INTEGRAL EMERGENCY BATTERY CONNECTED TO UNSWITCHED
OC OFCI PNL PH PVC PWR QTY REF (R) RFI REQD RMC RM SHT SIM STD SPD SWBD TBD XFMR TVSS TYP UG	POLY-VINYL-CHLORIDE POWER QUANTITY REFERENCE RELOCATE REQUEST FOR INFORMATION REQUIRED RIGID METAL CONDUIT ROOM SHEET SIMILAR STANDARD SURGE PROTECTION DEVICE SWITCHBOARD TO BE DETERMINED TRANSFORMER TRANSIENT VOLTAGE SURGE SUPPRESSOR TYPICAL UNDERGROUND		EXIT SIGN WALL MOUNTED, ARROW(S) INDICATES DIRECTION IF SHOWN RECESSED 1' X 4' LUMINAIRE RECESSED 1' X 4' LUMINAIRE CONNECTED TO EMERGENCY/LIFE SAFETY CIRCUIT OR WITH INTEGRAL EMERGENCY BATTERY CONNECTED TO UNSWITCHED CIRCUIT RECESSED 2' X 2' LUMINAIRE RECESSED 2' X 2' LUMINAIRE CONNECTED TO EMERGENCY/LIFE SAFETY CIRCUIT OR WITH INTEGRAL EMERGENCY BATTERY CONNECTED TO UNSWITCHED CIRCUIT RECESSED 2' X 4' LUMINAIRE
OC OFCI PNL PH PVC PWR QTY REF (R) RFI REQD RMC RM SHT SIM STD SPD SWBD TBD XFMR TVSS TYP	POLY-VINYL-CHLORIDE POWER QUANTITY REFERENCE RELOCATE REQUEST FOR INFORMATION REQUIRED RIGID METAL CONDUIT ROOM SHEET SIMILAR STANDARD SURGE PROTECTION DEVICE SWITCHBOARD TO BE DETERMINED TRANSFORMER TRANSIENT VOLTAGE SURGE SUPPRESSOR TYPICAL		EXIT SIGN WALL MOUNTED, ARROW(S) INDICATES DIRECTION IF SHOWN RECESSED 1' X 4' LUMINAIRE RECESSED 1' X 4' LUMINAIRE CONNECTED TO EMERGENCY/LIFE SAFETY CIRCUIT OR WITH INTEGRAL EMERGENCY BATTERY CONNECTED TO UNSWITCHED CIRCUIT RECESSED 2' X 2' LUMINAIRE RECESSED 2' X 2' LUMINAIRE CONNECTED TO EMERGENCY/LIFE SAFETY CIRCUIT OR WITH INTEGRAL EMERGENCY BATTERY CONNECTED TO UNSWITCHED CIRCUIT RECESSED 2' X 4' LUMINAIRE RECESSED 2' X 4' LUMINAIRE
OC OFCI PNL PH PVC PWR QTY REF (R) REQD RMC RM SHT SIM STD SWBD TBD XFMR TVSS TYP UPS UON	POLY-VINYL-CHLORIDE POWER QUANTITY REFERENCE RELOCATE REQUEST FOR INFORMATION REQUIRED RIGID METAL CONDUIT ROOM SHEET SIMILAR STANDARD SURGE PROTECTION DEVICE SWITCHBOARD TO BE DETERMINED TRANSFORMER TRANSIENT VOLTAGE SURGE SUPPRESSOR TYPICAL UNDERGROUND UNDERWRITERS LABORATORIES UNINTERRUPTIBLE POWER SUPPLY UNLESS OTHERWISE NOTED		EXIT SIGN WALL MOUNTED, ARROW(S) INDICATES DIRECTION IF SHOWN RECESSED 1' X 4' LUMINAIRE RECESSED 1' X 4' LUMINAIRE CONNECTED TO EMERGENCY/LIFE SAFETY CIRCUIT OR WITH INTEGRAL EMERGENCY BATTERY CONNECTED TO UNSWITCHED CIRCUIT RECESSED 2' X 2' LUMINAIRE RECESSED 2' X 2' LUMINAIRE CONNECTED TO EMERGENCY/LIFE SAFETY CIRCUIT OR WITH INTEGRAL EMERGENCY BATTERY CONNECTED TO UNSWITCHED CIRCUIT RECESSED 2' X 4' LUMINAIRE RECESSED 2' X 4' LUMINAIRE RECESSED 2' X 4' LUMINAIRE CONNECTED TO EMERGENCY/LIFE SAFETY CIRCUIT OR WITH INTEGRAL EMERGENCY/LIFE SAFETY CIRCUIT OR WITH INTEGRAL EMERGENCY BATTERY CONNECTED TO UNSWITCHED
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OC OFCI PH PVC PWR QTY REF REQD RMC SHT SIM STD SWBD TBD XFMR TVSS TYP UPS UPS UPS VFD V	POLY-VINYL-CHLORIDE POWER QUANTITY REFERENCE RELOCATE REQUEST FOR INFORMATION REQUIRED RIGID METAL CONDUIT ROOM SHEET SIMILAR STANDARD SURGE PROTECTION DEVICE SWITCHBOARD TO BE DETERMINED TRANSFORMER TRANSIENT VOLTAGE SURGE SUPPRESSOR TYPICAL UNDERGROUND UNDERWRITERS LABORATORIES UNINTERRUPTIBLE POWER SUPPLY UNLESS OTHERWISE NOTED VARIABLE FREQUENCY DRIVE VOLTS, VOLTAGE		EXIT SIGN WALL MOUNTED, ARROW(S) INDICATES DIRECTION IF SHOWN RECESSED 1' X 4' LUMINAIRE RECESSED 1' X 4' LUMINAIRE CONNECTED TO EMERGENCY/LIFE SAFETY CIRCUIT OR WITH INTEGRAL EMERGENCY BATTERY CONNECTED TO UNSWITCHED CIRCUIT RECESSED 2' X 2' LUMINAIRE RECESSED 2' X 2' LUMINAIRE CONNECTED TO EMERGENCY/LIFE SAFETY CIRCUIT OR WITH INTEGRAL EMERGENCY/LIFE SAFETY CONNECTED TO UNSWITCHED CIRCUIT RECESSED 2' X 4' LUMINAIRE RECESSED 2' X 4' LUMINAIRE CONNECTED TO EMERGENCY/LIFE SAFETY CIRCUIT OR WITH INTEGRAL EMERGENCY BATTERY CONNECTED TO UNSWITCHED CIRCUIT
OC OFCI PNL PH PVC PWR QTY REF (R) REQD RMC RM SHT SIM STD SWBD TBD XFMR TVSS TYP UG UPS UON VFD	POLY-VINYL-CHLORIDE POWER QUANTITY REFERENCE RELOCATE REQUEST FOR INFORMATION REQUIRED RIGID METAL CONDUIT ROOM SHEET SIMILAR STANDARD SURGE PROTECTION DEVICE SWITCHBOARD TO BE DETERMINED TRANSFORMER TRANSIENT VOLTAGE SURGE SUPPRESSOR TYPICAL UNDERGROUND UNDERWRITERS LABORATORIES UNINTERRUPTIBLE POWER SUPPLY UNLESS OTHERWISE NOTED VARIABLE FREQUENCY DRIVE		EXIT SIGN WALL MOUNTED, ARROW(S) INDICATES DIRECTION IF SHOWN RECESSED 1' X 4' LUMINAIRE RECESSED 1' X 4' LUMINAIRE CONNECTED TO EMERGENCY/LIFE SAFETY CIRCUIT OR WITH INTEGRAL EMERGENCY BATTERY CONNECTED TO UNSWITCHED CIRCUIT RECESSED 2' X 2' LUMINAIRE RECESSED 2' X 2' LUMINAIRE CONNECTED TO EMERGENCY/LIFE SAFETY CIRCUIT OR WITH INTEGRAL EMERGENCY BATTERY CONNECTED TO UNSWITCHED CIRCUIT RECESSED 2' X 4' LUMINAIRE RECESSED 2' X 4' LUMINAIRE RECESSED 2' X 4' LUMINAIRE CONNECTED TO EMERGENCY/LIFE SAFETY CIRCUIT OR WITH INTEGRAL EMERGENCY/LIFE SAFETY CIRCUIT OR WITH INTEGRAL EMERGENCY BATTERY CONNECTED TO UNSWITCHED
OC OFCI PNL PVC PWR QTY REF RMC RM SHT SIM STD SWBD TBD XFMR TVSS TYP UG UPS UN VFD WP	POLY-VINYL-CHLORIDE POWER QUANTITY REFERENCE RELOCATE REQUEST FOR INFORMATION REQUIRED RIGID METAL CONDUIT ROOM SHEET SIMILAR STANDARD SURGE PROTECTION DEVICE SWITCHBOARD TO BE DETERMINED TRANSFORMER TRANSIENT VOLTAGE SURGE SUPPRESSOR TYPICAL UNDERGROUND UNDERWRITERS LABORATORIES UNINTERRUPTIBLE POWER SUPPLY UNLESS OTHERWISE NOTED VARIABLE FREQUENCY DRIVE VOLTS, VOLTAGE WEATHERPROOF		EXIT SIGN WALL MOUNTED, ARROW(S) INDICATES DIRECTION IF SHOWN RECESSED 1' X 4' LUMINAIRE RECESSED 1' X 4' LUMINAIRE CONNECTED TO EMERGENCY/LIFE SAFETY CIRCUIT OR WITH INTEGRAL EMERGENCY BATTERY CONNECTED TO UNSWITCHED CIRCUIT RECESSED 2' X 2' LUMINAIRE RECESSED 2' X 2' LUMINAIRE CONNECTED TO EMERGENCY/LIFE SAFETY CIRCUIT OR WITH INTEGRAL EMERGENCY BATTERY CONNECTED TO UNSWITCHED CIRCUIT RECESSED 2' X 4' LUMINAIRE RECESSED 2' X 4' LUMINAIRE RECESSED 2' X 4' LUMINAIRE CONNECTED TO EMERGENCY/LIFE SAFETY CIRCUIT OR WITH INTEGRAL EMERGENCY BATTERY CONNECTED TO UNSWITCHED CIRCUIT

TRICAL S	SYMBOL LIST
ETY	SURFACE MOUNTED 2' X 2' LUMINAIRE CONNECTED TO EMERGENCY/LIFE SAFETY CIRCUIT OR WITH INTEGRAL EMERGENCY BATTERY CONNECTED TO UNSWITCHED CIRCUIT
СН	SURFACE MOUNTED 2' X 4' LUMINAIRE
•	SURFACE MOUNTED 2' X 4' LUMINAIRE CONNECTED TO EMERGENCY/LIFE SAFETY CIRCUIT OR WITH INTEGRAL EMERGENCY BATTERY CONNECTED TO UNSWITCHED CIRCUIT
	SURFACE OR PENDANT MOUNTED 1' X 4' LUMINAIRE
•	SURFACE OR PENDANT MOUNTED 1' X 4' LUMINAIRE CONNECTED TO EMERGENCY/LIFE SAFETY CIRCUIT OR WITH INTEGRAL EMERGENCY BATTERY CONNECTED TO UNSWITCHED CIRCUIT SURFACE OR PENDANT MOUNTED LUMINAIRE CONNECTED TO EMERGENCY/LIFE SAFETY CIRCUIT OR WITH INTEGRAL EMERGENCY BATTERY CONNECTED TO UNSWITCHED CIRCUIT
	SURFACE OR PENDANT MOUNTED STRIPLIGHT
<u> </u>	WALL MOUNTED 6" WIDE LUMINAIRE
_	WALL MOUNTED 6" WIDE LUMINAIRE CONNECTED TO EMERGENCY/LIFE SAFETY CIRCUIT OR WITH INTEGRAL EMERGENCY BATTERY CONNECTED TO UNSWITCHED CIRCUIT
ŢŎŢ	WALL MOUNTED 12" WIDE LUMINAIRE
	WALL MOUNTED 12" WIDE LUMINAIRE CONNECTED TO EMERGENCY/LIFE SAFETY CIRCUIT OR WITH INTEGRAL EMERGENCY BATTERY CONNECTED TO UNSWITCHED CIRCUIT
2	WALL MOUNTED LUMINAIRE
•	WALL MOUNTED LUMINAIRE CONNECTED TO EMERGENCY/LIFE SAFETY CIRCUIT OR WITH INTEGRAL EMERGENCY BATTERY CONNECTED TO UNSWITCHED CIRCUIT
<u>Miscellaneou</u>	IS BRANCH CIRCUIT WIRING. ARROW INDICATES HOME RUN TO
#10 	PANEL WITH CIRCUITS AS NOTED. WIRE SIZE IS #12 AWG MINIMUM UNLESS NOTED OTHERWISE. SHORT TICK MARKS INDICATE PHASE CONDUCTORS. LONG TICK MARKS INDICATE NEUTRAL CONDUCTORS. A SINGLE CURVED TICK MARK INDICATES INSULATED GREEN GROUND CONDUCTOR. SECOND CURVED TICK MARK INDICATES "ISOLATED GROUND" (GREEN INSULATION WITH YELLOW STRIPE) CONDUCTOR.
_	BRANCH PANEL
	CIRCUIT BREAKER
mm mm	DRY TYPE TRANSFORMER
4	FLUSH WALL MOUNTED BRANCH PANEL
AD GB	GROUND BAR
	MAIN DISTRIBUTION PANEL / SUB DISTRIBUTION PANEL
Raceways	CONDUIT CONCEALED IN WALL OR CEILING SPACE
	CONDUIT ROUTED BELOW FLOOR / GRADE
_	

CONDUIT ELLED DOWN

CONDUIT/WIRING CONTINUATION

— CONDUIT ELLED UP

----- FLEXIBLE CONDUIT **Switches and Receptacles MULTIPLE OPTIONS)** A = ABOVE COUNTER B = CLOCK HANGER E = EMERGENCY H = HOSPITAL GRADE TED LENGTH S = SPLIT WIRED T = TAMPER RESISTANT SHUTTERED RECEPTACLE U = USB PORT(S)RECEPTACLE JN TO P = PASSIVE INFRARED RKS

CONDUIT/WIRING STUBBED OUT WITH END CAP OR INSULATED PLASTIC BUSHING DUPLEX RECEPTACLE (MULTIPLE LETTERS INDICATE

C = FLUSH CEILING MOUNTED F = ARC FAULT PROTECTED BY BREAKER IN PANEL G = GROUND FAULT CIRCUIT INTERRUPTER K = CHILD RESISTANT COVER L = ISOLATED GROUND

P = PENDANT MOUNTED WITH CORD GRIPS. VERIFY PENDANT R1 = HALF SWITCHED BY OCCUPANCY SENSOR RELAY R2 = FULLY SWITCHED BY OCCUPANCY SENSOR RELAY

W = WEATHERPROOF CONTINUOUS USE COVER, GFCI PROTECTED, WITH WEATHER-RESISTANT RECEPTACLE

DUPLEX RECEPTACLE, FLUSH FLOOR

DOUBLE DUPLEX RECEPTACLE, FLUSH FLOOR

DOUBLE DUPLEX RECEPTACLE. SEE LETTER CODE LIST AT DUPLEX RECEPTACLE FOR OPTIONS

EQUIPMENT ELECTRICAL CONNECTION

SPECIAL PURPOSE RECEPTACLE. LETTER CODE DENOTES RECEPTACLE CONFIGURATION LX-XXR = NEMA CONFIGURATION TWIST-LOCK RECEPTACLE X-XXR = NEMA CONFIGURATION STRAIGHT BLADE

P = PENDANT MOUNT WITH CORD GRIPS. VERIFY PENDANT X = COORDINATE RECEPTACLE CONFIGURATION WITH

EQUIPMENT BEING SUPPLIED CEILING MOUNTED OCCUPANCY SENSOR

D = DUAL TECHNOLOGY U = ULTRASONIC, 360 DEG RANGE H = ULTRASONIC, HALLWAY PATTERN v (LOWERCASE) = VACANCY CONTROL DESIGNATION WALL MOUNTED OCCUPANCY SENSOR

P = PASSIVE INFRARED D = DUAL TECHNOLOGY v (LOWERCASE) = VACANCY CONTROL DESIGNATION WALL MOUNTED OCCUPANCY SENSOR/SWITCH

S = PASSIVE INFRARED WITH INTEGRAL "OFF" SWITCH T = DUAL RELAY PASSIVE INFRARED WITH TWO INTEGRAL "OFF" SWITCHES D = PASSIVE INFRARED WITH INTEGRAL DIMMER TO OFF.

v (LOWERCASE) = VACANCY CONTROL DESIGNATION MULTIPLE CHANNEL SURFACE METAL RECEPTACLE RACEWAY WITH LOW VOLTAGE DIVIDERS, LENGTH AND

RECEPTACLES AS INDICATED PHOTO ELECTRIC SWITCH D = CONTINUOUS DIMMING PHOTOCELL S = SWITCHED PHOTOCELL

SINGLE POLE SWITCH 2 = DOUBLE POLE SWITCH 3 = THREE-WAY SWITCH 4 = FOUR-WAY SWITCH a THRU z (LOWERCASE) = LUMINAIRE CONTROL DESIGNATION D = DIMMER F = FAN SPEED CONTROL

K = KEY OPERATED SWITCH L = LIGHTED HANDLE M = MANUAL MOTOR STARTER WITH THERMAL OVERLOAD P = SWITCH WITH PILOT LIGHT

S = SENTRY SWITCH T = INTERVAL TIMER W = WEATHERPROOF SWITCH V = LOW VOLTAGE SWITCH

SHEET INDEX

E000 SYMBOL LIST AND GENERAL NOTES - ELECTRICAL E001 LUMINAIRE SCHEDULE - LIGHTING

E201 LEVEL 1 DEMOLITION PLAN - LIGHTING

E202 LEVEL 1 DEMOLITION PLAN - POWER

E301 LEVEL 1 CEILING PLAN - LIGHTING

E401 LEVEL 1 FLOOR PLAN - POWER E451 LEVEL 1 ENLARGED PLAN - CHILDREN'S LIBRARY - POWER E452 LEVEL 1 ENLARGED PLAN - NON-FICTION - POWER

E501 SINGLE LINE DIAGRAMS - ELECTRICAL

E601 SCHEDULES - ELECTRICAL

E701 DETAILS - ELECTRICAL

GENERAL ELECTRICAL NOTES

A. ALL ELECTRICAL MATERIAL AND INSTALLATIONS SHOWN AND/OR SPECIFIED TO BE INSTALLED PER THE MANUFACTURER'S RECOMMENDATIONS AND IN ACCORDANCE WITH THE LATEST EDITION OF THE NEC 2023.

B. REFER TO ARCHITECTURAL DRAWINGS TO COORDINATE LOCATION AND MOUNTING HEIGHT OF ALL ELECTRICAL DEVICES.

C. REFER TO MECHANICAL AND PLUMBING DRAWINGS FOR EXACT LOCATION OF ALL

D. MAXIMUM VOLTAGE DROP OF BRANCH CIRCUITS TO BE 3%. ELECTRICAL CONTRACTOR TO SIZE WIRING TO SUIT.

E. NO WIRE SMALLER THAN #12 AWG SHALL BE USED FOR BRANCH CIRCUIT WIRING.

F. IN FINISHED INTERIOR AREAS RUN ALL CONDUITS CONCEALED UNLESS OTHERWISE NOTED, PAINT ALL EXPOSED CONDUITS AND ELECTRICAL EQUIPMENT, REFER TO ARCHITECTURAL PAINTING SPECIFICATIONS FOR REQUIREMENTS.

G. ALL EXPOSED CONDUIT TO BE RUN PARALLEL TO BUILDING LINES.

MECHANICAL AND PLUMBING EQUIPMENT.

H. PROVIDE DEDICATED NEUTRALS FOR ALL BRANCH CIRCUITS UNLESS OTHERWISE

I. ALL IN-SLAB OR BURIED CONDUIT TO BE COMPLETE WITH EQUIPMENT GROUNDING

J. ALL EMPTY CONDUITS TO BE COMPLETE WITH PULL WIRE.

K. MC CABLE SHALL NOT BE USED WITHOUT PERMISSION FROM THE ENGINEER.

L. ALL CONDUIT ROUTED IN AREAS SUBJECT TO MECHANICAL DAMAGE TO BE RIGID.

GENERAL LIGHTING NOTES

A. COORDINATE LIGHTING WITH ARCHITECTURAL DRAWINGS PRIOR TO ORDERING TO CONFIRM LUMINAIRES WILL FIT IN INTENDED ARCHITECTURAL FEATURES, CEILING GRIDS, COVES, ETC.

B. COORDINATE LIGHTING INSTALLATION REQUIREMENTS WITH SPRINKLER CONTRACTOR PRIOR TO SPRINKLER LINE INSTALLATION.

C. ALL LIGHT SWITCHES, DIMMERS AND MOTION SENSORS TO CONTROL LIGHTING WITHIN THE ROOM THEY ARE LOCATED IN UNLESS OTHERWISE NOTED.

D. ALL ROOM WALL SWITCHES, DIMMERS AND MOTION SENSORS TO BE SUBORDINATE TO THE LOW VOLTAGE SWITCHING ZONE THEY ARE LOCATED IN.

E. ALL PHOTOCELLS TO CONTROL THE LUMINAIRES WITHIN DAYLIGHT ZONE THEY ARE LOCATED WITHIN.

F. ALL MOTION SENSORS TO BE MOUNTED AT LEAST 3' AWAY FROM MECHANICAL DIFFUSERS.

GENERAL POWER NOTES

A. USE #10 AWG FOR 20A, 120V CIRCUITS LONGER THAN 70'.

B. USE #8 AWG FOR 20A, 120V CIRCUITS LONGER THAN 100'.

C. ALL RECEPTACLES IN COMMON AREAS ARE TO BE TAMPER-RESISTANT AS PER NEC

GENERAL DEMOLITION NOTES

A. ALL UNUSED CONDUIT, LOOSE CABLE, WIRE, HANGERS, ETC., SHALL BE REMOVED FROM THE CEILING SPACE. THE INTENT IS TO KEEP THE CEILING SPACE CLEAN.

B. THE CONTRACTOR SHALL RECORD AS-BUILT INFORMATION SHOWING EXISTING JUNCTION BOXES, CONDUIT ROUTES AND CIRCUIT NUMBERS AND ALL OTHER ELECTRICAL EQUIPMENT NOT REMOVED.

C. THE CONTRACTOR SHALL TURN OVER EQUIPMENT BEING REMOVED TO THE OWNER. EQUIPMENT NOT REQUIRED BY BUILDING MANAGEMENT SHALL BE REMOVED FROM SITE BY THE CONTRACTOR.

D. ALL SUPPLEMENTARY ELECTRICAL, POWER CONDUIT AND WIRE RISERS AND COMMUNICATIONS CONDUIT AND CABLING RISERS BETWEEN FLOORS NOT REQUIRED SHALL BE REMOVED.

E. THE CONTRACTOR SHALL SEAL ALL UNUSED OPENINGS DUE TO ELECTRICAL DEMOLITION TO ENSURE THAT FIRE-RESISTANCE IS MAINTAINED. FIRE STOPPING CAULKING PRODUCT SHALL BE NUCO INC. TYPE GG-200 SELF SEALANT.

F. PROVIDE AND INSTALL BLANK COVERPLATES FOR DEVICES SHOWN TO BE

G. SWITCHES ON WALLS BEING DEMOLISHED SHALL BE REMOVED.

H. ALL EXISTING LUMINARES LOCATED IN DEMOLISHED CEILINGS ARE TO BE REMOVED. REMOVE ALL ASSOCIATED CONTROLS SUCH AS SLAVE AND DIMMER SWITCHES.

I. EXISTING LIGHTING CIRCUITS ARE TO BE BROUGHT BACK TO THE PANEL BOARD.

J. UNUSED CONDUIT AND WIRE IS TO BE REMOVED.

K. ALLOW FOR SOME TEMPORARY BASE BUILDING LIGHTS.

L. EXISTING DISTRIBUTION EQUIPMENT INCLUDING PANELS, TRANSFORMERS, DISCONNECT SWITCHES, SPLITTERS, ETC., LOCATED IN AREAS UNDER CONSTRUCTION ARE TO REMAIN.

M. POWER CONNECTIONS AND OUTLETS ARE TO BE REMOVED FROM WALLS TO BE DEMOLISHED.

N. ALL CIRCUITS ORIGINATING FROM THE PANEL BOARDS AND AFFECTED BY DEMOLITION SHALL BE REMOVED BACK TO THE POINT OF ORIGIN.


COORDINATE WITH THE OWNER PRIOR TO THE COMMENCEMENT OF THE WORK.

P. ENSURE THAT BASE BUILDING WIRING SUCH AS CONTROL-WIRING, ETC. IS NOT DAMAGED.

INTERFACE ENGINEERING

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SYMBOL LIST AND

GENERAL NOTES -

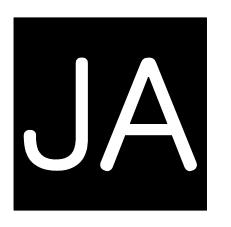ELECTRICAL

SHEET TITLE

					LUMINA	IRE S	CHED	ULE -	INTERIC	DR								
						UL/IP	DRIVER	DIMMING	INITIAL DELIVERED			RATED				MANUFACTURE	<u> </u>	
TYPE	DESCRIPTION	HOUSING	OPTICS	MOUNTING	FINISH	RATING	LOCATION	CONTROL	LUMENS	CCT	CRI	LIFE	LM/W	WATTAGE	VOLTAGE	R	PRE-APPROVED PRODUCTS	REMARKS
'D' RECESSE DIMENSIO	ED LED DOWNLIGHT; 3.75" DIA x 4.5" H NOMINAL DNS	ALUMINUM	CLEAR POLYCARBONATE	RECESSED; CONFIRM CEILING TYPE PRIOR TO ORDER; REFER TO ARCHITECTURAL DRAWINGS FOR DIMENSIONED LOCATIONS	WHITE	DAMP	INTEGRAL	0-10V; 1%	1300	3000K	95	225,000 (L70)	135	11.0	120	LUMENPULSE LUMENCORE	LCRS-EZ-A-FD-120-R-L13-35K-95-WFR-DA1-SB-MWH-R D-MWH-RM-1-NA	
'D-EM' RECESSE DIMENSIO	ED LED DOWNLIGHT; 3.75" DIA x 4.5" H NOMINAL DNS	ALUMINUM	CLEAR POLYCARBONATE	RECESSED; CONFIRM CEILING TYPE PRIOR TO ORDER; REFER TO ARCHITECTURAL DRAWINGS FOR DIMENSIONED LOCATIONS	WHITE	DAMP	INTEGRAL	0-10V; 1%	1300	3000K	95	225,000 (L70)	135	11.0	120	LUMENPULSE LUMENCORE	LCRS-EZ-A-FD-120-R-L13-35K-95-WFR-DA1-SB-MWH-R D-MWH-RM-1-EBB-NA	
TOTAL SU	OUNTED FIBER OPTIC STAR FIELD INSTALLATION; JRFACE AREA OF RE INSTALLATION 4'-2" W x 10' H	FIBER OPTIC CABLE	N/A	MOUNTED TO WALL, SEE ARCHITECTURAL DETAILS	N/A	DRY	REMOTE	N/A	N/A	3000K	90	N/A	N/A	42.0	120	VLT	GALAXY SERIES	
	OUNTED LED VANITY LUMINAIRE; 7" DIA x 4" D DIMENSIONS	ALUMINUM	OPAL GLASS	WALL MOUNTED AT 5'-0" A.F.F. CONFIRM FINAL MOUNTING HEIGHT WITH ARCHITECTURAL PRIOR TO INSTALLATION.	VERMILION	IP65	REMOTE	0-10V; 1%	430	3000K	90	50,000 HOURS	57.5	7.5	120	RBW	DPC42301_10V_UNVIP20	
	LED HEX LUMINAIRE; 27.3125" W x 28.625" L x MINAL DIMENSIONS	ALUMINUM	OPAL LENS	SURFACE	WHITE	DAMP	INTEGRAL	0-10V; 1%	5000	3000K	90	N/A	96	53.0	120	BASO HEX	HEX-SUR-WH-OP-35K-C90-UNV-010V-05000L-DM-2FT	
	E ACOUSTIC HEX PANEL; 27.3125" W x 28.625" L x MINAL DIMENSIONS	ALUMINUM	N/A	SURFACE	WHITE; ARCH TO CONFIRM ACOUSTIC PANEL FINISH	N/A	N/A	N/A	N/A	N/A	N/A	N/A	N/A	0.0	120	BASO HEX	HEX-ACO-LI-SUR-WH-TBD-DM-2FT	
	DED ACOUSTIC DOWNLIGHT LED LUMINAIRE; 2"H NOMINAL DIMENSIONS	>60% RECYCLED PET	EXTRUDED ACRYLIC LENS	SUSPENDED SUCH THAT THE BOTTOM OF THE FIXTURE IS 8'-0" A.F.F.	TBD	DAMP	INTEGRAL	0-10V; 1%	1971	3000K	90	60,000 (L70)	82.1	24.5	120	SABIN DISC	LYR-D-L-DL-35"-D2000-DGA-TBD-935K-SC-10-UNV-15TB D-PCTBD-ACTBD-TBD	
	DED ACOUSTIC DOWNLIGHT LED LUMINAIRE; 31"L 2"H NOMINAL DIMENSIONS	>60% RECYCLED PET	EXTRUDED ACRYLIC LENS	SUSPENDED SUCH THAT THE BOTTOM OF THE FIXTURE IS 8'-0" A.F.F.	TBD	DAMP	INTEGRAL	0-10V; 1%	1971	3000K	90	60,000 (L70)	82.1	24.5	120	SABIN OBROUND	LYR-O-L-DL-31" X 15"-D2000-DGA-TBD-CEN-935K-SC-10-UNV-15TBD-PCT BD-ACTBD-TBD	
	DED ACOUSTIC DOWNLIGHT LED LUMINAIRE; 2"H NOMINAL DIMENSIONS	>60% RECYCLED PET	EXTRUDED ACRYLIC LENS	SUSPENDED SUCH THAT THE BOTTOM OF THE FIXTURE IS 8'-0" A.F.F.	TBD	DAMP	INTEGRAL	0-10V; 1%	1971	3000K	90	60,000 (L70)	82.1	24.5	120	SABIN DISC	LYR-D-L-DL-47"-D2000-DGA-TBD-935K-SC-10-UNV-15TB D-PCTBD-ACTBD-TBD	
	DED ACOUSTIC DOWNLIGHT LED LUMINAIRE; 63"L 2"H NOMINAL DIMENSIONS	>60% RECYCLED PET	EXTRUDED ACRYLIC LENS	SUSPENDED SUCH THAT THE BOTTOM OF THE FIXTURE IS 8'-0" A.F.F.	TBD	DAMP	INTEGRAL	0-10V; 1%	1971	3000K	90	60,000 (L70)	82.1	24.5	120	SABIN OBROUND	LYR-O-L-DL-63" X 23"-D2000-DGA-TBD-CEN-935K-SC-10-UNV-15TBD-PCT BD-ACTBD-TBD	

NOTES

- THIS LUMINAIRE SCHEDULE IS NOT COMPLETE WITHOUT A COPY OF THE PROJECT MANUAL CONTAINING THE ELECTRICAL SPECIFICATIONS.
- DIMMING CONTROL PROTOCOL (0-10VDC, LINE VOLTAGE, DALI, ETC.) COMPATIBLE WITH LIGHTING CONTROL SYSTEM AS SPECIFIED AND SHOWN ON DRAWINGS.
- PROVIDE +/- 12 INCH ADJUSTABILITY IN AIRCRAFT CABLE LENGTH WHERE USED.
- COORDINATE ALL CEILING TYPES WITH LUMINAIRE LOCATIONS PRIOR TO ORDERING LUMINAIRES. COORDINATE INSTALLATION WITH REFLECTED CEILING PLAN.
- SPECIFIED MANUFACTURERS ARE BASIS OF DESIGN. SUBMIT ALTERNATES FOR APPROVAL PRIOR TO BID CLOSE.
- PROVIDE SUBMITTALS THAT INCLUDE THE LUMINAIRE, LAMP AND DRIVER INFORMATION OF EACH LUMINAIRE, WITH APPLICABLE OPTIONS CLEARLY CHECKED OR HIGHLIGHTED. SUBMITTALS NOT INCLUDING THIS INFORMATION WILL BE RETURNED AS REJECTED BY THE ENGINEER OF RECORD.
- REMOTE BALLASTS/DRIVERS: UL LISTED FOR THEIR APPLICATION. BALLASTS/DRIVERS MARKED AS UL RECOGNIZED COMPONENT BUT NOT UL LISTED ARE SUBJECT TO REMOVAL AND REPLACEMENT AT NO COST TO OWNER.
- LABEL ALL REMOTE DRIVERS TO SHOW LUMINAIRE TYPE IDENTIFICATION AND SOURCE CIRCUIT. PROVIDE WIRING BETWEEN REMOTE DRIVER AND LUMINAIRE AS RECOMMENDED BY MANUFACTURER BETWEEN DRIVER AND FURTHEST LUMINAIRE.

	LED REPLACEMENT MATRIX: BASIS	OF DESIGN
LUMINAIRE TYPE LAMPS	LED REPLACEMENT BASIS OF DESIGN	EXISTING LAMPS TO BE REPLACED
FD26/FD26E 1	GREEN CREATIVE: 9PLO/8CCTS/HYB/PF	CFL 26W 4P OR 2P -GC Offers Pin Fit Technology
PH3 4	GREEN CREATIVE	26W DTT CFL

		LIGHTIN	IG CONTRO	JL WATRIX	: SPACE BY	SPACE		
ROOM NAME	OCC. SENSOR TYPE	LOCAL CONTROL	PHOTOCELL (Y/N)	PLUGLOAD CONTROL (Y/N)	UL 924 RELAY	NETWORKED (Y/N)	CONTROL FUNCTION	NOTES
DISCOVERY HALLWAY	CEILING MOUNTED DUAL TECHNOLOGY OCCUPANCY SENSOR	LOW VOLTAGE DIMMING SWITCHES	N	N	Υ	N	MANUAL ON WITH WALL DIMMER. INCORPORATE MANUAL DIMMING CONTROL TO OFF. AUTOMATIC CONTINUOUS DIMMING IN PRIMARY AND SECONDARY DAYLIGHT ZONES. AUTO OFF AFTER 10 MINUTES OF UNOCCUPANCY	
HOLDS	N/A	EXISTING LOCAL CONTROL	N	N	Y	N	EXISTING LIGHTING CONTROLS	<20% LIGHTING TO BE
EARLY LEARNING	CEILING MOUNTED DUAL TECHNOLOGY VACANCY SENSOR	LOW VOLTAGE DIMMING SWITCHES	N	N	Y	N	MANUAL ON, AUTO OFF WITHIN 10 MINUTES OF UNOCCUPANCY. INCORPORATE MANUAL DIMMING CONTROL TO OFF. AUTO DIMMING FOR DAYLIGHT ZONES	
INDIVIDUAL EXPLORATION	CEILING MOUNTED DUAL TECHNOLOGY VACANCY SENSOR	LOW VOLTAGE DIMMING SWITCHES	N	N	Y	N	MANUAL ON, AUTO OFF WITHIN 10 MINUTES OF UNOCCUPANCY. INCORPORATE MANUAL DIMMING CONTROL TO OFF. AUTO DIMMING FOR DAYLIGHT ZONES	
CHILDREN'S LIBRARY	N/A	EXISTING LOCAL CONTROL	N	N	Υ	N	EXISTING LIGHTING CONTROLS	C503.7.3 N/A
ALL OTHER ROOMS	CEILING MOUNTED DUAL TECHNOLOGY VACANCY SENSOR	LOW VOLTAGE DIMMING SWITCHES	N	N	Y	N	MANUAL ON, AUTO OFF WITHIN 10 MINUTES OF UNOCCUPANCY. INCORPORATE MANUAL DIMMING CONTROL TO OFF. WHEN BLDG ARMS, LIGHTS TURN OFF.	

- A. PROVIDE ALL COMPONENTS REQUIRED FOR A FULLY FUNCTION LIGHTING CONTROL SYSTEM TO MEET FUNCTIONALITY LISTED ABOVE.
- C. PROVIDE LOW VOLTAGE LIGHTING CONTROL, UNLESS OTHERWISE NOTED.
- LIGHTING SYSTEM TESTING: SCOPE OF WORK INCLUDES BOTH INITAL PROGRAMMING OF DEVICES BASED ON THIS SCHEDULE AND/OR SPECIFICATIONS, TESTING OF CONTROLS, AND ADJUSTING OF PROGRAMMED SETTINGS TO OCCUR AFTER FURNITURE AND FINAL FINISHES HAVE BEEN INSTALLED.
- E. COORDINATE PHOTOSENSOR RATINGS AND MOUNTING HEIGHTS. SENSORS SHALL BE CAPABLE OF DETECTING DESIGNED FOOT-CANDLE LEVELS PER IESNA RECOMMENDATIONS.
- F. COORDINATE FINAL TIME AND LIGHT LEVEL SETTINGS WITH OWNER.
- G. PROVIDE DIMMING CONTROLS FOR ALL SPACES OVER 100 SQUARE FEET.
- H. LUMINAIRES WITHIN DESIGNATED DAYLIGHT HARVESTING ZONES SHALL BE DIMMED BY AT LEAST 65% WHEN DAYLIGHT SENSORS READ AT LEAST 150% OF DESIGN ILLUMINANCE.
- I. FOR ALL SPACES WITH DAYLIGHT HARVESTING, DIMMING CONTROLS, ILLUMINATION DURING NIGHT TIME SHALL BE ADJUSTED TO BE GREATER THAN OR EQUAL TO 20% LOWER THAN THE DAYTIME LIGHT LEVEL DESIGN GUIDE FOOT-CANDLE LEVELS PER IESNA RECOMMENDATIONS.
- J. CONFIRM SCENE SETTINGS, TIMECLOCK CONTROLS, AND OPTIONS WITH OWNER PRIOR TO SUBMITTAL.
- K. LIGHTING CONTROLS TO COMPLY WITH WSEC 2021.
- M. IF FIRE ALARM OR INTRUSION ALARM OCCURS ALL LIGHTS OPERATE IN NORMAL FUNCTION.



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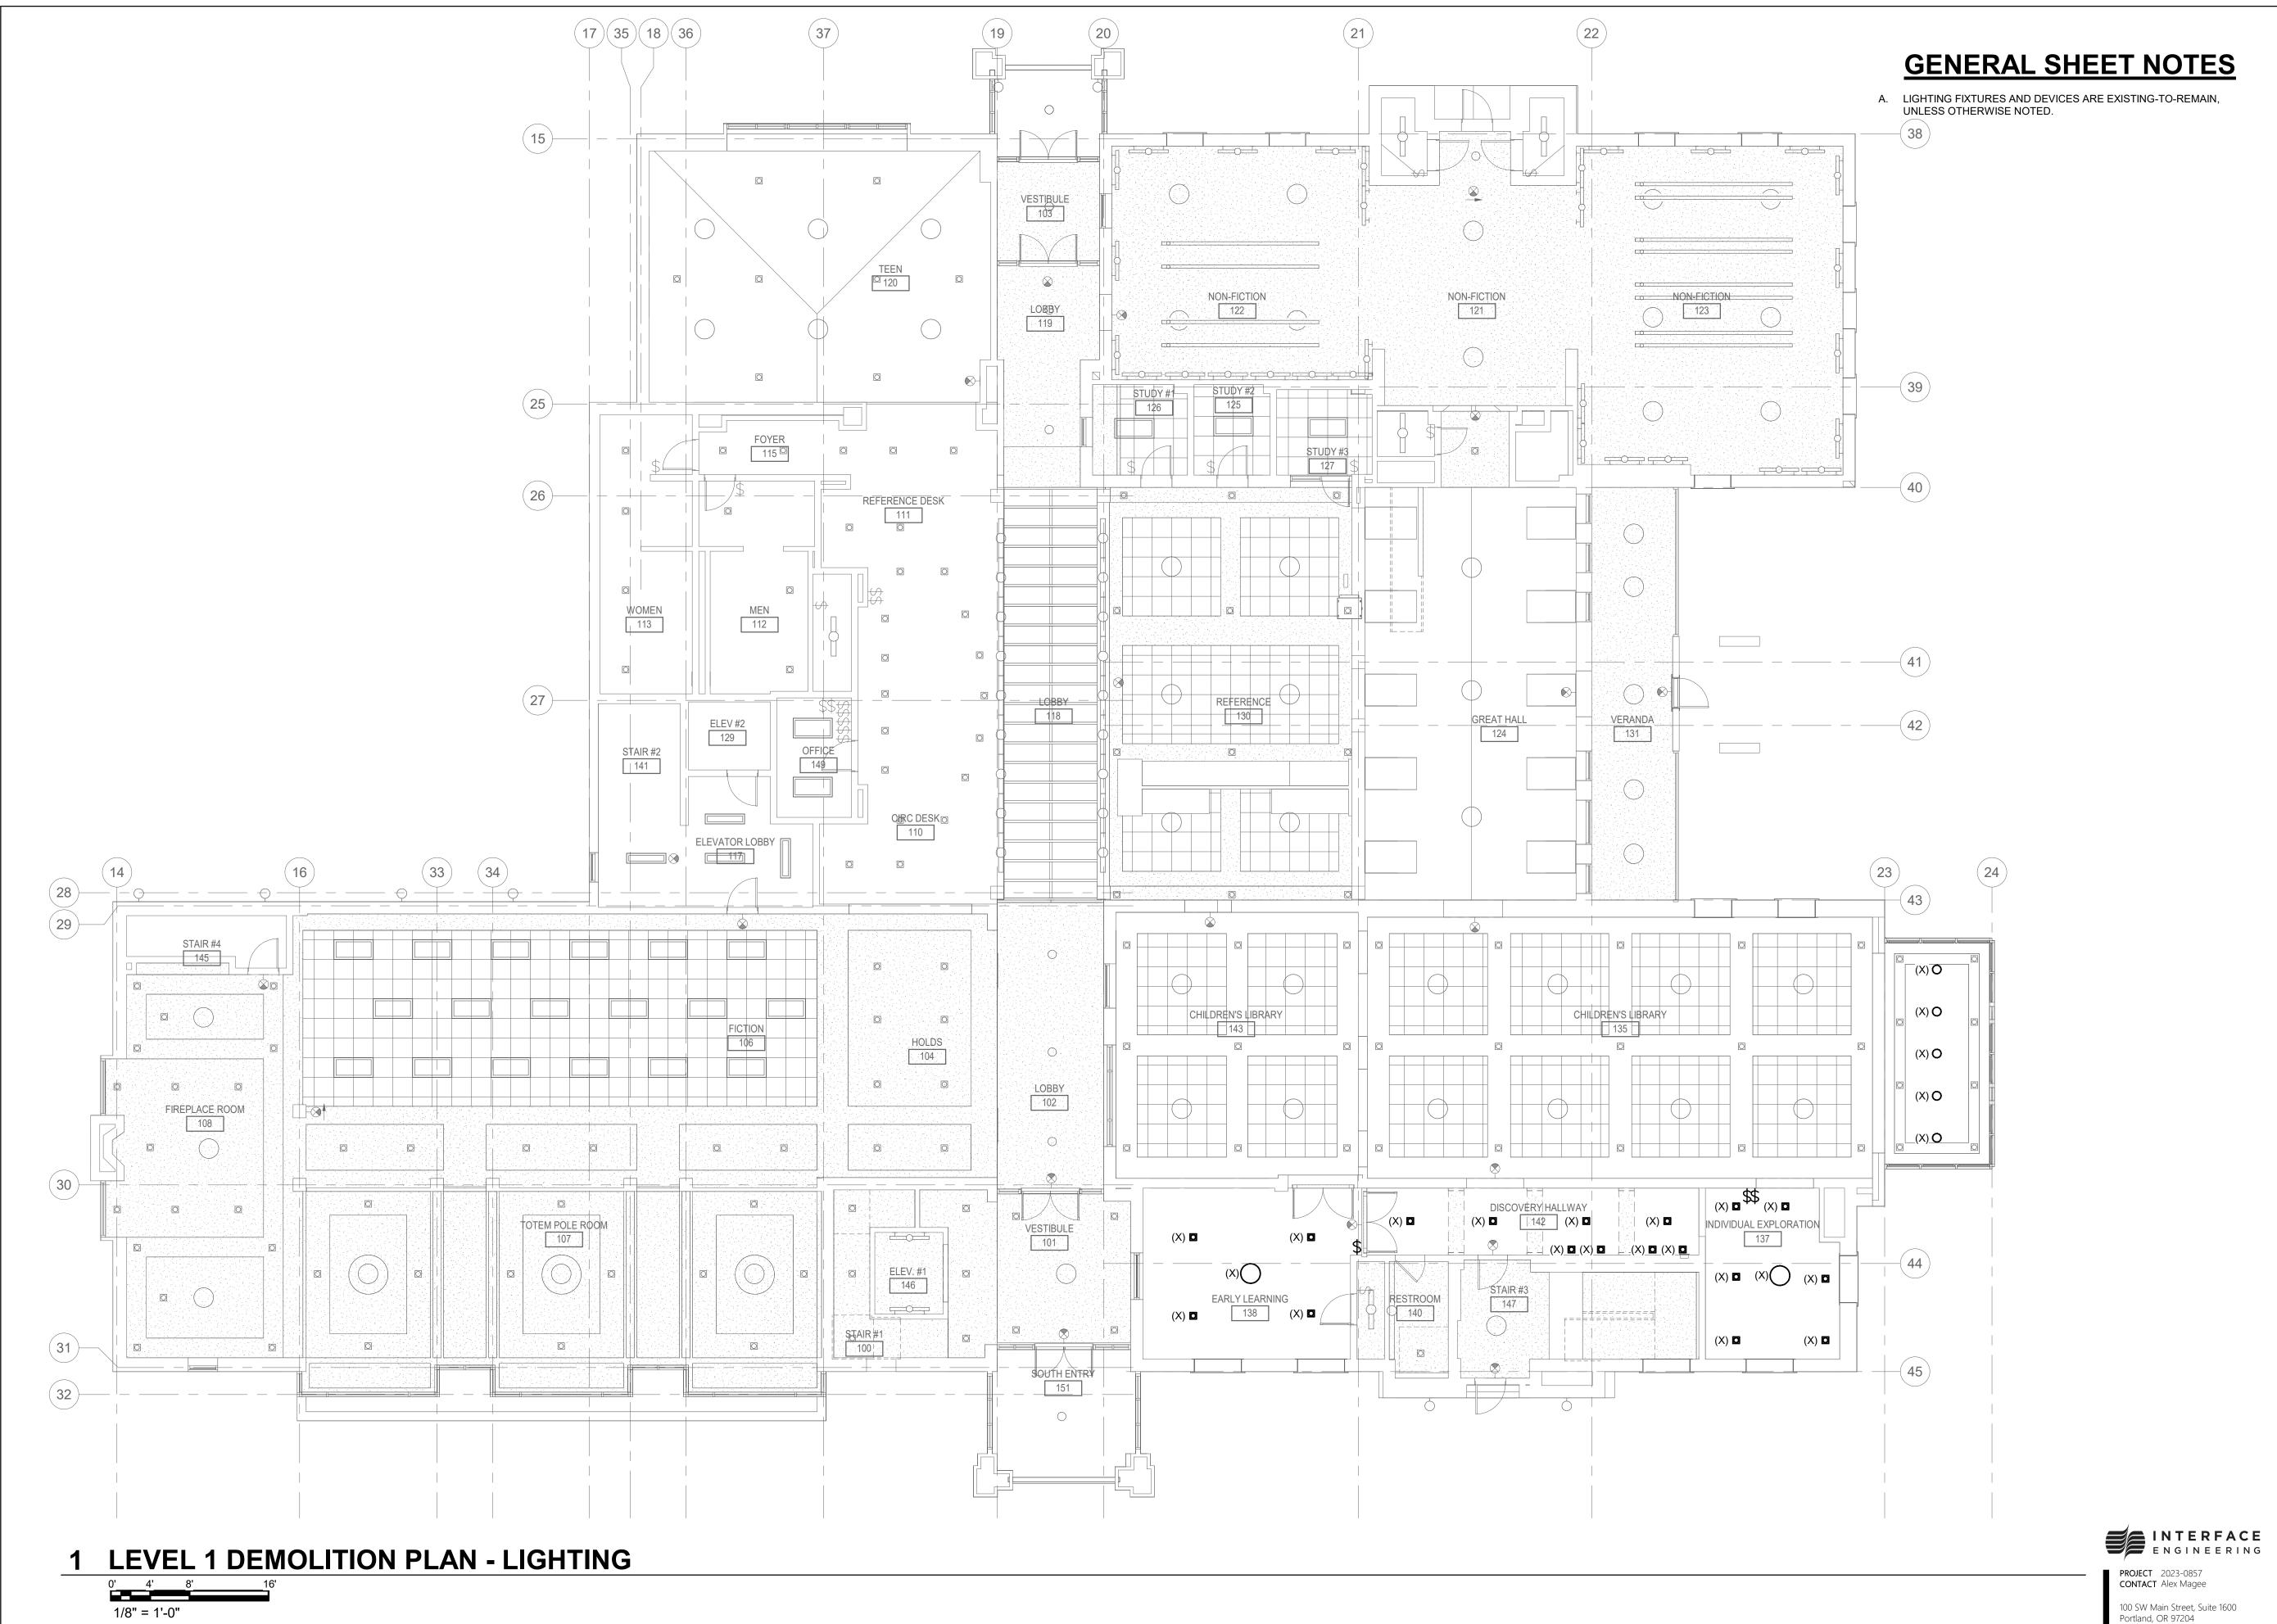
INTERFACE ENGINEERING

100 SW Main Street, Suite 1600

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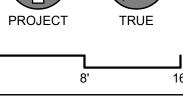
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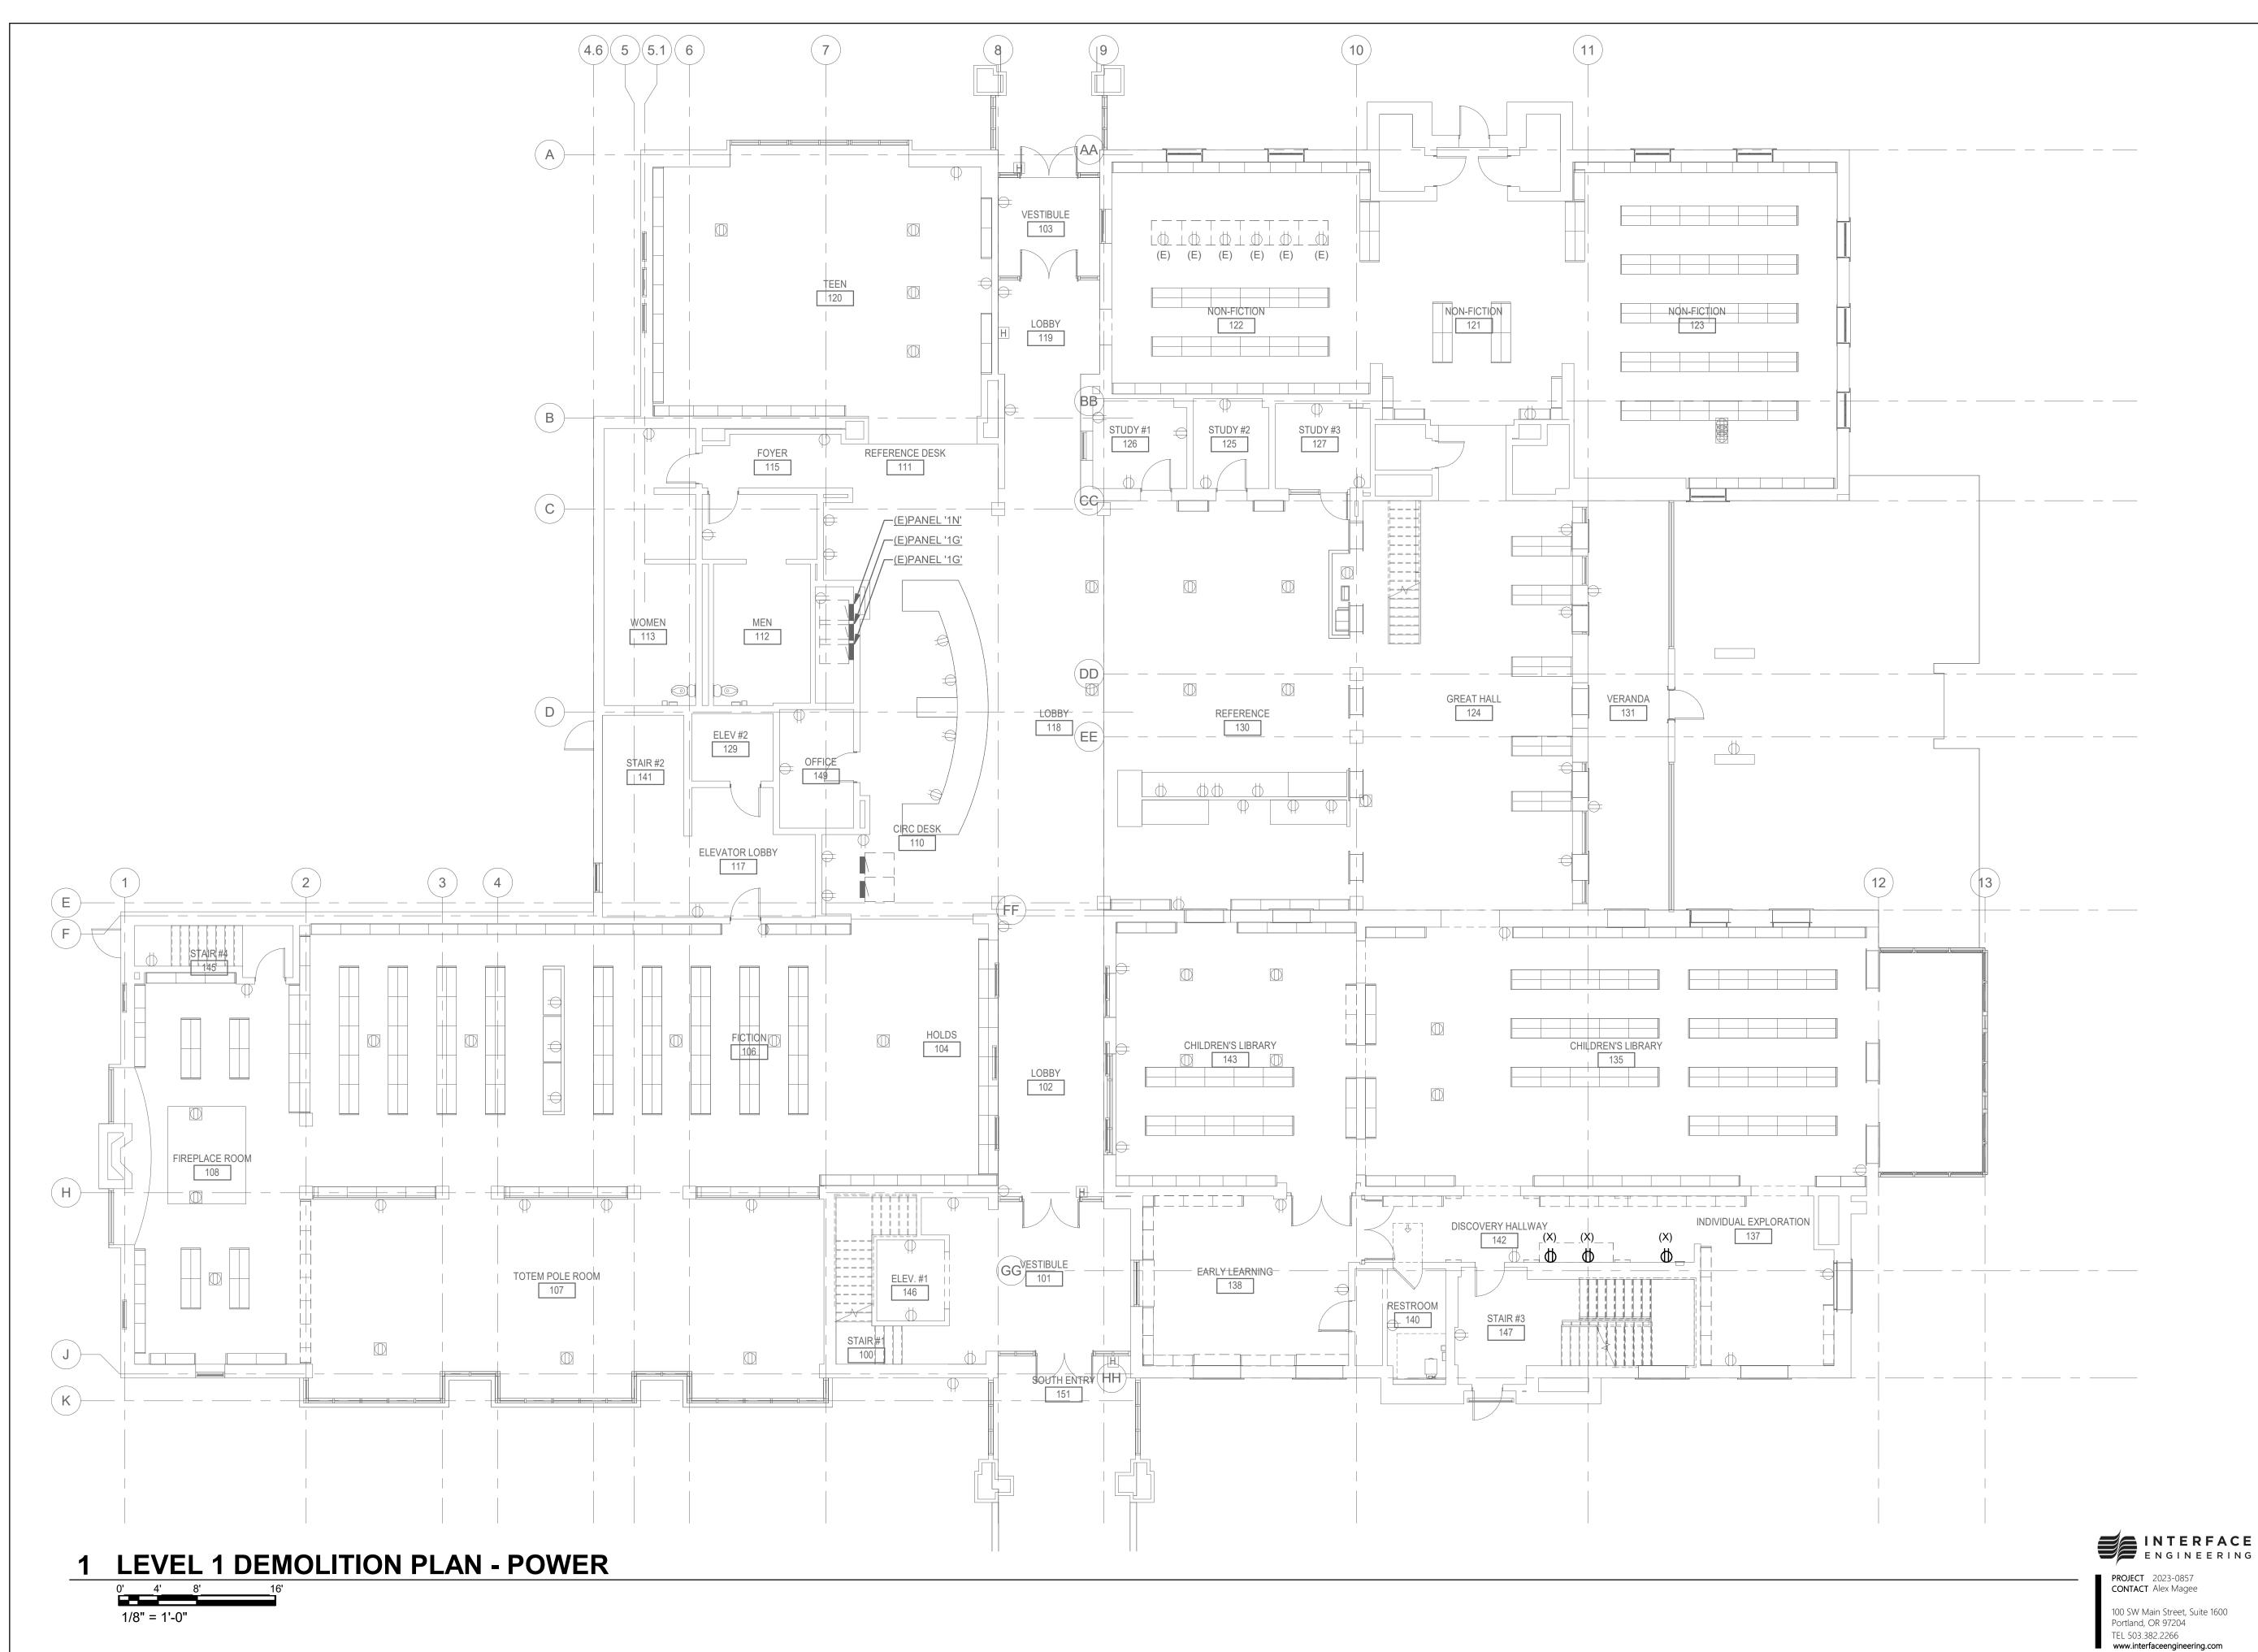
LEVEL 1
DEMOLITION PLAN
- LIGHTING


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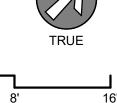
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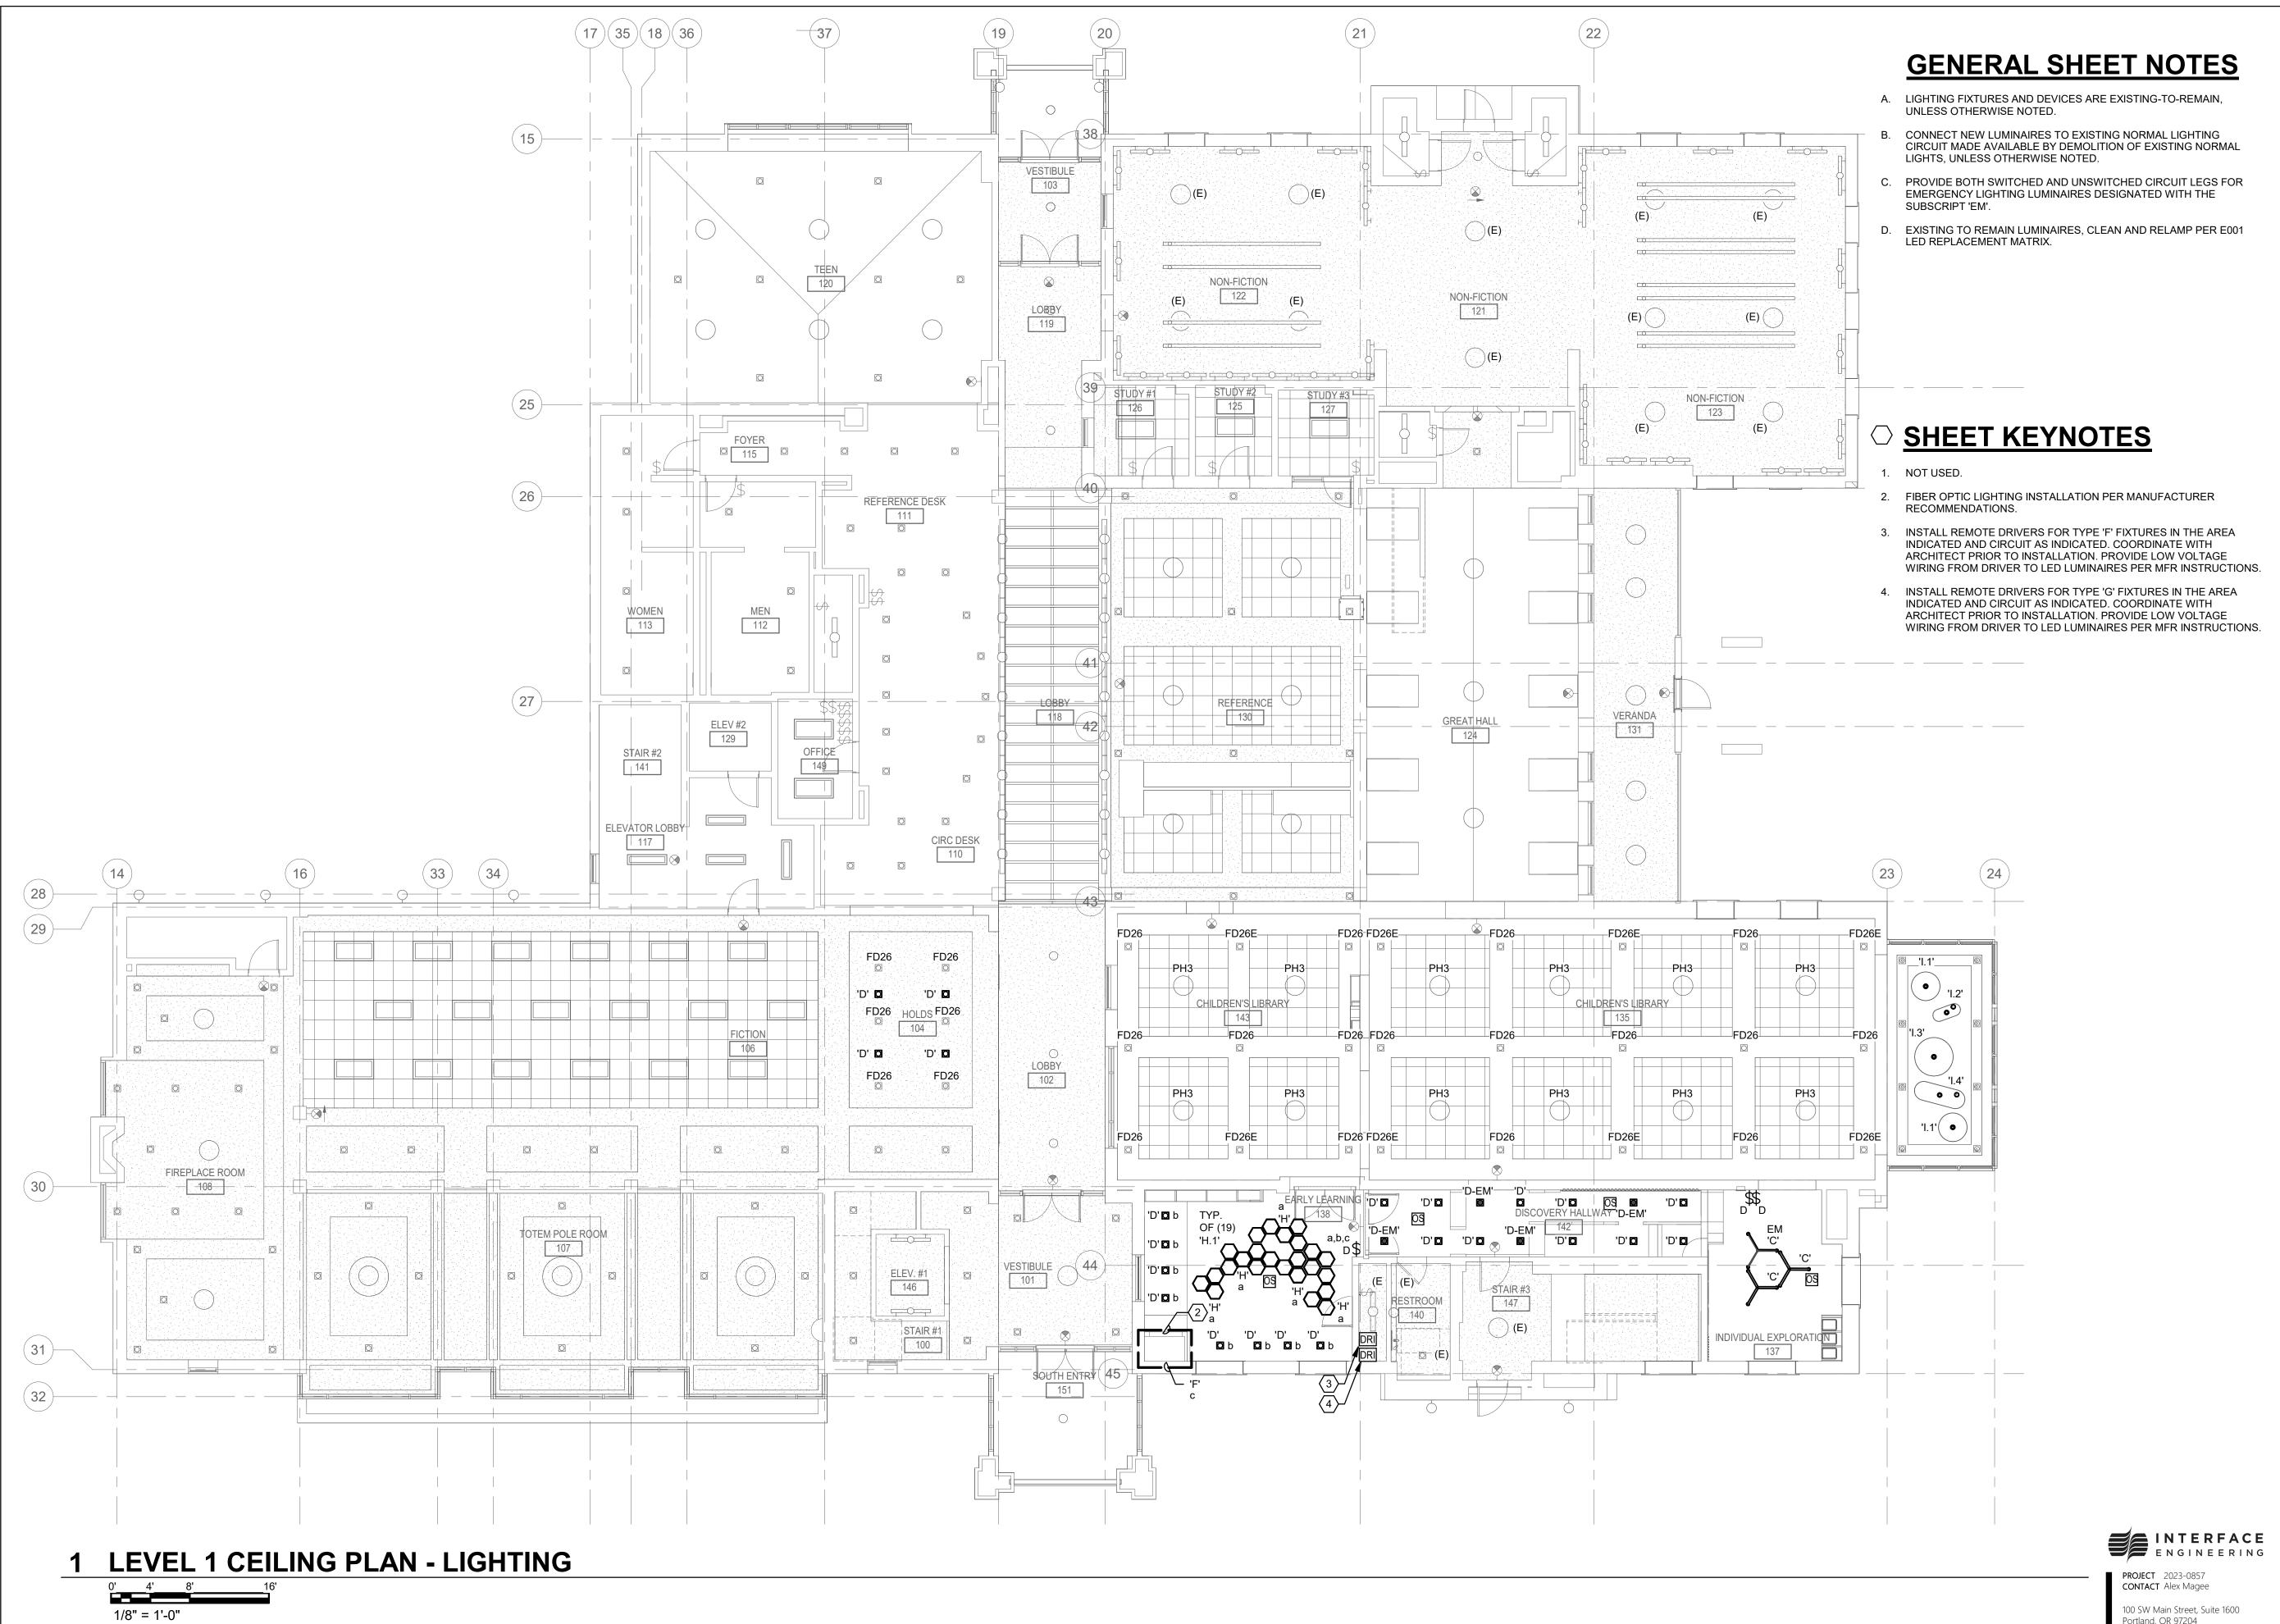
DEMOLITION PLAN

- POWER

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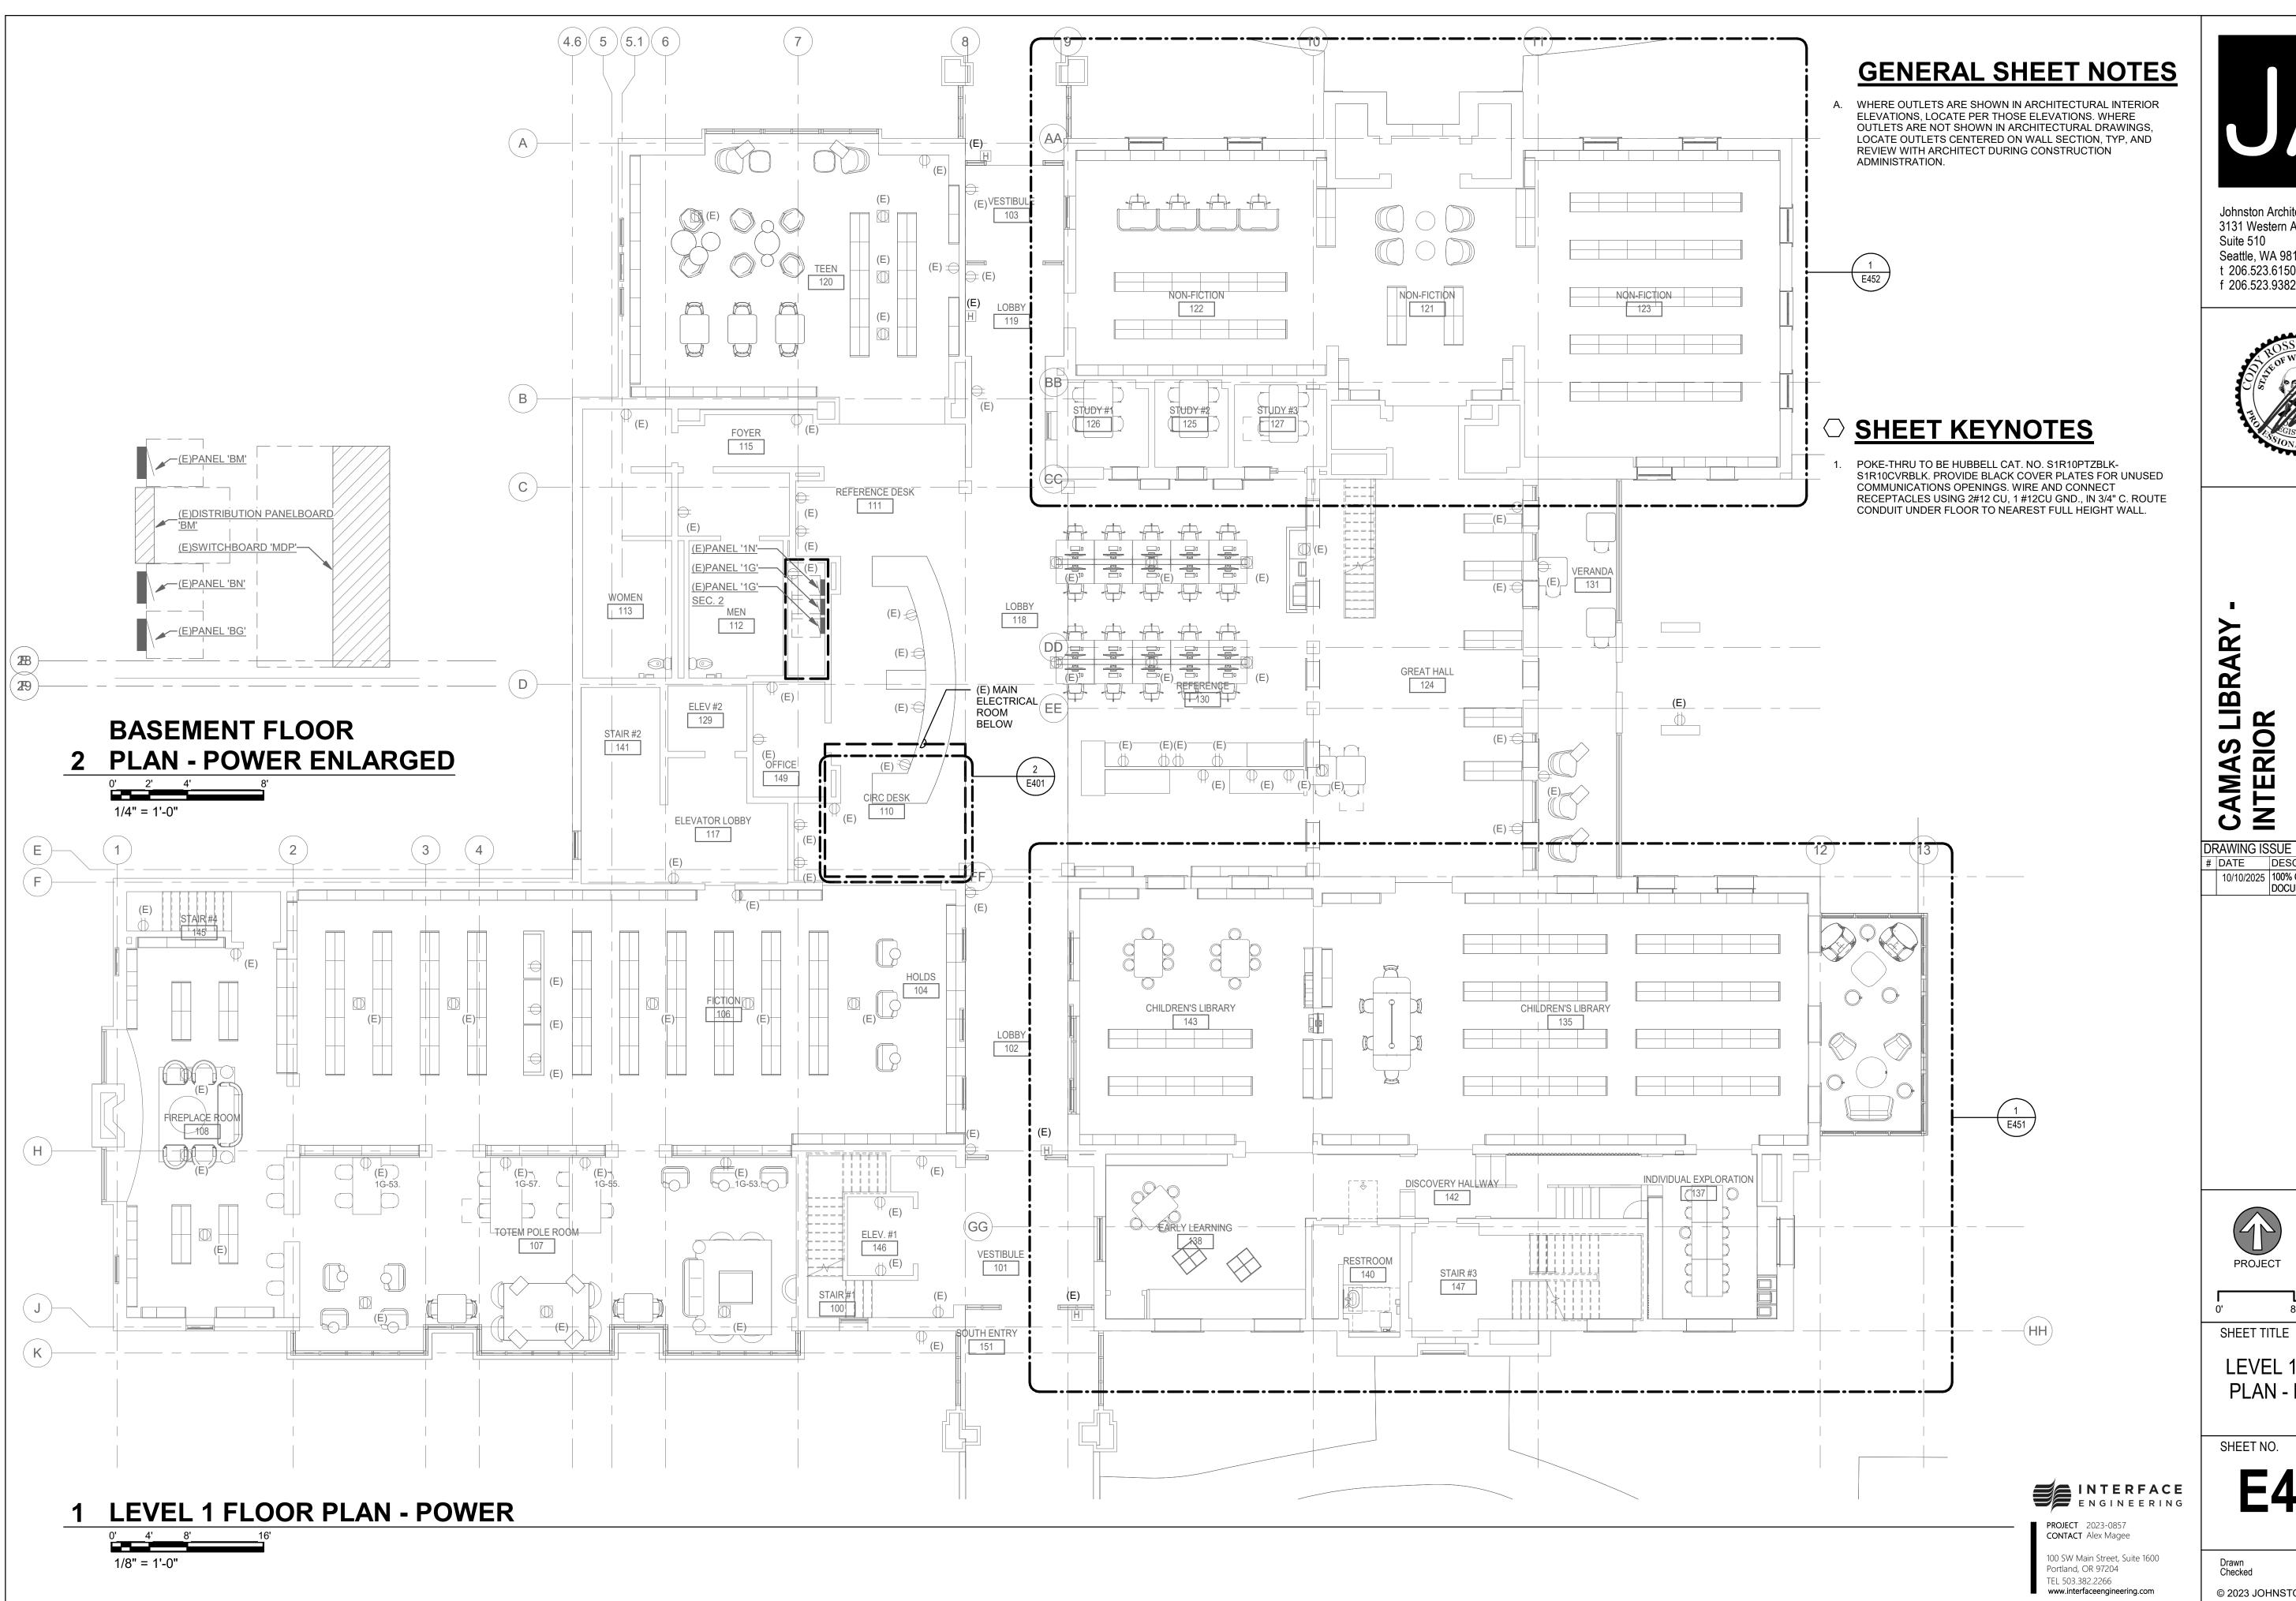
LEVEL 1 CEILING PLAN - LIGHTING

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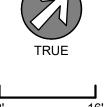


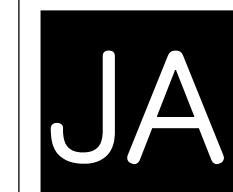

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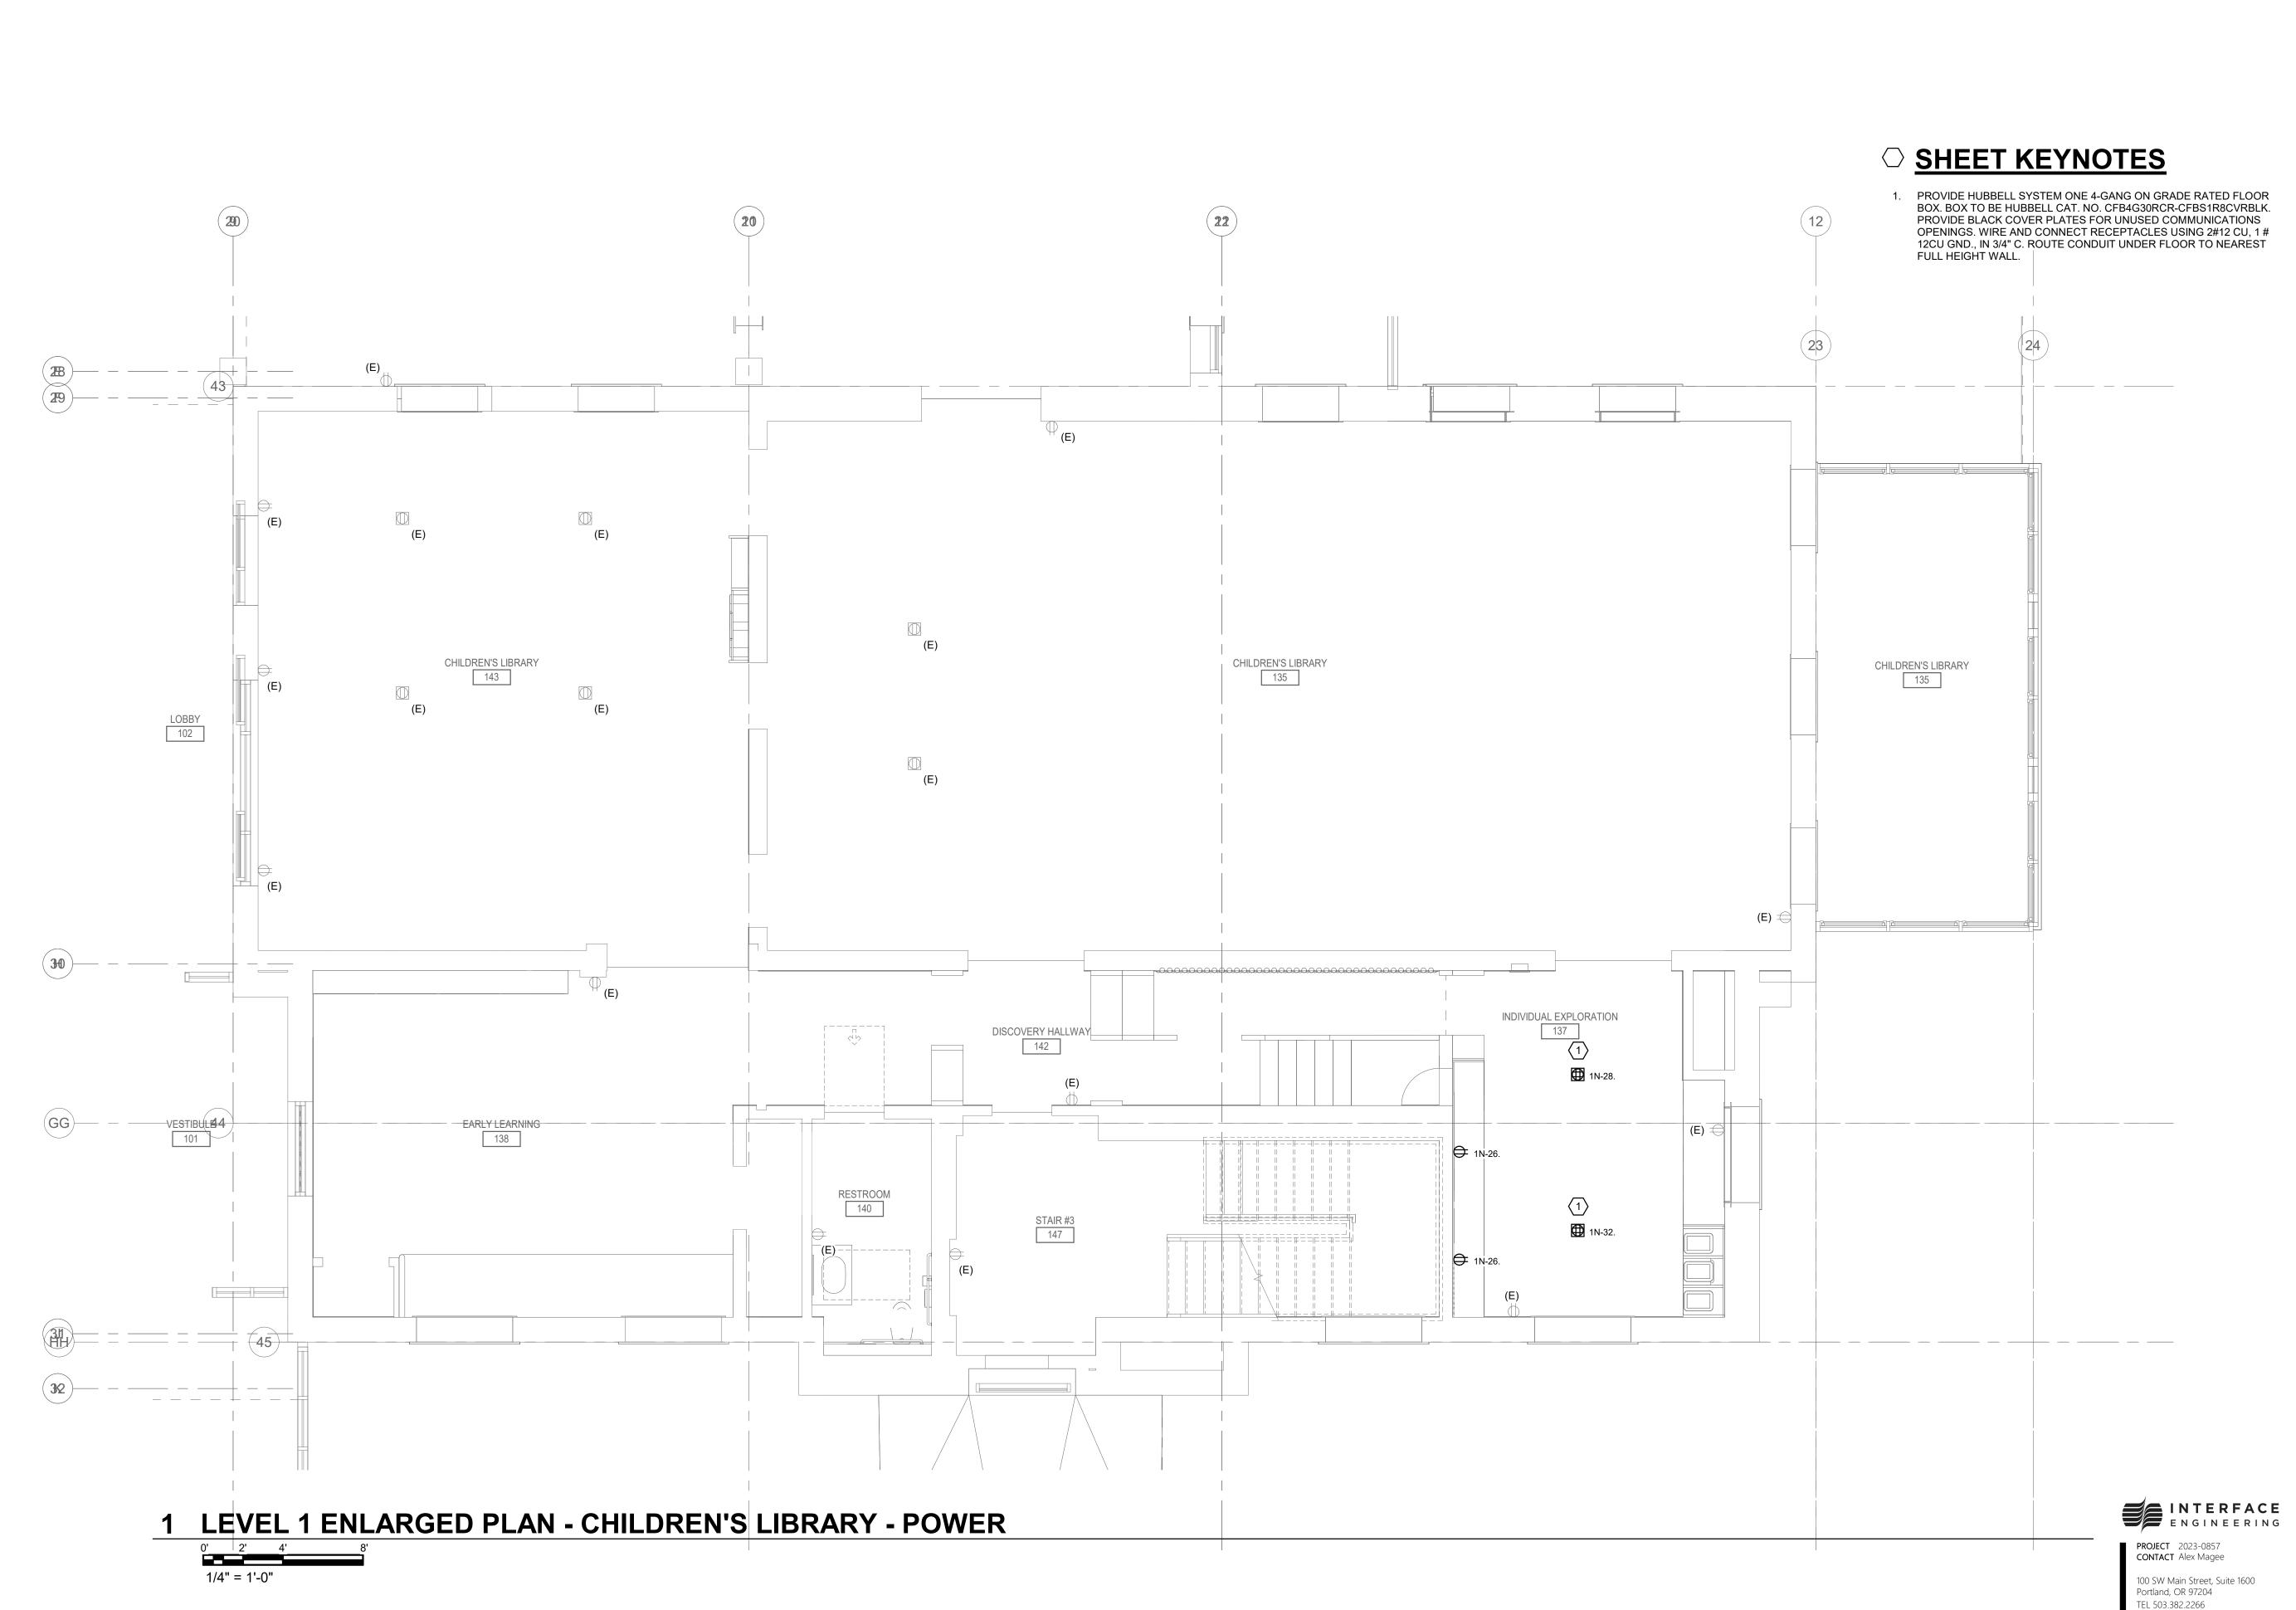
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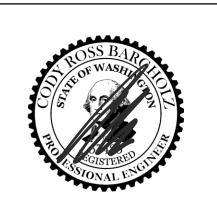
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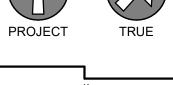


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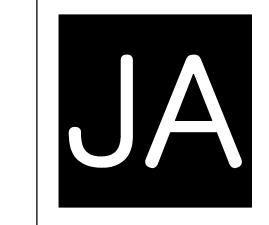
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ENLARGED PLAN CHILDREN'S
LIBRARY - POWER


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SHEET TITLE VEL 1 ENLARGED PLAN -NON-FICTION -POWER

SHEET NO.

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PROJECT 2023-0857 CONTACT Alex Magee


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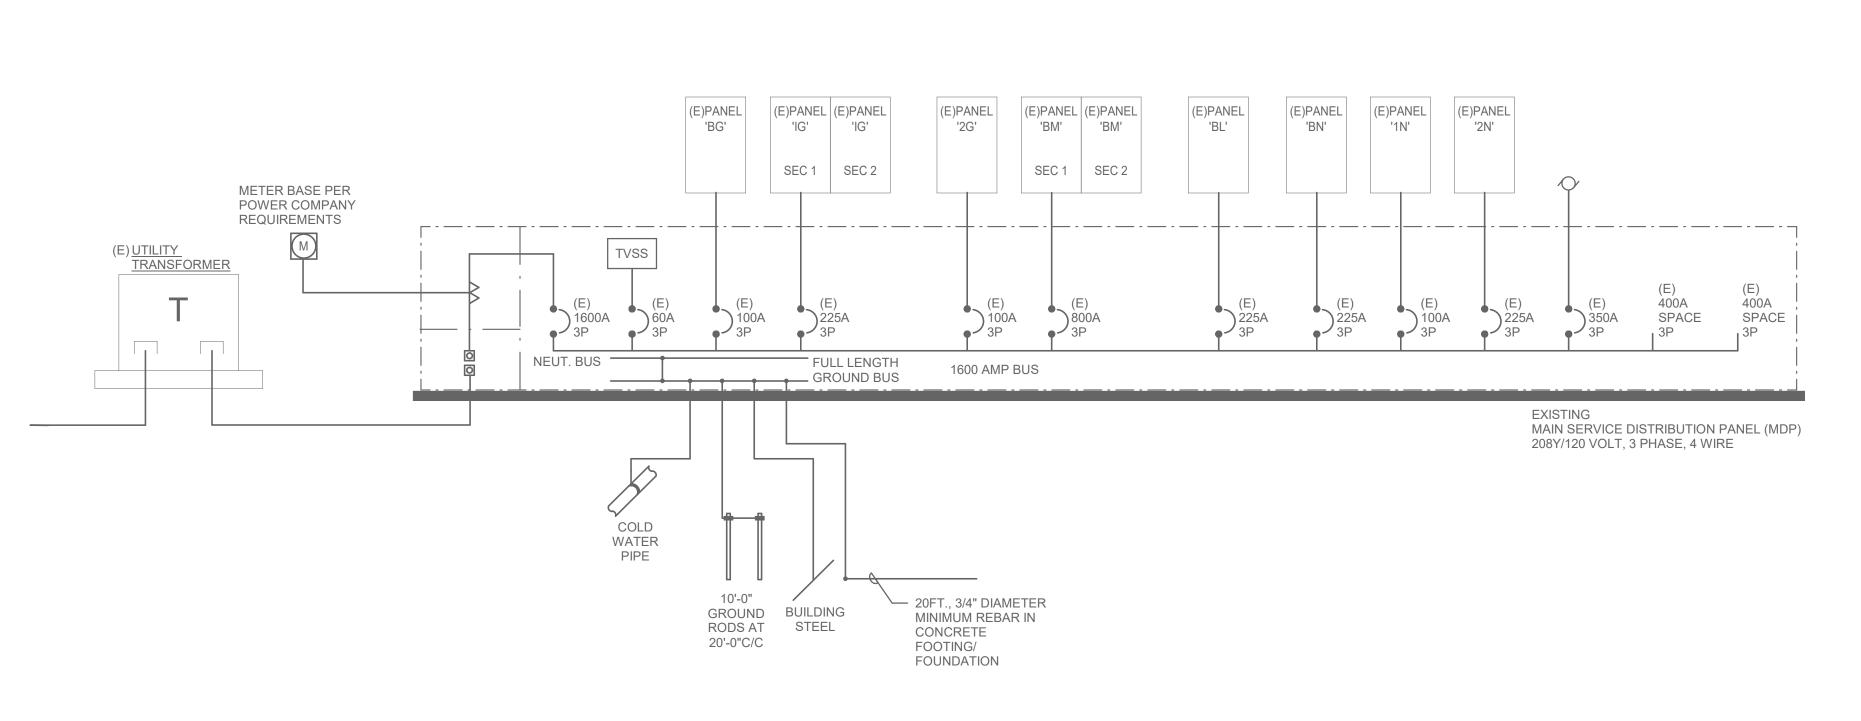
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1 EXISTING ONE LINE DIAGRAM - ELECTRICAL

NO SCALE

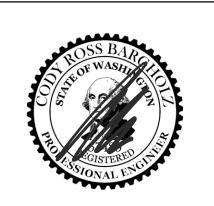

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SINGLE LINE
DIAGRAMS ELECTRICAL


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E501
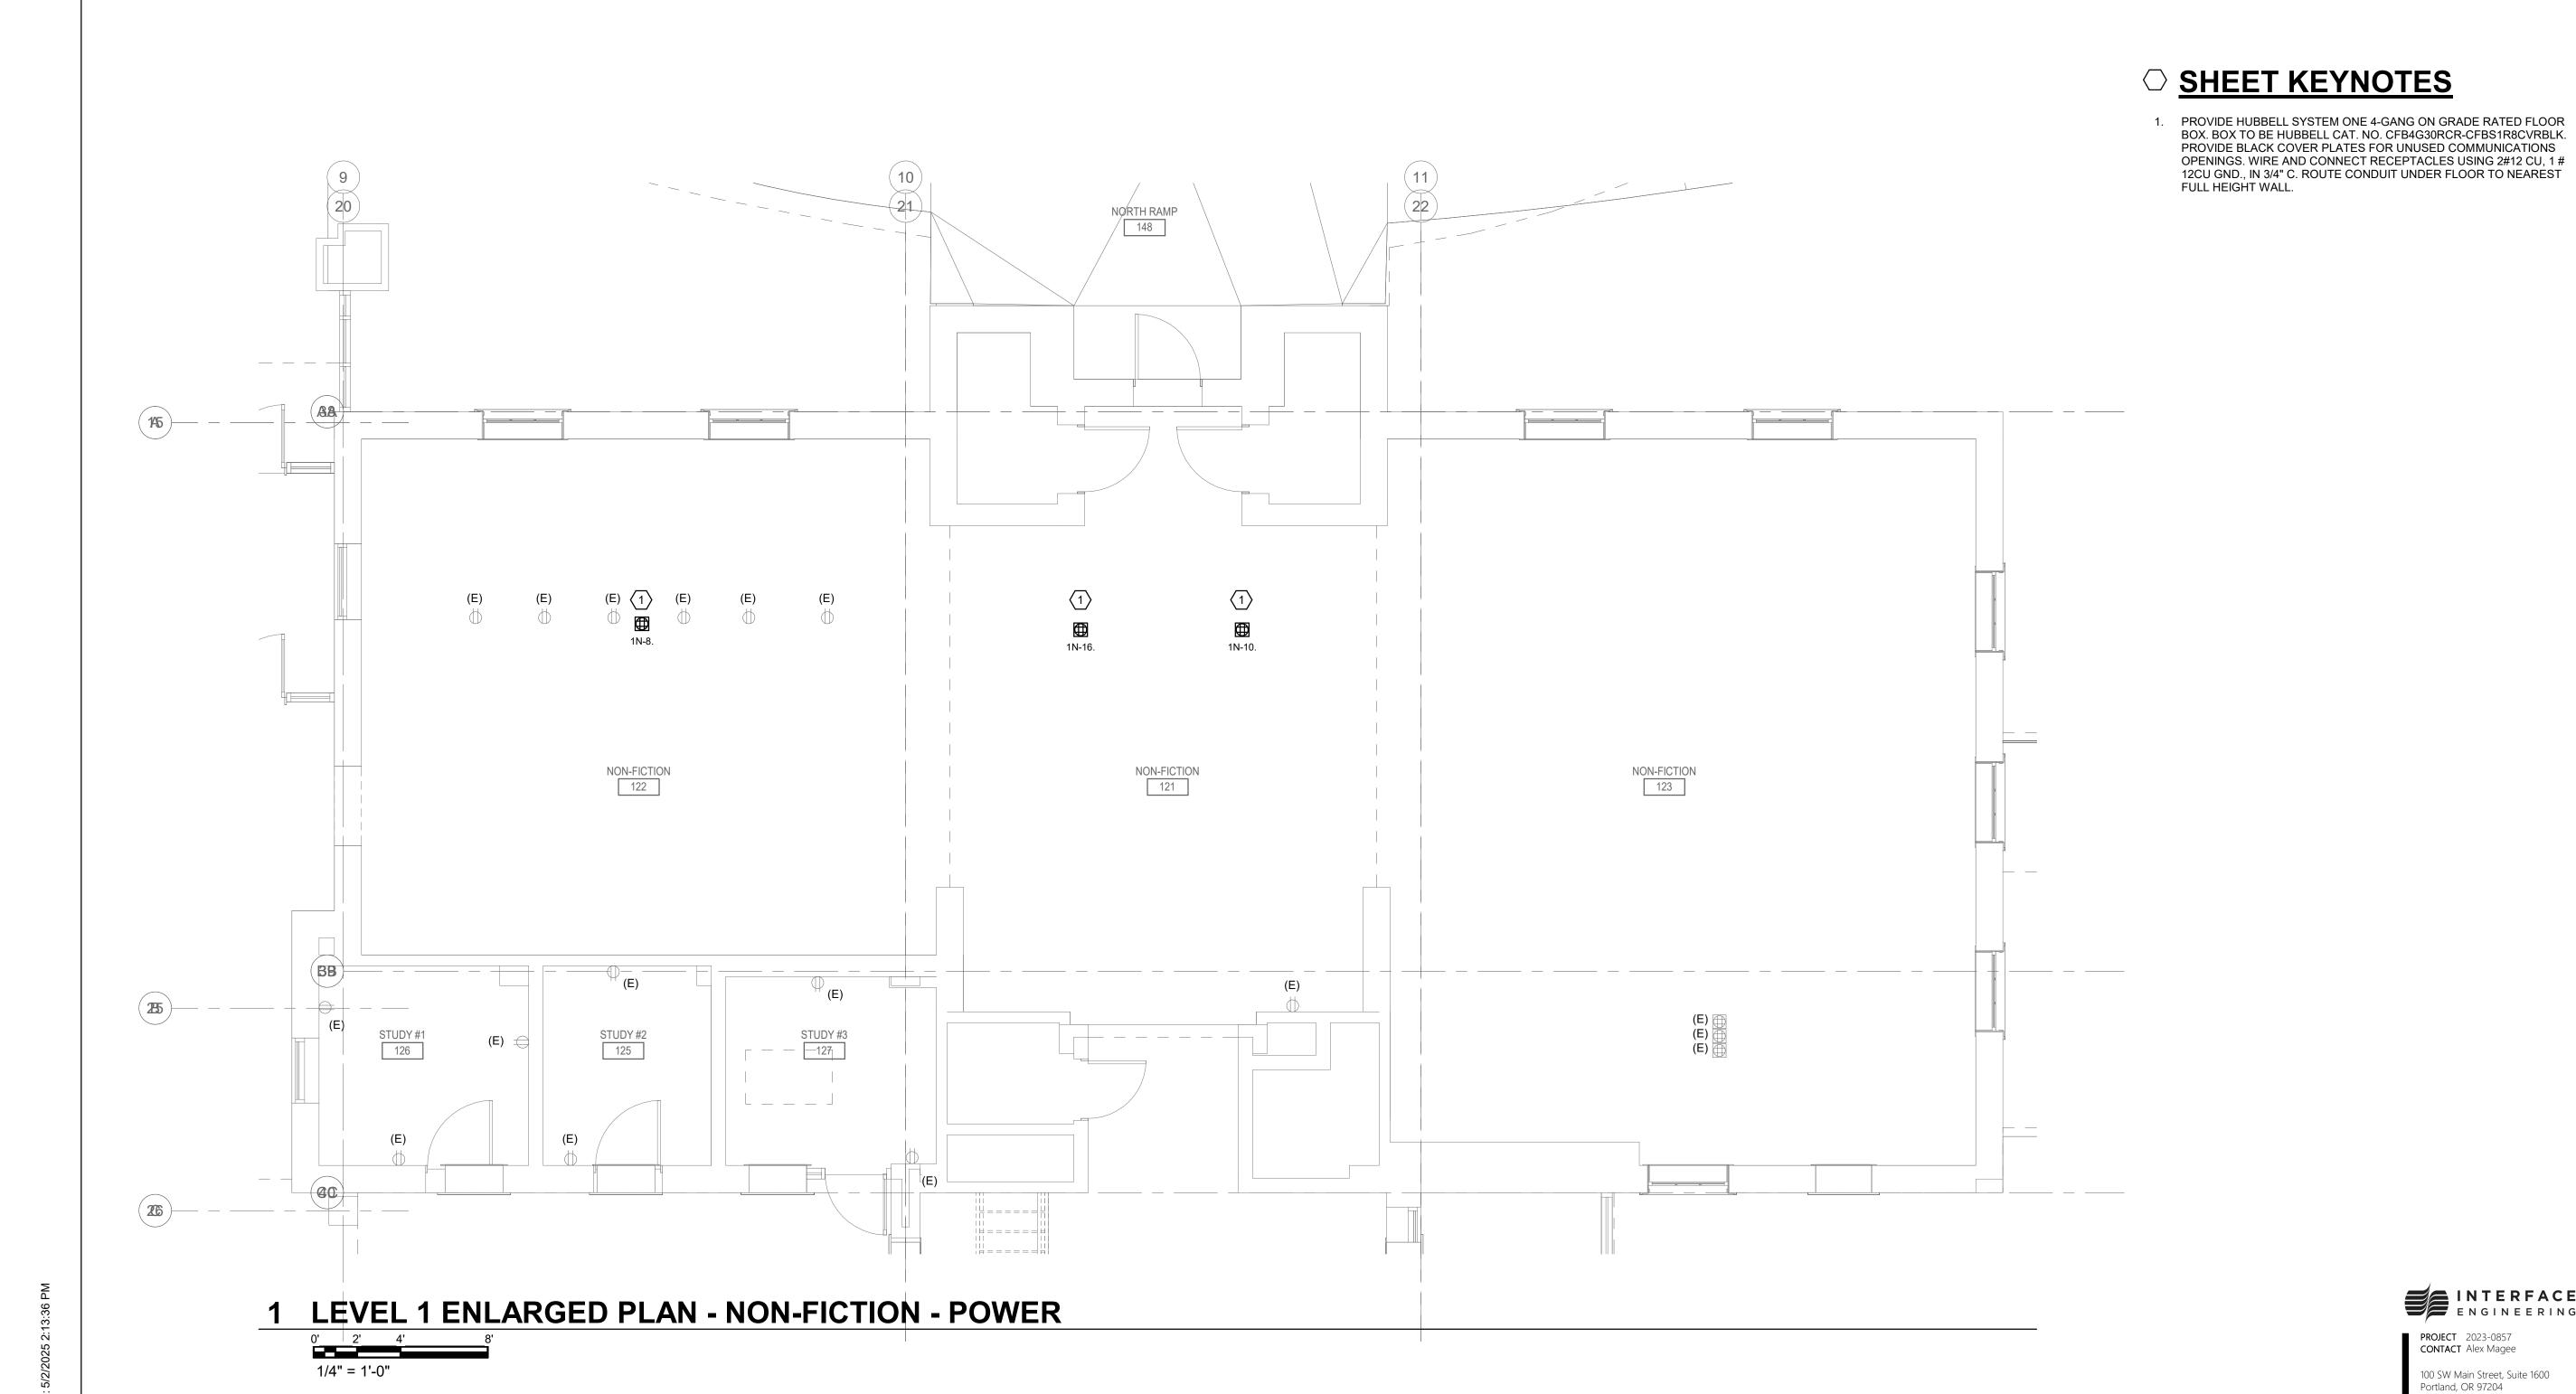
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	BUS		ITY: 10	20/208		MOUNTING: SURFACE Accessories: ENCLOSURE: TYPE 1 /, 3PH, 4 WIRE LOCATION: SUPPLIED FROM: MDP												
								Load	(AV)									
01/7	.					Α	В	С	A	В	С							014
CKT	Description/Location	Туре	C.B.	Pole	Note	540			500			Note			Туре		cription/Location	CK
1	(E) EC 108, 149	R	20 A	1		540	000		528	000			1	20 A			ELEV 1 CAB LTS	2
3	(E) REC 108		20 A	1			360	000		360	004		1	20 A	R	(E)	ELEV REC PIT	4
5	(E) REC 101, 102, 107	R	20 A	1		000		900			864		1	20 A			(E) SP-1	6
7	(E) REC 139, 143	R	20 A	1		900	700		360	000		1	1	20 A	R		R BOX NON-FICTION	8
9	(E) REC 135	R	20 A	1			720	F.40		360	000	1	1	20 A	R		PR BOX NON-FICTION	10
11	(E) REC O S	R	20 A	1		E 40		540	500		360		1	20 A		(E)	ELEV REC PIT	12
13	(E) REC 140, 42, 47	R	20 A	1		540			500	000			1	20 A	 D	D E 00	(E) EF-2	14
15	SPARE BREAKER		20 A	1			0	_		360	^	1	1	20 A	R		R BOX NON-FICTION	16
17	SPARE BREAKER		20 A	1		700		0			0		1	20 A			ARE BREAKER	18
19	(E) REC 112, 113		20 A	1		720	750		900	000			1	20 A		•	E) DOOR SEC	20
21	(E) EWC		20 A	1			750			600			1	20 A		,	E) UNKNOWN	22
23	(E) REC 125,26,27	R	20 A	1				540			0		1	20 A			ARE BREAKER	24
25	(E) REC 103,19,21	R	20 A	1		540			720			1	1	20 A	R		D. EXP. COUNTER	26
27	(E) REC O S		20 A	1			180			360		1	1	20 A	R). EXP. FLOOR BOX	28
29	(E) PUMP CONTROLLER	R	20 A	1				500			0		1	20 A		,	E) AHU-5 DOC	30
31	(E) ROOF HEAT TRACE		20 A	1		480			360			1	1	20 A	R		. EXP. FLOOR BOX	32
33	(E) ROOF HEAT TRACE		20 A	1			480			0			1	20 A			ARE BREAKER	34
35	SPARE BREAKER		20 A	1				0			0		1	20 A			ARE BREAKER	36
37	SPARE BREAKER		20 A	3		0			0				3	20 A		SP	ARE BREAKER	38
39							0			0								40
41								0			0							42
	Total Connected load Ph. A					60 A		Р		onnecte						42.5 A		
	Total Connected load Ph. B					39 A			Total	Deman	d Load:	15.3 k	:VA			42.5 A		
otes:	Total Connected load Ph. C					31 A												
	VIDE NEW LOAD ON EXISTING E	BREAKEF	₹.															
Motor	ype Definitions: (125% largest Motor + 100% rema					•	-			20.56)				•	%)		(Demand per NEC	
	ceptacles (to 10kVA100%, over 10					•		ntinuous	, ,	•	L = Lig		,			H = Heating	,	
	sting Load 30-day metered (125%)					•		per NE			W = W	ater He	eater (125%)			c Vehicle Changer	
	oad Type Connecte			N		mand F	actor			emand	Load					Panel To	otals	
,	8600					0.00%				8600.0							45000 0) /4	
	6722	2.0			10	0.00%				6722.0							15322.0 VA	
	1													1	otal NE	C Demand:	15322 0 VA	
														T-4.10	\	l O '		
R Spare													_			ed Current:	42.5 A	

1	:
CKT Description/Location Type C.B. Pole Note Note Note Pole C.B. Type Description/Location 1 (E) REC 149 R 20 A 1 180 720 1 20 A R (E) REC 135 5 (E) REC 110 R 20 A 1 180 360 1 20 A R (E) REC 135 7 (E) REC 106 R 20 A 1 360 0 1 20 A R (E) REC 137 9 (E) REC 106 R 20 A 1 180 180 180 1 20 A R (E) REC 137 11 SPARE BREAKER 20 A 1 180 180 1 20 A R (E) REC 130 15 (E) REC 108 R 20 A 1 180 180 1 20 A R (E) REC 130 15 (E) REC 108 R 20 A 1 180 180 1 <td< th=""><th>2 2 3 1 1 1 1 1</th></td<>	2 2 3 1 1 1 1 1
1	2 2 3 1 1 1 1 1
\$\$ (E) REC 110	1 1 1 1
5 (E) REC 110 R 20 A 1 360 0 360 1 20 A R (E) REC 135 7 (E) REC 106 R 20 A 1 360 0 180 1 20 A R (E) REC 137 11 SPARE BREAKER 20 A 1 80 180 1 20 A R (E) REC 137 13 (E) REC 108 R 20 A 1 180 360 1 20 A R (E) REC 137 15 (E) REC 108 R 20 A 1 180 360 1 20 A R (E) REC 130 17 (E) REC 108 R 20 A 1 180 180 1 20 A R (E) REC 130 19 (E) REC 107 R 20 A 1 180 180 1 20 A R (E) REC 130 21 (E) FB 109 R 20 A 1 180 180 1 20	1 1 1 1 1
T (E) REC 106 R 20 A 1 360 0 180 1 20 A R SPARE BREAKE 9 (E) REC 106 R 20 A 1 180 180 1 20 A R (E) REC 137 13 (E) REC 108 R 20 A 1 180 360 1 20 A R (E) REC 130 15 (E) REC 108 R 20 A 1 180 180 1 20 A R (E) REC 130 17 (E) REC 108 R 20 A 1 180 180 1 20 A R (E) REC 130 19 (E) REC 108 R 20 A 1 540 180 1 20 A R (E) REC 130 21 (E) FB 109 R 20 A 1 180 180 1 20 A R (E) REC 130 25 (E) FB 106 R 20 A 1 180 180 120 A R (2 8 1 1 1 1 1
9 (E) REC 106 R 20 A 1 180 180 180 1 20 A R (E) REC 137 11 SPARE BREAKER 20 A 1 180 180 1 20 A R (E) REC 137 13 (E) REC 108 R 20 A 1 180 360 1 20 A R (E) REC 130 15 (E) REC 108 R 20 A 1 180 180 1 20 A R (E) REC 130 17 (E) REC 108 R 20 A 1 540 360 1 20 A R (E) REC 130 19 (E) REC 107 R 20 A 1 540 360 1 20 A R (E) REC 130 21 (E) FB 109 R 20 A 1 180 180 1 20 A R (E) REC 130 25 (E) FB 106 R 20 A 1 180 360 1 20 A	1 1 1 1
13 (E) REC 108 R 20 A 1 180 360 1 20 A R (E) REC 130 15 (E) REC 108 R 20 A 1 180 180 1 20 A R (E) REC 130 17 (E) REC 108 R 20 A 1 180 180 1 20 A R (E) REC 130 19 (E) REC 107 R 20 A 1 540 80 1 20 A R (E) REC 130 21 (E) FB 109 R 20 A 1 180 180 1 20 A (E) REC 130 23 (E) FB 109 R 20 A 1 180 180 1 20 A R (E) REC 130 25 (E) FB 106 R 20 A 1 180 360 1 20 A R (E) REC 130 31 (E) FB 106 R 20 A 1 180 360 1 20 A R (E	1 1 1
15 (E) REC 108 R 20 A 1 180 180 1 20 A R (E) REC 130 17 (E) REC 108 R 20 A 1 180 180 1 20 A R (E) REC 130 19 (E) REC 107 R 20 A 1 540 360 1 20 A R (E) REC 130 21 (E) FB 109 R 20 A 1 180 180 1 20 A - (E) REC 130 23 (E) FB 109 R 20 A 1 180 180 1 20 A R (E) REC 130 25 (E) FB 106 R 20 A 1 180 360 1 20 A R (E) REC 130 27 (E) FB 106 R 20 A 1 180 360 1 20 A R (E) REC 130 31 (E) FB 106 R 20 A 1 180 360 1 20 A R (E)	1
17 (E) REC 108 R 20 A 1 180 180 1 20 A R (E) REC 130 19 (E) REC 107 R 20 A 1 540 360 1 20 A R (E) REC 130 21 (E) FB 109 R 20 A 1 180 180 1 20 A (E) REC 130 23 (E) FB 109 R 20 A 1 180 180 1 20 A R (E) REC 130 25 (E) FB 106 R 20 A 1 180 360 1 20 A R (E) REC 130 27 (E) FB 106 R 20 A 1 180 360 1 20 A R (E) REC 125 29 (E) FB 106 R 20 A 1 180 360 1 20 A R (E) REC 130 33 (E) FB 106 R 20 A 1 180 360 1 20 A R (E)	1
19 (E) REC 107 R 20 A 1 540 360 1 20 A R (E) REC 130 21 (E) FB 109 R 20 A 1 180 180 1 20 A (E) REC 130 23 (E) FB 109 R 20 A 1 180 180 1 20 A R (E) REC 130 25 (E) FB 106 R 20 A 1 180 360 1 20 A R (E) REC 133 (E) REC 130 29 (E) FB 106 R 20 A 1 180 360 1 20 A R (E) REC 125 (E) REC 130 R (E) FB 106 R 20 A 1 180 360 1 20 A R (E) REC 130 R (E) FB 106 R 20 A 1 180 360 1 20 A R (E) REC 130 R (E) FB 106 R 20 A 1 180 360 1 20 A R (E) REC	
21 (E) FB 109 R 20 A 1 180 180 1 20 A (E) REC 130 23 (E) FB 109 R 20 A 1 180 180 1 20 A R (E) REC 130 25 (E) FB 106 R 20 A 1 180 360 1 20 A R (E) REC 103, 17 27 (E) FB 106 R 20 A 1 180 360 1 20 A R (E) REC 126 29 (E) FB 106 R 20 A 1 180 360 1 20 A R (E) REC 126 29 (E) FB 106 R 20 A 1 180 360 1 20 A R (E) REC 125, 12 31 (E) FB 106 R 20 A 1 180 360 1 20 A R (E) REC 130 35 (E) FB 106 R 20 A 1 180 360 1 20 A R <t< td=""><td></td></t<>	
23 (E) FB 109 R 20 A 1 180 180 1 20 A R (E) REC 130 25 (E) FB 106 R 20 A 1 180 720 1 20 A R (E) REC 103, 12 27 (E) FB 106 R 20 A 1 180 360 1 20 A R (E) REC 126 29 (E) FB 106 R 20 A 1 180 360 1 20 A R (E) REC 126 31 (E) FB 106 R 20 A 1 180 360 1 20 A R (E) REC 130 33 (E) FB 106 R 20 A 1 180 360 1 20 A R (E) REC 130 35 (E) FB 106 R 20 A 1 180 360 1 20 A R (E) REC 130 39 (E) FB 106 R 20 A 1 360 1 20 A R (E) REC 130 <td></td>	
25 (E) FB 106 R 20 A 1 180 720 1 20 A R (E) REC 103, 11 27 (E) FB 106 R 20 A 1 180 360 1 20 A R (E) REC 126 29 (E) FB 106 R 20 A 1 180 360 1 20 A R (E) REC 125, 12 31 (E) FB 106 R 20 A 1 180 360 1 20 A R (E) REC 130 35 (E) FB 106 R 20 A 1 180 360 1 20 A R (E) REC 130 37 (E) FB 106 R 20 A 1 180 360 1 20 A R (E) REC 130 39 (E) FB 106 R 20 A 1 360 360 1 20 A R (E) REC 130 41 (E) REC 110 R 20 A 1 360 360 1 20 A R <t< td=""><td>2</td></t<>	2
27 (E) FB 106 R 20 A 1 180 360 1 20 A R (E) REC 126 29 (E) FB 106 R 20 A 1 180 360 1 20 A R (E) REC 125, 12 31 (E) FB 106 R 20 A 1 180 360 1 20 A R (E) REC 130 35 (E) FB 106 R 20 A 1 180 360 1 20 A R (E) REC 130 37 (E) FB 106 R 20 A 1 180 360 1 20 A R (E) REC 131 39 (E) FB 106 R 20 A 1 360 360 1 20 A R (E) REC 130 41 (E) REC 110 R 20 A 1 360 360 1 20 A R (E) REC 130 43 (E) REC 130 R 20 A 1 180 360 1 20 A R (2
29 (E) FB 106 R 20 A 1 180 360 1 20 A R (E) REC 125, 12 31 (E) FB 106 R 20 A 1 180 360 1 20 A R (E) REC 130 33 (E) FB 106 R 20 A 1 180 360 1 20 A R (E) REC 130 35 (E) FB 106 R 20 A 1 180 360 1 20 A R (E) REC 130 37 (E) FB 106 R 20 A 1 180 360 1 20 A R (E) REC 130 39 (E) REC 110 R 20 A 1 360 360 1 20 A R (E) REC 130 41 (E) REC 110 R 20 A 1 360 360 1 20 A R (E) REC 130 43 (E) REC 130 R 20 A 1 180 360 1 20 A R	2
31 (E) FB 106 R 20 A 1 180 360 1 20 A R (E) REC 130 33 (E) FB 106 R 20 A 1 180 360 1 20 A R (E) REC 130 35 (E) FB 106 R 20 A 1 180 360 1 20 A R (E) REC 131 37 (E) FB 106 R 20 A 1 180 360 1 20 A R (E) REC 130 39 (E) REC 110 R 20 A 1 360 360 1 20 A R (E) REC 130 41 (E) REC 110 R 20 A 1 360 360 1 20 A R (E) REC 131 43 (E) REC 130 R 20 A 1 180 360 1 20 A R (E) REC 122 45 (E) REC 130 R 20 A 1 360 360 1 20 A R (E)	3
35 (E) FB 106 R 20 A 1 180 360 1 20 A R (E) REC 131 37 (E) FB 106 R 20 A 1 180 360 1 20 A R (E) REC 130 39 (E) REC 110 R 20 A 1 360 1 20 A R (E) REC 130 41 (E) REC 130 R 20 A 1 360 360 1 20 A R (E) REC 131 43 (E) REC 130 R 20 A 1 180 360 1 20 A R (E) REC 122 45 (E) REC 130 R 20 A 1 360 360 1 20 A R (E) REC 122 47 (E) FB 106 R 20 A 1 180 360 1 20 A R (E) REC 121 49 (E) FB 106 R 20 A 1 180 360 1 20 A R (E) REC 123 <td>3</td>	3
37 (E) FB 106 R 20 A 1 180 360 360 1 20 A R (E) REC 130 39 (E) REC 110 R 20 A 1 360 360 1 20 A R (E) REC 130 41 (E) REC 110 R 20 A 1 360 360 1 20 A R (E) REC 131 43 (E) REC 130 R 20 A 1 180 360 1 20 A R (E) REC 122 45 (E) REC 130 R 20 A 1 360 360 1 20 A R (E) REC 122 47 (E) REC 130 R 20 A 1 360 360 1 20 A R (E) REC 122 47 (E) FB 106 R 20 A 1 180 360 1 20 A R (E) REC 121 51 (E) FB 106 R 20 A 1 180 720 1 20 A	3
39	3
41 (E) REC 110 R 20 A 1 360 360 1 20 A R (E) REC 131 43 (E) REC 130 R 20 A 1 180 360 1 20 A R (E) REC 122 45 (E) REC 130 R 20 A 1 360 360 1 20 A R (E) REC 122 47 (E) FB 106 R 20 A 1 180 360 1 20 A R (E) REC 121 49 (E) FB 106 R 20 A 1 180 360 1 20 A - (E) REC 121 51 (E) FB 106 R 20 A 1 180 720 1 20 A R (E) REC 123	3
43 (E) REC 130 R 20 A 1 180 360 1 20 A R (E) REC 122 45 (E) REC 130 R 20 A 1 360 360 1 20 A R (E) REC 122 47 (E) FB 106 R 20 A 1 180 360 1 20 A R (E) REC 121 49 (E) FB 106 R 20 A 1 180 360 1 20 A (E) REC 121 51 (E) FB 106 R 20 A 1 180 720 1 20 A R (E) REC 123	4
45 (E) REC 130 R 20 A 1 360 360 1 20 A R (E) REC 122 47 (E) FB 106 R 20 A 1 180 360 1 20 A R (E) REC 121 49 (E) FB 106 R 20 A 1 180 360 1 20 A (E) REC 121 51 (E) FB 106 R 20 A 1 180 720 1 20 A R (E) REC 123	4
47 (E) FB 106 R 20 A 1 180 360 1 20 A R (E) REC 121 49 (E) FB 106 R 20 A 1 180 360 1 20 A (E) REC 121 51 (E) FB 106 R 20 A 1 180 720 1 20 A R (E) REC 123	4
49 (E) FB 106 R 20 A 1 180 360 1 20 A (E) REC 121 51 (E) FB 106 R 20 A 1 180 720 1 20 A R (E) REC 123	4
51 (E) FB 106 R 20 A 1 180 720 1 20 A R (E) REC 123	5
	5
53 (E) REC 107 R 20 A 1	5
55 (N) + (E) REC 107 R 20 A 1 1 180 180 1 20 A R (E) FB 107	5
57 (N) + (E) REC 107 R 20 A 1 1 180 180 1 20 A R (E) FB 107	5
59 (E) FB 120 R 20 A 1 180 180 1 20 A R (E) FB 107	6
61 (E) FB 120 R 20 A 1 180 180 1 20 A R (E) FB 107	6
63 (E) FB 120 R 20 A 1 180 180 1 20 A R (E) FB 107	6
65 (E) FB 120 R 20 A 1 180 180 1 20 A R (E) FB 107	6
67 (E) FB 120 R 20 A 1 180 0 1 20 A (E) REC 225 69 (E) FB 120 R 20 A 1 180 0 1 20 A (E) REC 225	7
69 (E) FB 120 R 20 A 1 180 0 1 20 A (E) REC 225 71 (E) FB 120 R 20 A 1 180 0 1 20 A SPARE BREAKE	
73 (E) FB 120 R 20 A 1 180 0 1 20 A SPARE BREAKE	
75 (E) FB 109 R 20 A 1 360 0 1 20 A SPARE BREAKE	
77 (E) FB 109 R 20 A 1 360 0 1 20 A SPARE BREAKE	
79 (E) FB 109 R 20 A 1 360 0 1 20 A SPARE BREAKE	
81 (E) FB 109 R 20 A 1 360 0 1 20 A SPARE BREAKE	8
83 SPARE BREAKER 20 A 1 0 0 1 20 A SPARE BREAKE	8
Total Connected load Ph. A 61 A Panel Connected Load: 19.6 kVA 54.5 A Total Connected load Ph. B 57 A Total Demand Load: 15.1 kVA 41.9 A	
Total Connected load Ph. C 48 A Notes: I. PROVIDE NEW LOAD ON EXISTING BREAKER.	



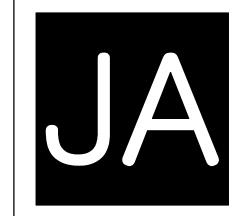

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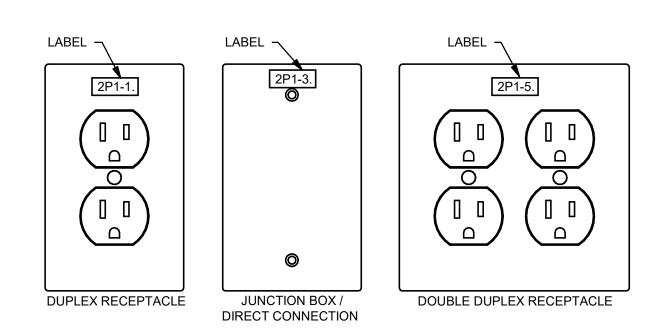
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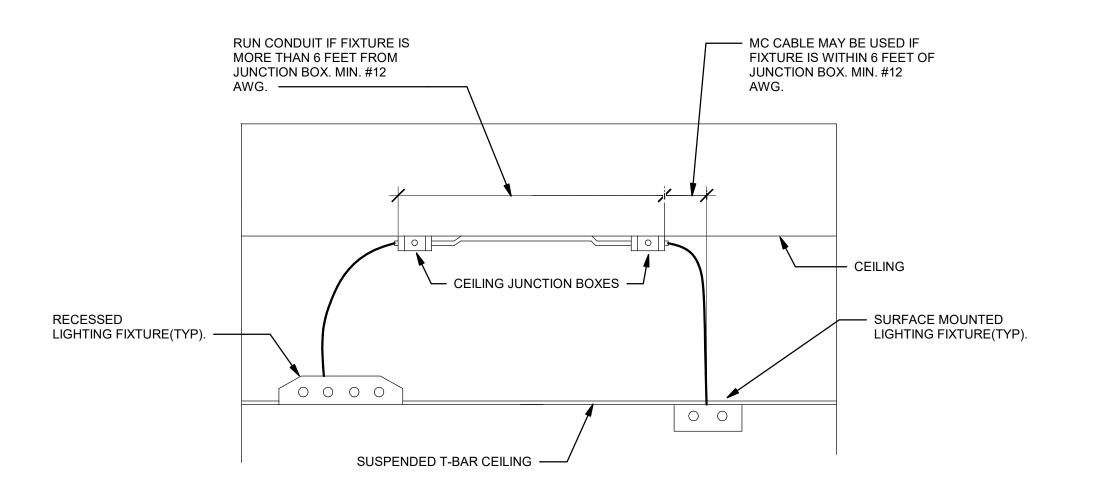
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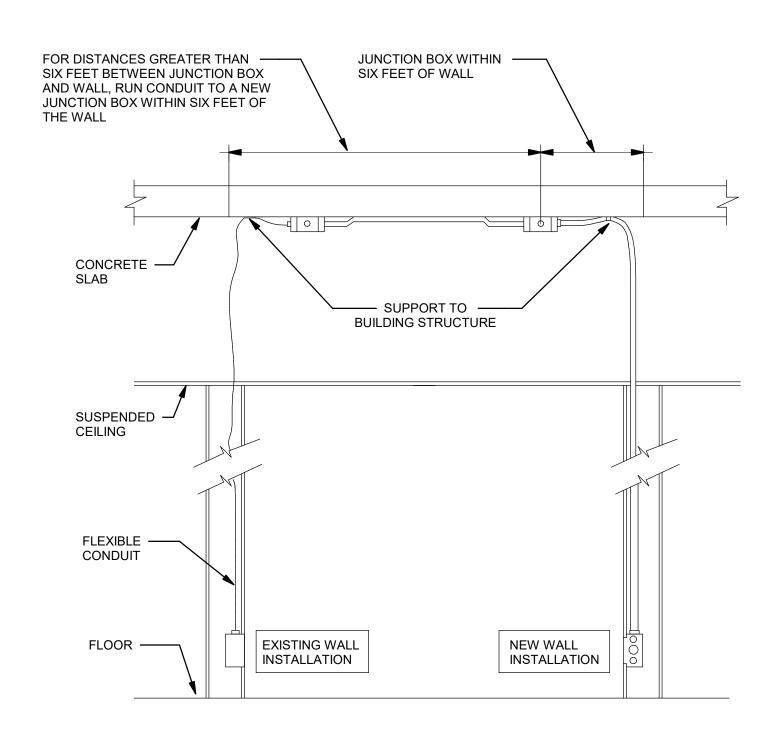


DETAIL NOTES:

(1) MC CABLE IS ONLY PERMITTED FOR FIXTURE DROPS. DO NOT LOOP MC CABLE FROM ONE FIXTURE TO ANOTHER.

LIGHTING DROP - DETAIL

NO SCALE



GENERAL DETAIL NOTES:

- 1. NEW WALL INSTALLATION RUN CONDUIT FROM JUNCTION BOX DOWN TO FIRST DEVICE.
- 2. EXISTING WALL INSTALLATION RUN FLEX OR MC CABLE FROM JUNCTION BOX DOWN TO DEVICE.
- 3. ALL CONDUITS ARE TO BE DIRECTLY SUPPORTED FROM SLAB.
- 4. COORDINATE ROUTE WITH OTHER TRADES TO AVOID CONFLICTS WITH ACCESS.

2 POWER DROP DETAIL

NO SCALE



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