

DESIGN REVIEW COMMITTEE MEETING AGENDA Wednesday, February 13, 2019, 4:00 PM City Hall, 616 NE 4th Avenue

I. CALL TO ORDER

II. ROLL CALL / INTRODUCTIONS

III. MEETING ITEMS

A. SS Design Duplex (DR19-03)

Presenter: Madeline Sutherland, Assistant Planner

Recommended Action: Staff recommends that the Design Review Committee (DRC) review the submitted materials, deliberates and forwards a recommendation to the Director for a final decision.

- SS Design Duplex Staff Report (DR19-03)
 - 1 Applicant's Narrative
 - 2 Site Plan
 - 3 Elevations
 - 4 Landscape Plan
 - 5 Design Review Checklist
 - 6 Vicinity Map
- B. Sampson Sports Expansion (DR18-10)

Presenter: Lauren Hollenbeck, Senior Planner

Recommended Action: Staff recommends that the Design Review Committee (DRC) review the submitted materials, deliberates and forwards a recommendation to the Director for a final decision.

- Sampson Sports Expansion Staff Report (DR18-10)
 - 1 Applicant's Narrative
 - 2 Vicinity Map & Site Plan
 - 3 Elevations
 - 4 Landscape Plan
 - 5 Floor Plans
 - 6 Design Review Checklist

IV. ADJOURNMENT

in the	public	meetii	ng pro	cess. A	spec	cial effor	t will	be m	ade to	ensu	re that	of its citi persons call the	with
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STAFF REPORT

DESIGN REVIEW
DR19-03 SS Design Duplex

To: Design Review Committee

From: Madeline Sutherland, Assistant Planner

Applicant: SS Design

6161 NE HWY 99 #101a Vancouver, WA 98665

Location: NW 6th Ave

Parcel No. 85255000

APPLICABLE LAW: The application was submitted on January 14, 2019. The applicable codes are those codes that were in effect at the date of application. Camas Municipal Code Chapters (CMC): Title 18 Zoning (not exclusively): CMC Chapter 17.21 Procedures for Public Improvements; CMC Chapter 18.19 Design Review; Camas Design Review Manual (2016); and CMC Chapter 18.55 Administration and Procedures; and RCW 58.17.

BACKGROUND:

The duplex is located on approximately .18 acres of multi-family zoned property (MF-18), surrounded by multi-family residential, North of NW 6th Ave and South of NW 7th Ave in the SW ½ of Section 10, Township 1 North, Range 3 East, of the Willamette Meridian.

PURPOSE:

Design Review is required under CMC Chapter 18.19. Design review is not intended to determine the appropriate use on a parcel but rather review a proposed development for compliance with City codes and plans related to landscaping, architectural elevations and other elements relative to required improvements. The recommendations from the Design Review Committee (DRC) must consider the general design review standards (CMC Chapter 18.19.050.A and the Camas Design Review Manual "DRM" pages 4-7), along with the specific standards for multi-family (CMC Chapter 18.19.050.B.3.c and the DRM page 19); which are included in the enclosed Design Review Checklist.

STANDARD AND MULTI-FAMILY DESIGN PRINCIPLES AND GUIDELINES:

The standard and multi-family principles are required and must be demonstrated to have been satisfied in overall intent for design review approval. The standard design guidelines are developed to assist a project in meeting the established principles and each guideline should be adequately addressed. If the proposal cannot meet a specific guideline, then an explanation should be provided by the applicant as to why and how it will be mitigated to satisfy the intent

of the design principles. The development guidelines include five major categories: 1) Landscaping and Screening, 2) Architecture, 3) Massing and Setbacks, 4) Historic & Heritage Preservation, and 5) Circulation and Connections. The Design Review Checklist is enclosed to help guide the DRC in reviewing the standard applicable specific design review principles and guidelines.

RECOMMENDATION:

That the Design Review Committee reviews the submitted materials, deliberates, and forwards a recommendation to the Director for a final decision.





6168 NE HWY 99 STE 101A VANCOUVER, WA. 98665

PHONE: (360) 521-3667


January 9, 2019

NARRATIVE – Duplex Design Review

Parcel 85255000

Proposing duplex on flag lot. Building to consist of 2 two residential units. Gross footprint 1960 sqft. Building will be 2 story with dimensions of 49 feet wide by 40 feet deep. Approximate building height to be 28 feet. Building will be as traditional stick framed walls with manufactured roof trusses, sitting on a concrete foundation. Building exterior will fiber cement lap siding with trim, architectural asphalt shingles, with earth tone colors. Landscape to surround the building with paved parking at the from garage door per attached site and landscape plan. As for how this duplex conforms to the design review manual, the garages of the building make up for 44% of the building width.

---- NW 7TH AVE

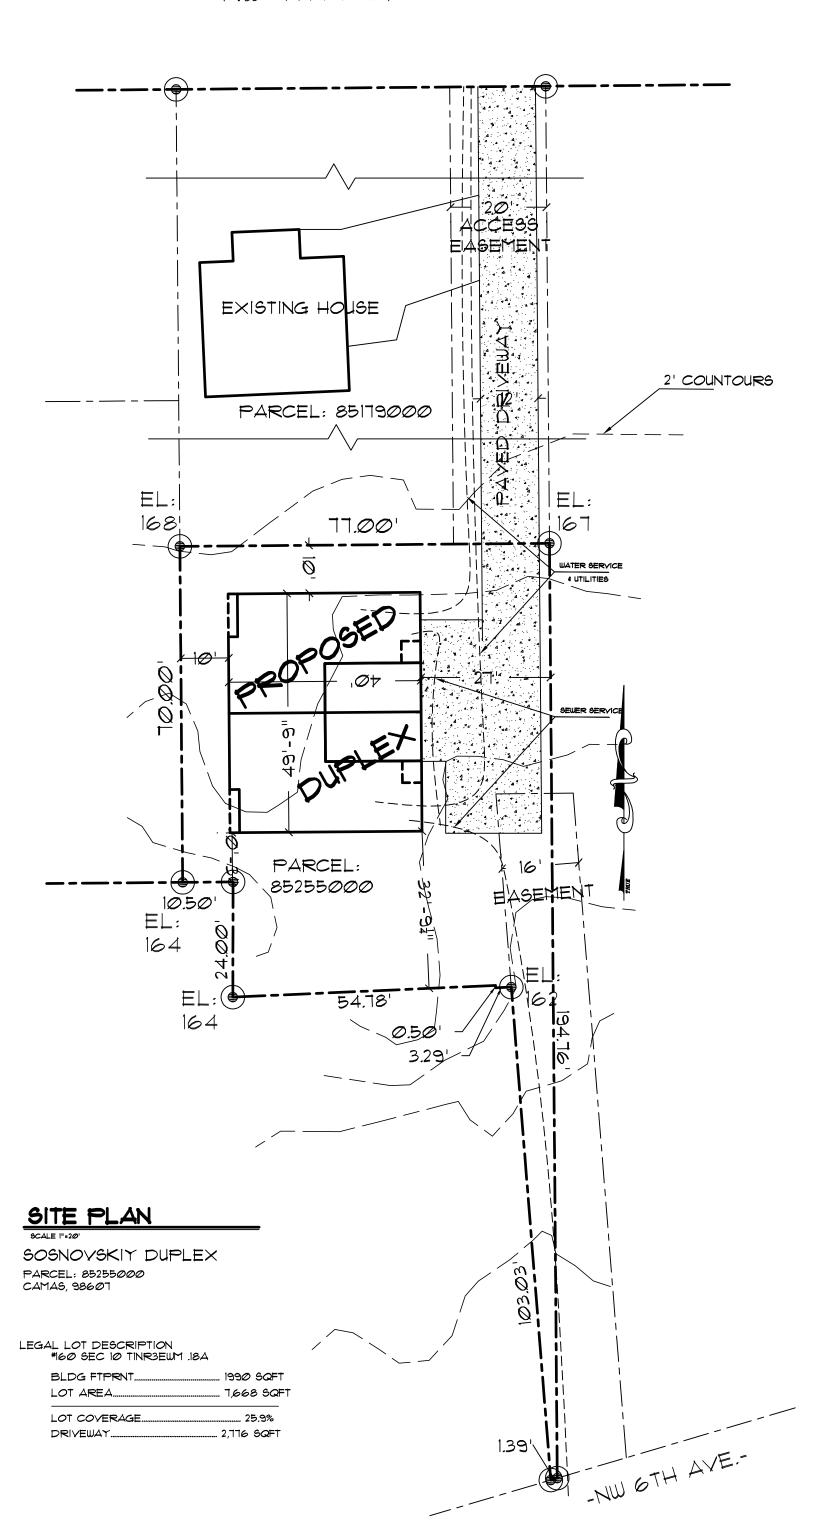

SHEET: A1.00

Exhibit 3

SSD JOB# 18-1055


Design-r, Washington tel. (360) 521-3667


IY DUPLE 130TH ST :, WA 98685 SOSNOVSKI 712 NE 13 Vancouver,

REV. DATE:

SLAVIK S. 09.14.18

NOTE:
CONSTRUCTION TO BE IN ACCORDANCE WITH ALL
APPLICABLE BUILDING CODES.
IT IS RESPONSIBILITY OF THE CONTRACTOR/ BUILDER
TO CHECK FOR ERRORS ON THIS PLAN.
WRITTEN DIMENSIONS HAVE PRECEDENCE OVER SCALED DIMENSIONS.

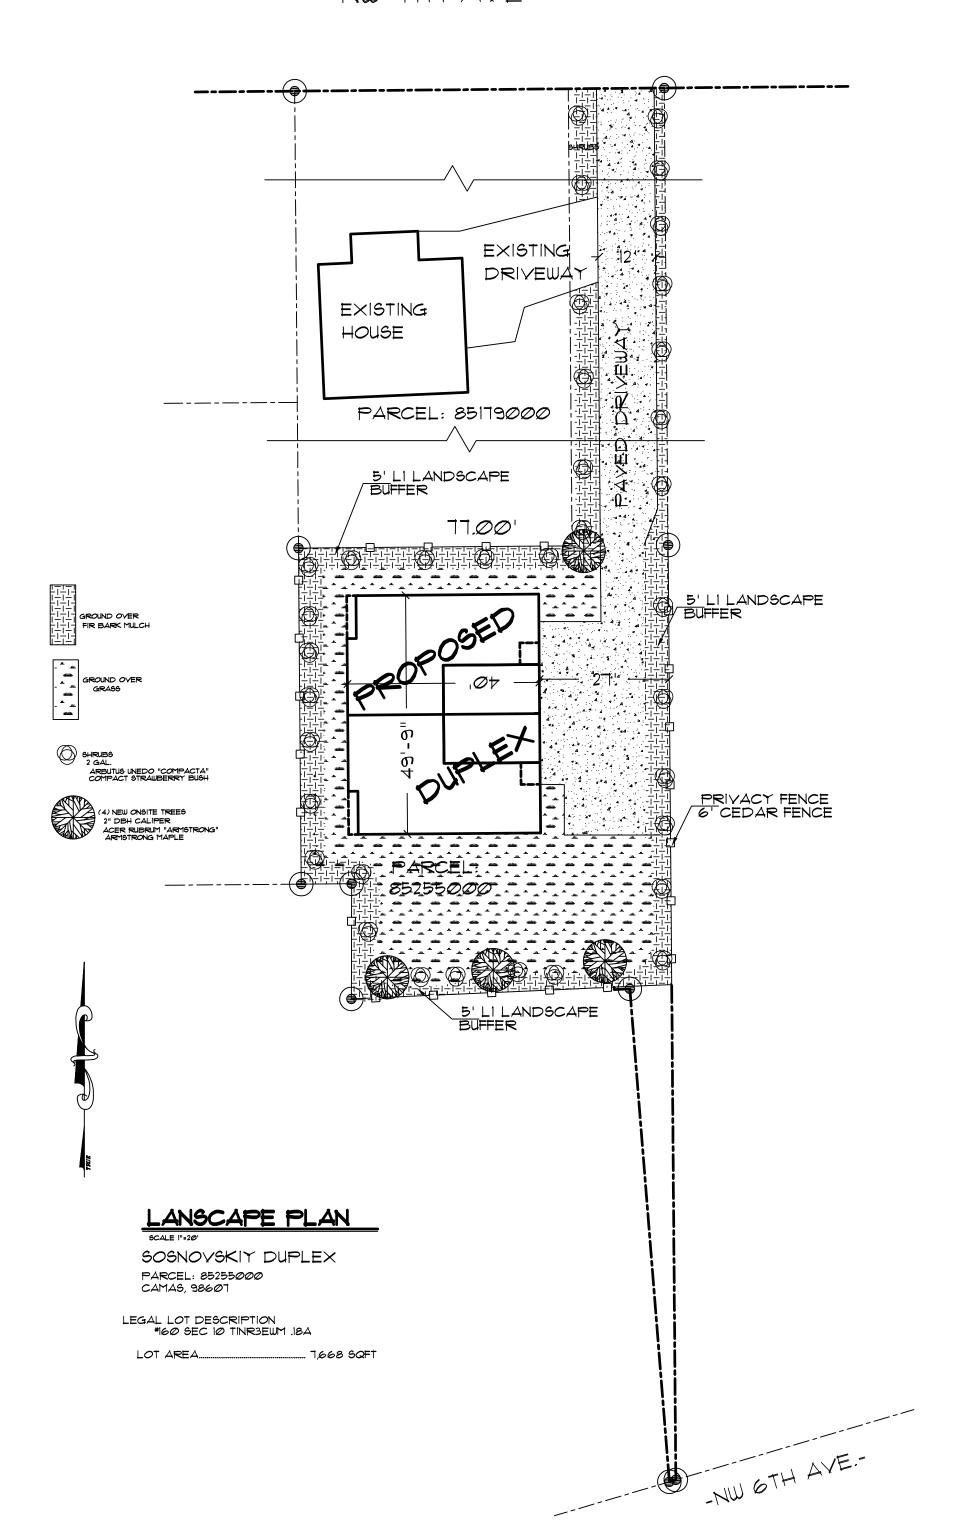

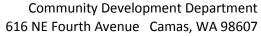



Design Review Checklist – DR19-03 SS Design Duplex

The purpose of this sheet is to provide a simplified and expedited review of the design review principles and guidelines using objective review standards. The standards are intended as tool for the decision-maker in making findings that the proposal either achieves compliance with the intent of the principles or reasonably mitigates any conflict. When reviewing the check sheet, the proposal should as a whole "comply" with the standards and thus be generally consistent with the overriding principles. [Yes = In Compliance; No = Not In Compliance; NA = Not Applicable]

Standard Principles and Guidelines

ARCH	HITECT	URE		
Yes	No	NA	Principles and Guidelines	Comments
			Corrugated materials, standing seam, T-1 11, or similar	
			siding materials are avoided unless it produces a high	
			visual (or aesthetic) quality.	
			Buildings walls or fences visible from roadways are	
			articulated in order to avoid a blank look.	
			The use of bold colors has been avoided unless used as	
			minor accents.	
			Higher density/larger structures abutting lower density	
			residential structures have been designed to mitigate	
			size and scale differences.	
LAND	SCAPI	ING AI	ND SCREENING	
Yes	No	NA	Principles and Guidelines	Comments
			Vegetation for landscaping includes native, low	
			maintenance plantings. Significant trees are retained if	
			feasible.	
			Trees planted along streetscapes with overhead power	
			lines include only those trees identified on the City's	
			Tree list.	
			Landscaping, including trees, shrubs, and vegetative	
			groundcover, is provided to visually screen and buffer	

			the use from adjoining less intense uses including	
			parking.	
			Proposed fencing is incorporated into the landscaping so	
			as to have little or no visual impact.	
			Signs located on buildings or incorporated into the	
			landscaping are unobtrusive and vandal resistant. If	
			illuminated they are front lit.	
			Landscape lighting - low voltage, non-glare, indirect	
			lighting is directed, hooded or shielded away from	
			neighboring properties.	
			Street lighting (poles, lamps) is substantially similar or	
			architecturally more significant than other street lighting	
			existing on the same street and do not conflict with any	
			City approved street lighting plans for the street.	
			Parking and building lighting is directed away from	
			surrounding properties through the use of hooding,	
			shielding, siting and/or landscaping.	
			Outdoor furniture samples are consistent with the	
			overall project design.	
			Existing trees over 6" dbh that are not required to be	
			removed to accommodate the proposed development	
			are retained and incorporated into the landscape plan.	
			Rock outcropping's, forested areas and water bodies are	
LUCTO	DIC A		retained. ERITAGE PRESERVATION	
				Commonts
Yes	No	NA	Principles and Guidelines	Comments
			The use of Historic Markers, information kiosks, project names, architectural features, or other elements of the	
			project promote the historic heritage of the site or	
			surrounding area.	


Specific Principles and Guidelines

			MULTI-F	AMILY
Yes	No	NA	Principles and Guidelines	Comments
1	. STA	CKED	HOUSING (APARTMENTS)	
	Lar	ndscap	ing & Screening	
			Green belts are used to separate different uses	
			whenever possible.	
			Vertical intensity of landscaping increases as the height	
			of the structure increases.	
			Stacked housing abutting or located in single-family	
			residentially zoned areas is designed to mitigate size and	
			scale differences.	
			Watering system will maintain proposed landscaping for	
			a period to ensure that plants are well established.	
	Arc	hitectı	ure & Streetscape	
			Buildings are brought up to the road to help define	
			traffic/pedestrian movements.	
			Principal pedestrian entrances of buildings are along a	
			street, open space or mid-block passage with the	
			exceptions of visible entrances off a courtyard.	
			Walls are articulated in order to avoid a blank look and	
			provide a sense of scale including a minimum solid to	
			void ratio of 70%/30%.	
			All on-site parking areas are screened with landscaping.	
			Parking spaces are clustered in small groups of no more	
			than 6-10 spaces and separated by landscaping to create a pedestrian friendly park-like environment.	
			Detachable garages are located to the rear of stacked	
			unit(s) so as not to be directly viewable from a public	
			street.	
			Attached garages must be underground or to the rear of	
			the units. If visible to adjoining properties, then they will	
			account for less than 30% of the front face of the	
			structure and articulated by architectural features, such	
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	as windows, to avoid a blank look.	
	Stoops, porches and direct individual entries are	
	included in the ground-floor units.	
	Street lighting poles and lamps are compatible with	
	other nearby lighting on the same street, unless other	
	lighting is expected to be replaced in the foreseeable	
	future or a nostalgic theme compatible with the	
	proposed development is desired. Surrounding sites are	
	screened from parking and building lighting.	
2. TO	WNHOMES AND ROWHOUSES	
	All on-site parking areas (excluding driveways & garages)	
	are screened with landscaping. Width of driveway is	
	minimized and front yard landscaping is maximized.	
	Buildings are brought up to the road to help define	
	traffic/pedestrian movements.	
	Structures abutting or located in single family	
	residentially zoned areas are designed to mitigate size	
	and scale differences when appropriate.	
	Walls are articulated in order to avoid a blank look and	
	provide a sense of scale including a minimum solid to	
	void ratio of 70%/30%.	
	Detachable garages are located to the rear of the	
	townhouse or rowhouse unit(s) so as not to be directly	
	viewable from a public street.	
	Attached garages account for less than 50% of the front	
	face of the structure (as measured by lineal footage).	
	Garages visible from the street are articulated by	
	architectural features, such as windows, to avoid a blank	
	look.	
	Green belts are used to separate different uses	
	whenever possible.	
	Vertical intensity of landscaping increases as the height	
	of the structure increases.	
3. DU	JPLEX, TRIPLEX & FOUR-PLEX	
	Corner lots are preferred, and include fronts oriented to	
	the street (In other words, each unit faces a street).	

	Attached garages account for less than 50% of the front	
	face of the structure (as measured by lineal footage).	
	Garages visible from the street are articulated by	
	architectural features, such as windows, to avoid a blank	
	look.	
	Buildings provide a complementary façade that faces the	
	public right of way, and is the primary entrance to a unit	
	or multiple units, unless impracticable.	

Exhibit 6 DR19-03



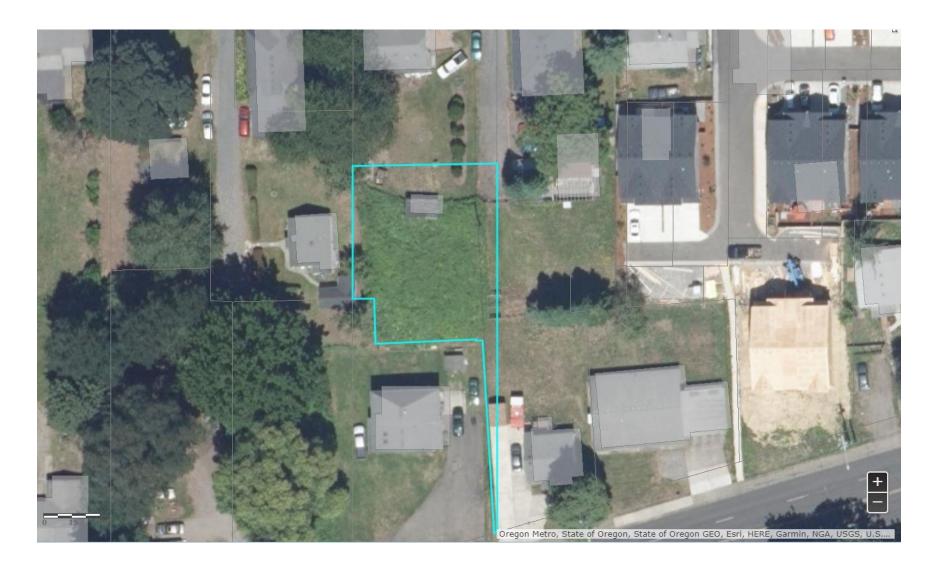

DESIGN REVIEW STAFF REPORT

Samson Sports Expansion DR18-10

Relates Files: SPRV18-06, BSP18-01, SEPA18-24

TO Design Review Committee

<u>FROM</u> Lauren Hollenbeck, Senior Planner

LOCATION 4325 NW Lake Rd Camas 98607

Parcel No. 175935-000

<u>APPLICANT</u> Brian Groth – BSG Design

360.567.9470

OWNER Scott Parnell

1500 NW Ivy St Camas 98607

360.833.2507

APPLICABLE LAW: The application was submitted on October 3, 2018 and the applicable codes are those codes that were in effect at the date of application. Camas Municipal Code (CMC) Title 16 Environment, Title 17 Land Development, and Title 18, specifically (but not limited to): Chapter 18.11 - Parking, Chapter 18.13 - Landscaping, Chapter 18.18 - Site Plan Review, Chapter 18.19 Design Review, and Chapter 18.55 Administrative Procedures.

Summary

The applicant is currently seeking design review approval for the construction of a 9,427 square foot building for powder coating, parking for employees, customers and boat/trailer parking for business, along with associated landscaping. Vehicular access to the building is provided off NW Lake Road. The majority of the landscaping is focused along the perimeter of the property.

The Samson Sports business site is zoned Regional Commercial including vacant parcels that border the site to the north, east, and west. Single family residential uses within the site's vicinity are also within the Regional Commercial zone. To the south, the original development site is fronting NW Lake road and south of NW Lake Road is Wafertech, which is zoned Light Industrial/Business Park.

<u>Purpose</u>

Design Review is required under CMC Chapter 18.19. Design review is not intended to determine the appropriate use on a parcel but rather review a proposed development for compliance with City codes and plans related to landscaping, architectural elevations and other elements relative to required improvements. The recommendations from the Design Review Committee (DRC) must consider the design review standards from the Design Review Manual. An enclosed checklist is to help guide you in your review but refer to the manual for specific details regarding the standards.

Standard, Commercial & Mixed Uses Design Principles and Guidelines

The standard and commercial & mixed use principles are required and must be demonstrated to have been satisfied in overall intent for design review approval. The standard design guidelines are developed to assist a project in meeting the established principles and each guideline should be adequately addressed. If the proposal cannot meet a specific guideline, then an explanation should be provided by the applicant as to why and how it will be mitigated to satisfy the intent of the design principles. The development guidelines include five major categories: 1) Landscaping and Screening, 2) Architecture, 3) Massing and Setbacks, 4) Historic & Heritage Preservation, and 5) Circulation and Connections. The Design Review Checklist is enclosed to help guide the DRC in reviewing the standard applicable specific design review principles and guidelines.

Recommendation

That the Design Review Committee reviews the submitted materials, deliberates, and forwards a recommendation to the Director for a final decision.



DESIGN REVIEW NARRATIVE

SAMSON SPORTS NEW BUILDING

4325 NW Lake Road. Camas, Wa 98607

Presented to: City
of Camas

Community Development Department 616
N.E. 4th Avenue
Camas, WA 98607

Prepared by: Brian Groth (360) 567-9470 ccswsolutions@gmail.com



PROJECT INFORMATION FOR SAMSON SPORTS NEW BUILDING

GENERAL INFORMATION

Applicant: Mason Sports LLC 4325

NW Lake Road Camas,

WA 98607

(360) 833-2507

Request: Design Review Approval

Location: The site is located on the North side of NW Lake Rd. a

few parcels West of NW Payne St. Located in the SW 1/4 of Section 28, Township 2N, Range 3E of the Willamette

Meridian.

Zoning: RC (Regional Commercial)

Site Size: 286,625 sf (6.58 acres)

PROJECT DESCRIPTION AND LOCATION

The applicant is proposing a new manufacturing building of approximately 9,427 s.f. to be constructed on the North side of Future Road B with on-site parking for 24 cars. The existing parcel is on the North side of NW Lake Road and a few parcels West of NW Payne Street. The proposed development requires Design Review approval to insure compliance with applicable development standards. The project is also proposing to divide the existing site into 5 parcels through the Binding Site Plan. The Binding Site Plan will place the two existing buildings and parking two on two of the new lots. The new building proposed with this development will be located on another of the two new lots. Two additional lots will be located to the north of the proposed building for purposes of future development. This project does not propose any grading or construction on the northern two lots.

SITE CHARACTERISTICS

<u>Current Conditions</u>: The site area proposed for development is currently undeveloped and sits on the North side of the two existing Samson Sports buildings. The site moderately slopes from the SE corner down to the NW corner. An existing



curb-cut is located on NW Lake Road to the South.

The area surrounding the site is best characterized by noting it is an area in transition. To the South are the two existing Samson Sports Buildings and the land on the remaining three sides is vacant land zoned RC. Currently this area is transitioning from rural housing to light industrial/commercial uses.

ZONING

The applicant is proposing a new two-story manufacturing building of approx. 9,427 s.f. with on-site parking for 24 cars. The on-site parking will include 18 standard stalls, 5 compact stalls, and 1 van accessible handicap stalls.

Hours of operation for the new addition will be from 7:00 AM to 6:00 PM Monday thru Saturday. Deliveries will occur in the morning hours.

Proposed construction schedule is to start in the Summer / Fall of 2019.

ROADS

The site is currently served by one full access curb-cut. An existing curb and sidewalk are in place along NW Lake road. The owner proposes to add a full access curb-cut to the proposed future road on the South end of this development parcel.

SEWER, WATER and STORM DRAINAGE

The site is currently served by the Camas sewer and water district. The new impervious surface area will be serviced by a new on-site water filtration system as per City of Camas standards.

FIRE

The project is located in the Camas/Washougal Fire District. A new on-site fire hydrant is proposed, and adequate fire apparatus circulation is provided.

BINDING SITE PLAN - CMC 17.15.030.D

The Applicant is proposing to divide the subject parcel into 5 lots via the Binding Site Plan Process.

1. Prior to approval of any binding site plan, the community development director shall insure that the following improvements are provided to sufficiently service the anticipated uses throughout the proposed plan and



meet the following decision criteria:

a. Provisions have been made for water, storm drainage, erosion control and sanitary sewer disposal that are consistent with the Camas Design Standard Manual and other state adopted standards and plans;

Response: The Proposed Development Plans and Technical Information provide information and design elements that adequately address these items and prove that the proposal is feasible.

b. Provisions for road, utilities, street lighting, street trees, access to off-street parking and loading and other improvements consistent with the six-year street plan, the Camas Design Standard Manual and other state adopted standards and plans;

Response: No roads are proposed with this development. Utilities will be extended to and thru the site, the final engineering process will address these items. No street lighting is proposed, onsite lighting will be provided and designed with the final engineering process. Landscap- ing, which provides frontage trees and ground cover is provided in the preliminary land- scaping plan. The site proposes off street parking and loading to meet CMC 18.11.

c. Street signs must be in place, fire apparatus access complete to most current adopted Inter- national Fire Code standards, and fire hydrants shall be flow tested by a Washington State licensed fire sprinkler contractor. Flow test results shall be submitted to the fire department. Fire hydrant locations shall be verified by the fire department;

Response: The proposed development will install required signage per the final engineering review process. Fire apparatus access and infrastructure will be design, constructed and installed as directed by the City Fire Marshal.

d. Provisions have been made for all public dedications, and/or easements; and

Response: The Proposed Development is not making any public dedications. Easements will be pro- vided to the City for access, inspection and maintenance at time of Final Engineering.

e. Monumentation of all exterior site corners.

Response: At time of final plat all site corners will have monumentation installed.

2. The site is zoned commercial or industrial and meets the definition of an integrated site.

Response: The site is Zoned Regional Commercial.

3. Appropriate easements and maintenance agreements for shared facilities,



including but not lim- ited to, circulation, parking, utilities and landscaping, have been provided.

Response: Provided at final BSP, Final Site Plan and Final Engineering.

4. When taken as a whole, and not considering any interior lot lines, the integrated site meets all the zoning and subdivision requirements.

Response: The site as a whole meets all zoning and subdivision requirements.

5. Modifications to the minimum zoning standards for individual lots located within the integrated site, including setbacks, parking, landscaping, lot area and lot dimension are not detrimental to the public health, safety and welfare, do not adversely affect the rest of the integrated site or other properties in the vicinity.

Response: This proposed project is not detrimental to any of the above listed items.

6. Common improvements necessary to serve any particular phase of development must be suffi- cient for meeting the zoning and subdivision requirements for that phase.

Response: The proposed project is not being phased at this time.

7. The circulation system incorporates appropriate provisions for safe pedestrian activity to the site from the street, and from building to building within the site.

Response: The proposed project provides circulation and safe pedestrian access in line with the type of development and similar to adjacently approved projects such as Dwyer Creek Business Park.

8. The sign regulations shall be applied to the integrated site as a whole. For example, the number of freestanding signs allowed is based on one site within the binding site plan. Individual owner- ship within the integrated site are not considered to be separate sites in determining the number of freestanding signs allowed.

Response: Provided at final BSP, Site Plan and Engineering.

9. Comply with yard requirements of the most current adopted International Building Code.

Response: No "Yards" are proposed.

CRITERIA FOR APPROVAL.

The city shall consider approval of the site plans with specific attention to the following:



A. Compatibility with the city's comprehensive plan;

Response: The proposed commercial use of this site meets the intent of the

comprehensive plan by retaining the sites use as commercial and

developing the site out for commercial use.

B. Compliance with all applicable design and development standards contained in this title and other applicable regulations;

Response: The proposal meets the applicable design and development

standards as outlined, see prior narrative dialogue and proposed

development plans.

C. Availability and accessibility of adequate public services such as roads, sanitary and storm sewer, and water to serve the site at the time development is to occur, unless otherwise provided for by the applicable regulations;

Response: Services are available and adequate to serve the proposed development,

see prior narrative dialogue and proposed development plans.

D. Adequate provisions are made for other public and private services and utilities, parks and trails (e.g., provide copies of private covenant documents);

Response: Services are available and adequate to serve the proposed development,

see prior narrative dialogue and proposed development plans. No Parks

and Trails are proposed nor required.

E. Adequate provisions are made for maintenance of public utilities; and

Response: Onsite utilities are private.

F. All relevant statutory codes, regulations, ordinances and compliance with the same. The review and decision of the city shall be in accordance with the provisions of CMC Chapter 18.55 Administration and Procedures.

Response: The proposal qualifies for a Type II Review and Approval therefore the

approval shall follow approval procedures as outlined in CMC 18.55.

SUMMARY

The proposed development is in the public interest because it complies with the comprehensive plan policies promoting economic development. It also complies with zoning and development codes insuring compatibility with surrounding uses. Among the design principals incorporated into this project are the following:

Onsite parking is placed on the interior of the development around the new manufacturing building. The nature of the manufacturing process requires multiple



full-sized overhead door access on both the East and West side of the building. This requires placing the building in the middle of the site to allow for functional circulation. This also provides maximum fire apparatus circulation around the entire structure. Although manufacturing buildings are typically large square boxes, a great deal of attention has been placed on designing this building to have street appeal. The most visible elevation of this building will be to the South. On the south side the office area has been designed to look more like a commercial office building. This area protrudes out from the manufacturing warehouse portion of the building and is highlighted by a curved/segmented oversized window system above the entry below. In addition to the office area, the exterior of the manufacturing/warehouse façade has been designed to break-up large wall areas into smaller, more interesting segments. This will be accomplished by using stone veneer wainscoting, synthetic stucco and multiple metal panels of differing vertical/horizontal orientation and color. The exterior overhead doors will have full glass panels which will not only improve the interior environment but will also add to the exterior elevation relief along with upper windows to break up the wall area. Overall the exterior design will help define the streetscape by showing a great deal of visual interest.

The surrounding zones are of equal or like uses however the new building does mitigate size and scale differences with its exterior elevation scheme.

The new building should seamlessly integrate with the surrounding development uses which appear to be large industrial/commercial buildings with large facades which are also broken-up with visual relief designs.


Proposed landscaping comprises of native NW vegetation and makes use of mostly evergreen shrubs that will maintain year around color and will be hardy with low maintenance.

Trees will be planted as per City of Camas standards.

Landscape islands are placed between parking stall groupings where possible and one tree per every three stalls will be planted in the parking and adjacent landscape areas around the building.

The total landscape area of the new development site is approximately 11.5% of the total site area. This will also contribute to minimizing the scale of the new building and to the visual appearance from the surrounding parcels.

Any on-site lighting will be screened from adjacent properties.

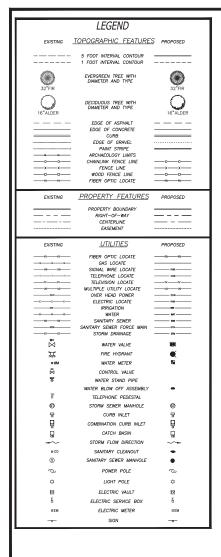

SAMSON SPORTS

DESIGN REVIEW PLANS


PARCEL #175935-000 IN A PORTION OF THE SW 1/4 OF SECTION 28 T 2 N, R 3 E, W.M. CAMAS, WASHINGTON

APPLICANT/OWNER:

SAMSON SPORTS 4327 NW LAKE RD. CAMAS, WA 98607 PHONE: (360) 833-2507 ENGINEERING FIRM:


BSG DESIGN, LLC 3538 S. 3RD WAY RIDGEFIELD, WA 98642 CONTACT PERSON: BRIAN GROTH PHONE: (360) 567-9470 PARCEL INFORMATION:

PARCEL # 175935-000 PARCEL AREA: 6.58 ACRES ZONED: RC

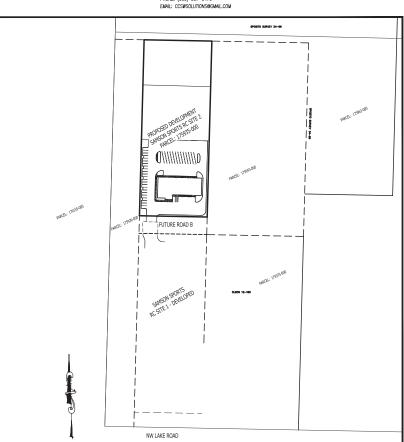

SITE MAP

1" = 100'

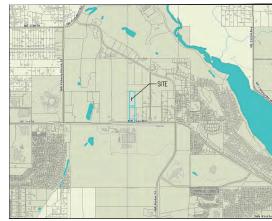

VICINITY MAP

SHEET INDEX

 SHEET NUMBER
 SHEET TITLE

 PDO
 CDVER SHEET

 P2D
 SITE PLAN - GVERALL

 DR1
 MAIN LEVEL FLOOR PLAN

 DR2
 UPPER LEVEL FLOOR PLAN

 DR3
 EAST AND SOUTH ELEVATION

 P50
 WEST AND NORTH ELEVATION

00 LANDSCAPE PLAN

DESCRIPTION ENGINEERIN

SAMSON SPORTS
REGIONAL COMMERCIAL SITE 2

GOVER SHEET



SHEET POO






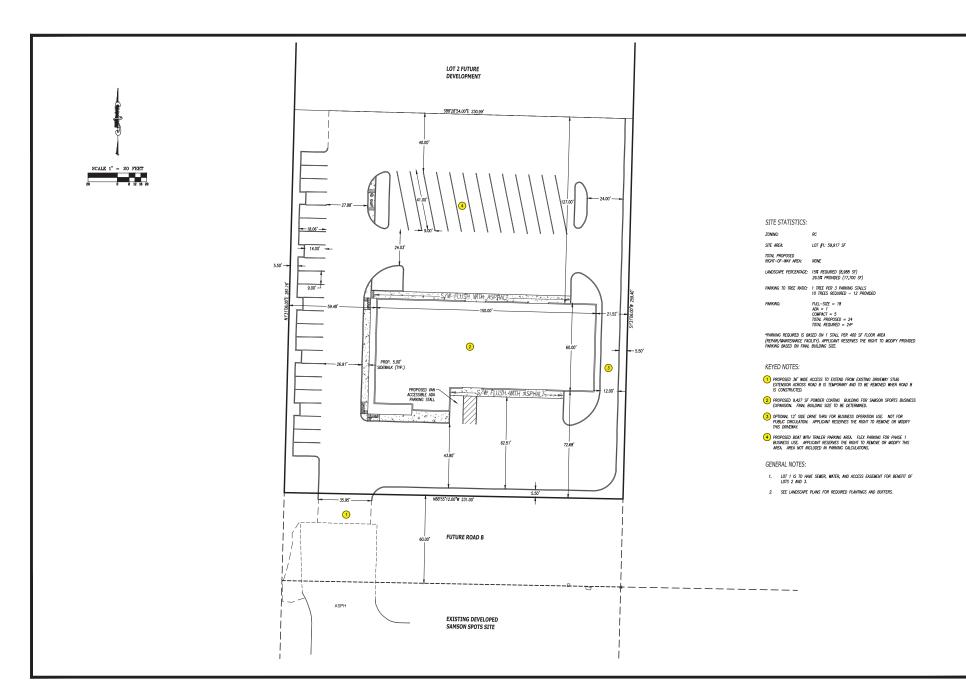



Exhibit 3 DR18-10

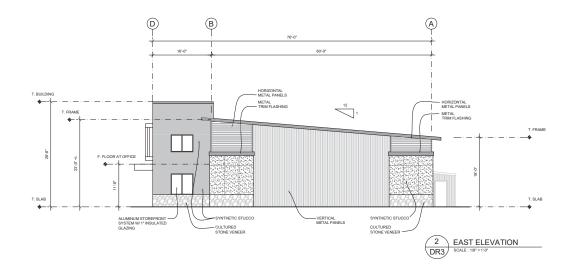

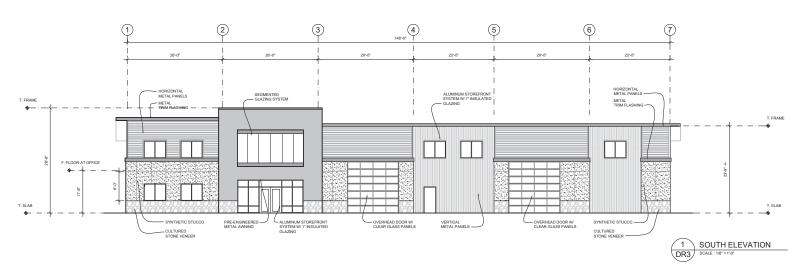



JOB NUMBER: 18-357 DRAWN BY: MJB SHEET TITLE: EXTERIOR ELEVATIONS	SAMSON SPORTS PHASE II 4325 NW LAKE ROAD CAMAS, WA 98607	ARCHITECTURE 1115 ESTHER STREET, SUITE B VANCOUVER WA 98660	DF	R 3
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JOB NUMBER: 18-357	DATE: 9-17-2018 REVISIONS:	SAMSON SPORTS	■ IIR	SHEET NUMBER:
DRAWN BY: MJB SHEET TITLE:	-	PHASE II	ARCHITECTURE	DR 4
EXTERIOR ELEVATIONS		4325 NW LAKE ROAD CAMAS, WA 98607	1115 ESTHER STREET, SUITE B VANCOUVER, WA 98660	

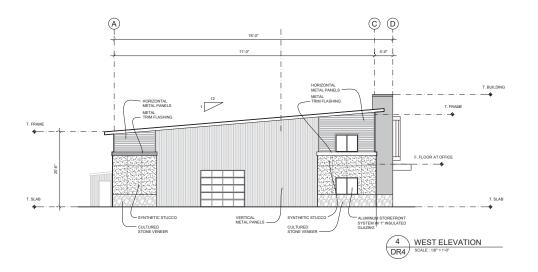

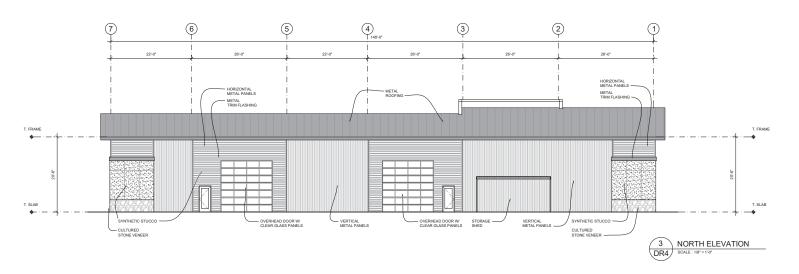

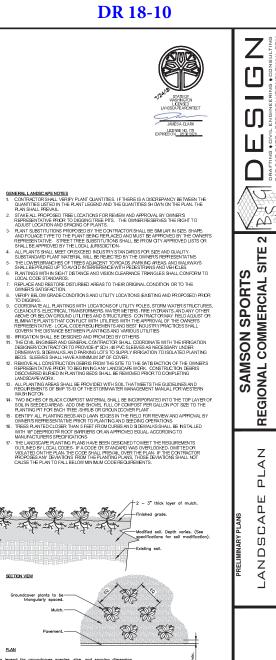

BOTANICAL NAME / COMMON NAME

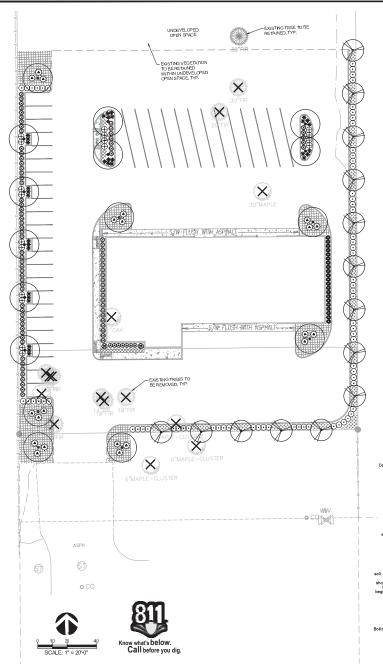TREES

			_		
	Caminus betulus 'Franz Fontaine' / Franz Fontaine Hombeam or Approved Equal	B & B	2"cal	30° o.c.	14
•	Crataegus x lexellei / Hawthorn or Approved Equal	B & B	2"cal	as shown	16
SHRUBS	BOTANICAL NAME / COMMON NAME	CONTAINER	SPREAD	SPACING	QTY
•	Comus aba 'Begantissima' / Silveredga Dogwood or Approved Equal	5 gal	18"-24"	5° o.c.	21
●	Pieris japonica 'Mountain Fire' / Mountain Fire Pieris or Approved Equal	5 gal	15"-18"	4° o.c.	2
•	Prunus laurocerasus "Otto Luyken" / Luykens Laurel or Approved Equal	5 gal	15"48"	4° o.c.	70
⊗	Spireas japonica "Double Play Gold" / Spirea "Double Play Gold" or Approved Equal	5 gal	15"-18"	3, 0.0	7
\oplus	Spireea x burnelda 'Goldflame' / Goldflame Spirea or Approved Equal	5 gal	15"-18"	4° o.c.	18
GRASSES	BOTANICAL NAME / COMMON NAME	CONTAINER	SPREAD	SPACING	QTY
٠	Calamagrostis x acutiflora 'Avalanche' / Feather Reed Grass or Approved Equal	5 gal	18"-24"	3.5° o.c.	85
۰	Carex oshimensis "Everoro" / Everoro Japanese Sedge or Approved Equal	1 gal	10"-12"	3, 0.0	21
*	Pennisetum alopecuroides "Hameln" / Hameln Dwarf Fountain Grass or Approved Equal	1 gal	10"-12"	3, 0.0	33
GROUND COVERS	BOTANICAL NAME / COMMON NAME	CONTAINER	SPREAD	SPACING	QTY
	Ajuga reptans / Carpet Bugle or Approved Equal	1 gal	6"42"	18° o.c.	54
	Cotoneaster dammer i "Coral Beauty" / Bearberry Cotoneaster or Approved Equal	1 gal	6"42"	4° o.c.	62
	Fragaria chiloensis / Beach Strawberry or Approved Equal	1 gal	6"-12"	4° o.c.	155

CONTAINER SIZE

SPACING QTY

Central leader. (See crown observations detail). -Prior to mulching, lightly tamp soil around the root ball in 6° lifts to brace tree. Do not over compact. When the planting hole has been backfilled, pour water around the root ball to settle the soil. Trunk caliper shall meet ANSI Z60 current edition for root ball size. further requirement ed to this detail. URBAN TREE FOUNDATION TREE W/ BERM (EXISTING SOIL NOT MODIFIED) OPEN SOURCE FREE TO USE FX-PL-FX-TREE-06

GROUNDCOVER

PLAN

SECTION VIEW

Groundcover plants to be triangularly spaced


In-See planting legend for groundcover species, size, and spacing dimension.

2- Small roots (\$\hat{\chi}\$ or less) that grow around, up, or down the root ball periphery normal constition in container production and are acceptable however they should be time of planting, Roots on the periperty can be removed at the time of planting, root and or acceptable however prior to muching.


2 3/4" = 1'-0" URBAN TREE FOUNDATION © 2014 OPEN SOURCE FREE TO USE

CITY OF CAMAS, WA

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JOB NUMBER: 18-357	DATE: 9-17-2018 REVISIONS:	SAMSON SPORTS	BIIR	SHEET NUMBER:
DRAWN BY: MJB SHEET TITLE:		PHASE II 4325 NW LAKE ROAD	ARCHITECTURE	DR 1
MAIN LEVEL FLOOR PLAN		CAMAS, WA 98607	1115 ESTHER STREET, SUITE B VANCOUVER, WA 98660	

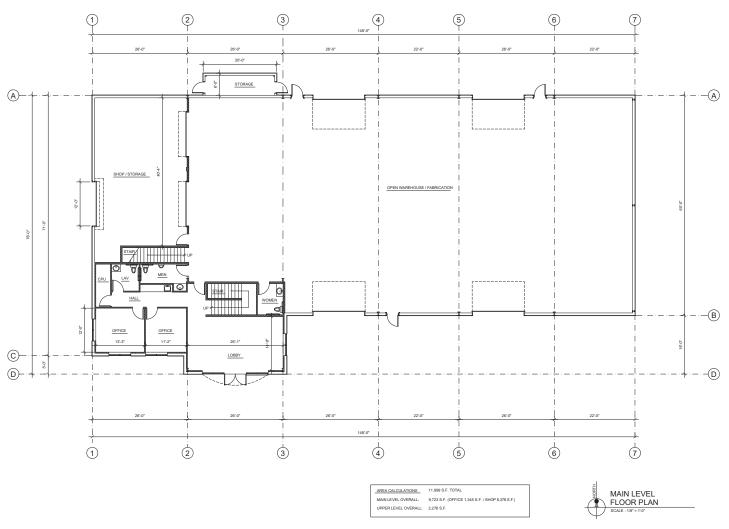


JOB NUMBER: 18-357	DATE: SEPT. 2018 REVISIONS:	SAMSON SPORTS
DRAWN BY: MJB		PHASE II
SHEET TITLE: UPPER LEVEL FLOOR PLAN		4325 NW LAKE ROAD CAMAS, WA 98607

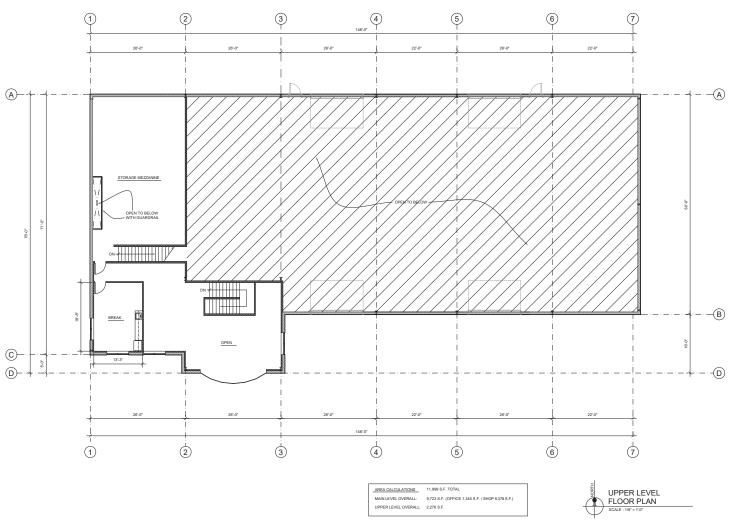

DR 2

SHEET NUMBER:

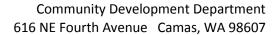



Design Review Checklist Samson Sports Expansion (DR18-10)

The purpose of this sheet is to provide a simplified and expedited review of the design review principles and guidelines using objective review standards. The standards are intended as tool for the decision-maker in making findings that the proposal either achieves compliance with the intent of the principles or reasonably mitigates any conflict. When reviewing the check sheet, the proposal should as a whole "comply" with the standards and thus be generally consistent with the overriding principles. [Yes = In Compliance; No = Not In Compliance; NA = Not Applicable]

Standard Principles and Guidelines

ARCH	HITECT	URE		
Yes	No	NA	Principles and Guidelines	Comments
			Corrugated materials, standing seam, T-1 11, or similar	
			siding materials are avoided unless it produces a high	
			visual (or aesthetic) quality.	
			Buildings walls or fences visible from roadways are	
			articulated in order to avoid a blank look.	
			The use of bold colors has been avoided unless used as	
			minor accents.	
			Higher density/larger structures abutting lower density	
			residential structures have been designed to mitigate	
			size and scale differences.	
LAND	SCAPI	ING AI	ND SCREENING	
Yes	No	NA	Principles and Guidelines	Comments
			Vegetation for landscaping includes native, low	
			maintenance plantings. Significant trees are retained if	
			feasible.	
			Trees planted along streetscapes with overhead power	
			lines include only those trees identified on the City's	
			Tree list.	
			Landscaping, including trees, shrubs, and vegetative	

			project promote the historic heritage of the site or surrounding area.	
 -			names, architectural features, or other elements of the	
	140	117	The use of Historic Markers, information kiosks, project	Comments
Yes	No	NA	Principles and Guidelines	Comments
HISTO	ORIC A	ND HE	ERITAGE PRESERVATION	
			retained.	
			Rock outcropping's, forested areas and water bodies are	
			are retained and incorporated into the landscape plan.	
			Existing trees over 6" dbh that are not required to be removed to accommodate the proposed development	
			overall project design.	
ļ			Outdoor furniture samples are consistent with the	
			shielding, siting and/or landscaping.	
ļ			surrounding properties through the use of hooding,	
,			Parking and building lighting is directed away from	
			City approved street lighting plans for the street.	
			existing on the same street and do not conflict with any	
 -			architecturally more significant than other street lighting	
			Street lighting (poles, lamps) is substantially similar or	
			neighboring properties.	
			Landscape lighting - low voltage, non-glare, indirect lighting is directed, hooded or shielded away from	
			illuminated they are front lit.	
			landscaping are unobtrusive and vandal resistant. If	
ļ			Signs located on buildings or incorporated into the	
			as to have little or no visual impact.	
			Proposed fencing is incorporated into the landscaping so	
ļ			parking.	
			groundcover, is provided to visually screen and buffer the use from adjoining less intense uses including	

Specific Principles and Guidelines

	COMMERCIAL & MIXED USES						
ARCH	ARCHITECTURE						
Yes	No	NA	Principles and Guidelines	Comments			
			Office and retail buildings provide a minimum solid to				
			void ratio of 60%/40%				
			The development is built with a residential feel (i.e. size,				
			scale, and materials compatible with neighboring				
			buildings) if surrounded by residential areas or adjacent				
			to residentially zoned properties.				
			Buildings over two stories have the third story and above				
			offset from the first two stories, if surrounding				
			developments are less than three stories or land use				
			designations on adjacent zones do not allow more than				
			three story development.				
LAND	LANDSCAPING & SCREENING						
Yes	No	NA	Principles and Guidelines	Comments			
			Intersections are illuminated, but not dominated by				
			lighting. Lighting is incorporated into the landscape and				
			illuminates the quality of the natural environment.				
			Street light poles and lamps are compatible with other				
			nearby lighting on the same street.				
			Parking spaces are clustered in small groupings and				
			separated by landscaping to create a pedestrian friendly,				
			park like environment.				
	ETSCA	1					
Yes	No	NA	Principles and Guidelines	Comments			
			On-site parking areas are located to the interior of the				
			development unless site development proved				
			prohibitive.				
			Parking areas are screened with landscaping.				
			Buildings are placed close to streets and roads unless site				
			constraints made it impossible or characteristics of the				
			surrounding properties already developed made it				

incompatible. Otherwise, retail frontage setbacks do not exceed 25 feet from back of curb.	
Window and door placement provides a high degree of transparency at the lower levels of the building and maximize visibility of pedestrian active uses.	
Each use/activity in a development containing multiple uses/activities is integrated in a manner that achieves a seamless appearance or creates a cohesive development.	
Watering system will maintain proposed landscaping for a period to ensure that plants are well established.	Note: Drought tolerant plants need at least 1-2 years of irrigation to be established.
New streets intersecting commercial properties are designed to create a safe environment. "Coving" techniques and "round-a-bouts" were considered for traffic calming when appropriate.	