

DESIGN REVIEW COMMITTEE MEETING AGENDA Wednesday, December 18, 2019, 4:00 PM City Hall, 616 NE 4th Avenue

I. CALL TO ORDER

II. ROLL CALL / INTRODUCTIONS

III. MEETING ITEMS

- A. Design Review for Kiddie Academy (DR19-12)
 Presenter: Lauren Hollenbeck, Senior Planner
 - Kiddie Academy Staff Report (DR19-12)
 - 1 Checklist
 - 2 Applicant's Narrative
 - 3 Existing Conditions
 - 4 Elevations
 - 5 Floorplan
 - 6 Landscape Plan
 - 7 Site Plan
 - 8 Grading Plan
 - 9 Site Plan
- B. Design Review for Vutukuri Duplex (DR19-08)
 - Vutukuri Duplex Staff Report (DR19-08)
 - 1 Checklist
 - 2 Applicant's Narrative
 - 3 Vicinity Map
 - 4 Site Plan
 - 5 Landscape Plan
 - 6 Floor Plan and Elevations

IV. ADJOURNMENT

NOTE: The City of Camas welcomes and encourages the participation of all of its citizens in the public meeting process. A special effort will be made to ensure that persons with special needs have opportunities to participate. For more information, please call the City Clerk's Office at 360.817.1591.



STAFF REPORT

Kiddie Academy

Major Design Review (DR19-12)

Relates Files: SPRV19-05

<u>TO</u> Design Review Committee

FROM Lauren Hollenbeck, Senior Planner

LOCATION NW Brady Road and NW 20th Avenue

Parcel No. 98603891

<u>APPLICANT</u> CIDA Inc., Mel Delahoz

15895 SE 72nd Ave, Suite 200

Portland, OR 97224

APPLICABLE LAW: The application was submitted on 10/14/19 and the applicable codes are those codes that were in effect at the date of application. Camas Municipal Code (CMC) Title 17 Land Development and Title 18, specifically (but not limited to): Chapter 18.11 - Parking, Chapter 18.13 - Landscaping, Chapter 18.18 - Site Plan Review, Chapter 18.19 Design Review, and Chapter 18.55 Administrative Procedures.

Summary

The applicant is currently seeking design review approval for the construction of a 10, 950 square foot day care facility with outdoor playground areas. The site fronts on the corner of NW Brady Road and NW 20th Avenue. Vehicular access to the site is provided off of NW 20th Ave west of the building. Landscaping is focused at the perimeter of the site.

The Parker Village subdivision is located south of the project site. The entire site is zoned Community Commercial. The site slopes downwards to the northwest corner of the site and is primarily grass.

Purpose

Design Review is required under CMC Chapter 18.19. Design review is not intended to determine the appropriate use on a parcel but rather review a proposed development for compliance with City codes and plans related to landscaping, architectural elevations and other elements relative to required improvements. The recommendations from the Design Review Committee (DRC) must consider the design review standards from the Downtown Design Review Manual. An enclosed checklist is to help guide you in your review but refer to the manual for specific details regarding the standards.

Standard and Commercial & Mixed Uses Design Principles and Guidelines

The standard and commercial & mixed use principles are required and must be demonstrated to have been satisfied in overall intent for design review approval. The standard design guidelines are developed to assist a project in meeting the established principles and each guideline should be adequately addressed. If the proposal cannot meet a specific guideline, then an explanation should be

provided by the applicant as to why and how it will be mitigated to satisfy the intent of the design principles. The development guidelines include five major categories: 1) Landscaping and Screening, 2) Architecture, 3) Massing and Setbacks, 4) Historic & Heritage Preservation, and 5) Circulation and Connections. The Design Review Checklist is enclosed to help guide the DRC in reviewing the standard applicable specific design review principles and guidelines.

Recommendation

That the Design Review Committee reviews the submitted materials, deliberates, and forwards a recommendation to staff for a final decision.



Design Review Checklist Kiddie Academy (DR19-12)

The purpose of this sheet is to provide a simplified and expedited review of the design review principles and guidelines using objective review standards. The standards are intended as tool for the decision-maker in making findings that the proposal either achieves compliance with the intent of the principles or reasonably mitigates any conflict. When reviewing the check sheet, the proposal should as a whole "comply" with the standards and thus be generally consistent with the overriding principles. [Yes = In Compliance; No = Not In Compliance; NA = Not Applicable]

Standard Principles and Guidelines

ARCH	HITECT	URE		
Yes	No	NA	Principles and Guidelines	Comments
			Corrugated materials, standing seam, T-1 11, or similar	
			siding materials are avoided unless it produces a high	
			visual (or aesthetic) quality.	
			Buildings walls or fences visible from roadways are	
			articulated in order to avoid a blank look.	
			The use of bold colors has been avoided unless used as	
			minor accents.	
			Higher density/larger structures abutting lower density	
			residential structures have been designed to mitigate	
			size and scale differences.	
LAND	SCAP	ING AI	ND SCREENING	
Yes	No	NA	Principles and Guidelines	Comments
			Vegetation for landscaping includes native, low	
			maintenance plantings. Significant trees are retained if	
			feasible.	
			Trees planted along streetscapes with overhead power	
			lines include only those trees identified on the City's	
			Tree list.	

			Landscaping including trace should and usestable	
			Landscaping, including trees, shrubs, and vegetative	
			groundcover, is provided to visually screen and buffer	
			the use from adjoining less intense uses including	
			parking.	
			Proposed fencing is incorporated into the landscaping so	
			as to have little or no visual impact.	
			Signs located on buildings or incorporated into the	
			landscaping are unobtrusive and vandal resistant. If	
			illuminated they are front lit.	
			Landscape lighting - low voltage, non-glare, indirect	
			lighting is directed, hooded or shielded away from	
			neighboring properties.	
			Street lighting (poles, lamps) is substantially similar or	
			architecturally more significant than other street lighting	
			existing on the same street and do not conflict with any	
			City approved street lighting plans for the street.	
			Parking and building lighting is directed away from	
			surrounding properties through the use of hooding,	
			shielding, siting and/or landscaping.	
			Outdoor furniture samples are consistent with the	
			overall project design.	
			Existing trees over 6" dbh that are not required to be	
			removed to accommodate the proposed development	
			are retained and incorporated into the landscape plan.	
			Rock outcropping's, forested areas and water bodies are	
			retained.	
HISTO	ORIC A	ND H	ERITAGE PRESERVATION	
Yes	No	NA	Principles and Guidelines	Comments
			The use of Historic Markers, information kiosks, project	
			names, architectural features, or other elements of the	
			project promote the historic heritage of the site or	
			surrounding area.	

Specific Principles and Guidelines

	COMMERCIAL & MIXED USES				
ARCH	ARCHITECTURE				
Yes	No	NA	Principles and Guidelines	Comments	
			Office and retail buildings provide a minimum solid to		
			void ratio of 60%/40%		
			The development is built with a residential feel (i.e. size,		
			scale, and materials compatible with neighboring		
			buildings) if surrounded by residential areas or adjacent		
			to residentially zoned properties.		
			Buildings over two stories have the third story and above		
			offset from the first two stories, if surrounding		
			developments are less than three stories or land use		
			designations on adjacent zones do not allow more than		
			three story development.		
LAND	SCAPI	NG &	SCREENING		
Yes	No	NA	Principles and Guidelines	Comments	
			Intersections are illuminated, but not dominated by		
			lighting. Lighting is incorporated into the landscape and		
			illuminates the quality of the natural environment.		
			Street light poles and lamps are compatible with other		
			nearby lighting on the same street.		
			Parking spaces are clustered in small groupings and		
			separated by landscaping to create a pedestrian friendly,		
			park like environment.		
	ETSCA				
Yes	No	NA	Principles and Guidelines	Comments	
			On-site parking areas are located to the interior of the		
			development unless site development proved		
			prohibitive.		
			Parking areas are screened with landscaping.		
			Buildings are placed close to streets and roads unless site		
			constraints made it impossible or characteristics of the		
			surrounding properties already developed made it		

incompatible. Otherwise, retail frontage setbacks do not exceed 25 feet from back of curb.	
Window and door placement provides a high degree of transparency at the lower levels of the building and maximize visibility of pedestrian active uses.	
Each use/activity in a development containing multiple uses/activities is integrated in a manner that achieves a seamless appearance or creates a cohesive development.	
Watering system will maintain proposed landscaping for a period to ensure that plants are well established.	
New streets intersecting commercial properties are designed to create a safe environment. "Coving" techniques and "round-a-bouts" were considered for traffic calming when appropriate.	

SECTION II

Narrative: Camas Municipal Code 18.19.050

18.19.050 - Design principles.

The principles as provided in the DDM or DRM are mandatory and must be demonstrated to have been satisfied in overall intent in order for approval of a design review application to be granted. Standard principles shall apply to all commercial, mixed use, or multifamily uses. Specific principles are used in addition to the standard principles for gateways and corridors, commercial, mixed uses, and multifamily (e.g. apartments, townhouses, duplexes).

A. Standard Principles.

I. Landscaping shall be done with a purpose. It shall be used as a tool to integrate the proposed development into the surrounding environment.

Response: The proposed landscaping is a mix of deciduous and evergreen trees and shrubs with the intent of beatifying the development. Emphasis is placed on screening the existing retaining wall at the entrance to the development and along Brady Road with a mix of evergreen trees and shrubs.

2. All attempts shall be made at minimizing the removal of significant natural features. Significant natural features shall be integrated into the overall site plan.

Response: No significant natural features on site.

3. Buildings shall have a "finished" look. Any use of panelized materials shall be integrated into the development in a manner that achieves a seamless appearance.

Response: The building façade materials have been selected internationally as high-image architectural cladding. The proposed primary exterior cladding system will be a mix of Pre-finished Box Rib Metal Siding, and Pre-finished Flat Panel Metal Siding. The color and profiles have been chosen to compliment the surrounding buildings. Shiplap Hardie siding with an Architectural Concrete Masonry Unit Veneer wainscot are also used to further blend the surrounding architecture.

4. A proposed development shall attempt to incorporate or enhance historic/heritage elements related to the specific site or surrounding area.

Response: No historic/heritage elements currently exist in the specific site or surrounding area.

B. Specific Principles.

Gateways.

Response: Not applicable to proposed site.

- a. Gateways shall be devoid of freestanding signs. Preexisting freestanding signs will be subject to removal at the time of any new development, redevelopment, or major rehabilitation on the site. Exemptions include approved directional or community information signage as approved by the city.
- b. Business signage not placed on buildings shall be integrated into the landscaping/streetscaping of the subject property.
- c. Permanent signage within a gateway shall be standardized in a manner that creates a consistent look within the gateway in question.
- d. The surface of pedestrian walkways within intersections shall be accentuated with a unique character.
- e. A consistent streetscape lighting scheme shall be used.

2. Commercial and Mixed Uses.

a. On-site parking areas shall be placed to the interior of the development unless site development proves prohibitive. All on-site parking areas along adjacent roadways shall be screened with landscaping. Downtown commercial and mixed-use areas shall not be required to provide on-site parking.

Response: Requirement acknowledged. Onsite parking has been provided to the greatest extent feasible and will be screened with landscaping.

b. Buildings shall be used to define the streetscape unless site conditions prove prohibitive.

Response: Requirement acknowledged; the proposed building articulation has been designed to define the streetscape.

c. Structures abutting, located in, or located near less intensive uses or zoned areas (such as commercial developments next to residential areas) shall be designed to mitigate size and scale differences.

Response: Requirement acknowledged. The adjacent residential neighborhood is located at a higher elevation to the proposed project.

The scale and design of the building has been influenced to compliment the surrounding neighborhood.

d. Developments containing a multiple of uses/activities shall integrate each use/activity in a manner that achieves a seamless appearance, or creates a cohesive development.

Response: Requirement acknowledged. Proposed project will only house one occupancy type.

e. Mixed-use developments that place uses throughout the site (horizontal development) shall organize elements in a manner that minimizes their impact on adjacent lower intensity uses.

Response: Requirement acknowledged.

f. Walls shall be broken up to avoid a blank look and to provide a sense of scale.

Response: Requirement acknowledged. The proposed building has changing scales of material to assist with creating a non-monolithic façade.

g. Outdoor lighting shall not be directed off-site.

Response: Requirement acknowledged. Fixtures will be cut-off to eliminate off-site impact.

3. Multifamily.

a. Stacked Housing.

Response: Not applicable to proposed project.

- i. All on-site parking areas shall be screened with landscaping. Parking spaces shall be clustered in small groups of no more than six to ten spaces.
- ii. Stacked houses abutting or located in single-family residentially zoned areas shall be designed to mitigate size and scale differences.
- iii. Walls shall be articulated in order to avoid a blank look and to provide a sense of scale.
- iv. Detached garages shall be located to the rear of stacked unit(s) so as not to be directly viewable from a public street.
- v. Attached garages shall account for less than fifty percent of the front face of the structure. Garages visible from the street shall be articulated by architectural features, such as windows, to avoid a blank look.

b. Townhomes and Rowhouses.

Response: Not applicable to proposed project.


- i. All on-site parking areas (excluding driveways and garages) shall be screened with landscaping.
- ii. Buildings shall be used to define the streetscape unless site conditions prove prohibitive.

- iii. When appropriate, structures abutting or located in single-family residentially zoned areas shall be designed to mitigate size and scale differences.
- iv. Walls shall be articulated in order to avoid a blank look and to provide a sense of scale.
- v. Detached garages shall be located to the rear of the townhouse or rowhouse unit(s) so as not to be directly viewable from a public street.
- vi. Attached garages shall account for less than fifty percent of the front face of the structure. Garages visible from the street shall be articulated by architectural features, such as windows, to avoid a blank look.

c. Duplex, Triplex and Four-Plex.

Response: Not applicable to proposed project.

i. Garages shall account for less than fifty percent of the front face of the structure. Garages visible from the street shall be articulated by architectural features, such as windows, to avoid a blank look.

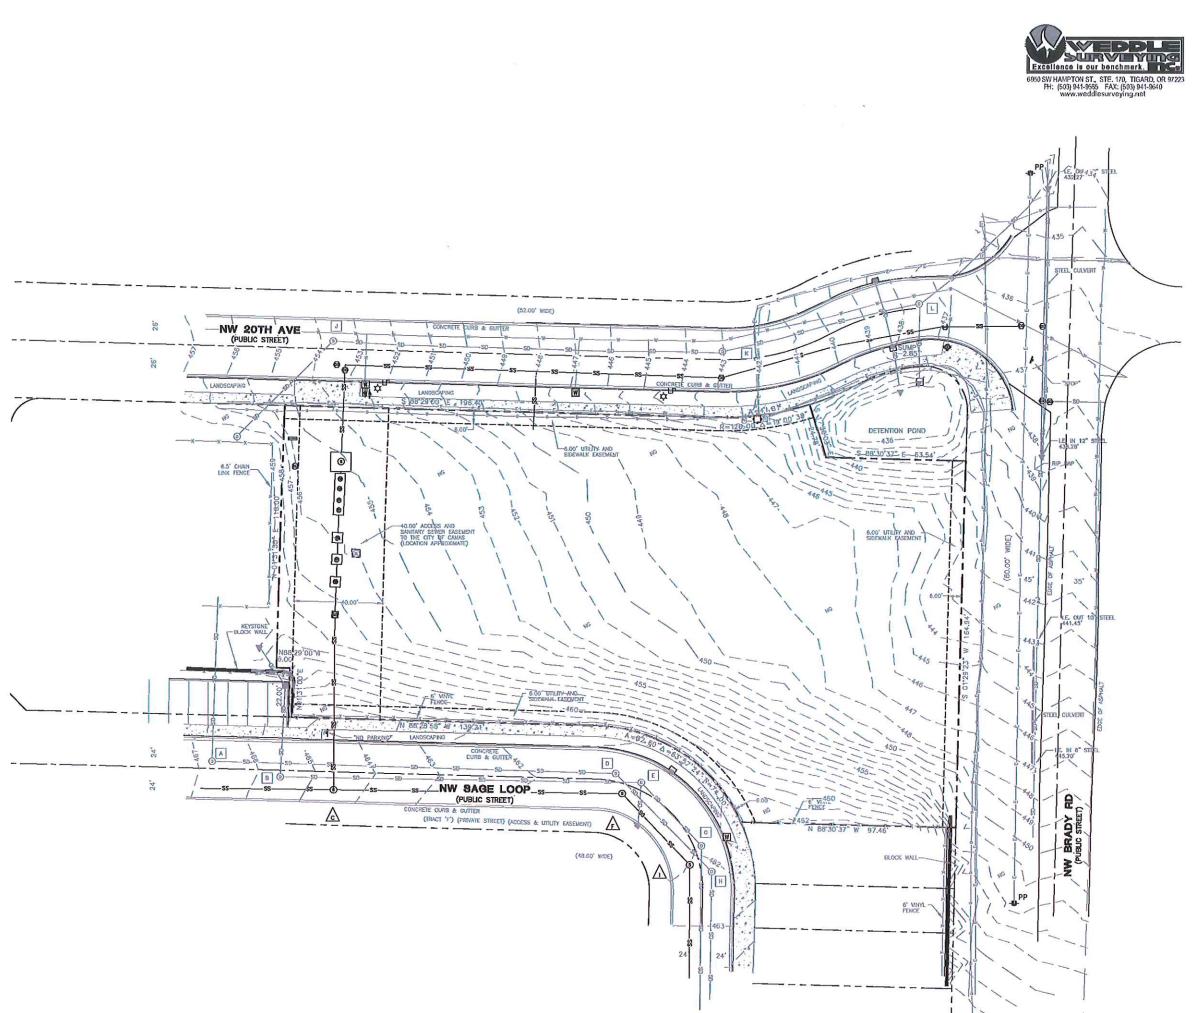



ACCESS LID CATCH BASIN CULVERY INVERT

CURB INLET

ELECTRIC PANEL FIRE HYDRANT

NATURAL GROUND PAD-MOUNTED TRANSFORMER POWER POLE/LIGHT POLE SANITARY LATERAL

SANITARY SEWER WANHOLD SIGN "AS-NOTED" STORM DRAIN MANHOLE WATER METER WATER RISER

> CABLE TV LINE ELECTRIC LINE

FIBER OPTIC LINE GAS LINE SANITARY SEWER LINE STORM DRAIN LINE STREET CENTERLINE

WATER LINE

STORM STRUCTURES


- B RIM ELEV. 485.61' LE. 12' CONC. BN (E) 458.89' LE. 12' CONC. DUT (N) 458.83'
- D RM ELEV. 481.54' LE 12" CONC. BM (E) 455.58' LE 12" CONC. CUT (M) 465.43'
- G RM ELEV. 461.82' IE. 12" CONC. IN (\$) 459.05' IE. 12" CONC. GUT (N#) 457.92'
- H RM ELEV. 462.16' IE 12" CONC. IN (\$) 456.09' IE 12" CONG. OUT (N#) 455.87'
- J RM ELEV. 463.72' IE 12" CONG. IN (SN) 448.17' IE 12" CONC. OUT (E) 448.13'
- K RM ELEV. 443.04' I.E. 12" CONC. IN (N) 436.50' I.E. 12" CONC. OUT (E) 436.78'
- L RM ELEV. 437.58' LE 12" CONC. IN (S) 432.89' LE 12" CONC. IN (W) 432.86' LE 12" CONC. OUT (NE) 432.66'

SANITARY STRUCTURES

C RIM ELEV. — 484.54'
I.E. 10' PVC. DI (W) — 453.78'
I.E. 10' PVC. DI (E) — 453.78'
I.E. 10' PVC. OUT (N) — 453.35'

FINE ELEV. - 461.45'
LE. B' CONC. IN (E) - 454.39'
LE. 8' CONC. OUT (M) - 454.18'

RM ELEV. - 482.01'
I.E. 8' CONC. IN (5) - 454,79'
I.E. 8' CONC. OUT (NW) - 454.87'

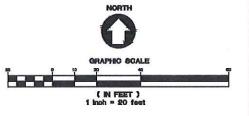



EXCINEERING
1975 SW Giffith Drive | Suffe 300 | Beaverlon, OR | 97005
503 G20 3030 tel | 503 620 5330 fax | www.asleing.com T

CAMAS

ACADEMY KIDDIE

SHEET TITLE EXISTING CONDITIONS


REVISIONS:

DATE: 08/20/2019 DRAWN: CHECKED: NWS

C AN EXPRESSION DIC.

THESE DRAWNOS ARE THE PROPERTY OF AN EXEMPERADO INC. AND ARE MOT TO BE USED OR REPRODUCED IN ANY MANNER, EXCEPT WITH THE PRICE WRITTIN PERSONS OF AN EXPRESSION OF AN SHEET NUMBER

JOB NUMBER: A19133.10

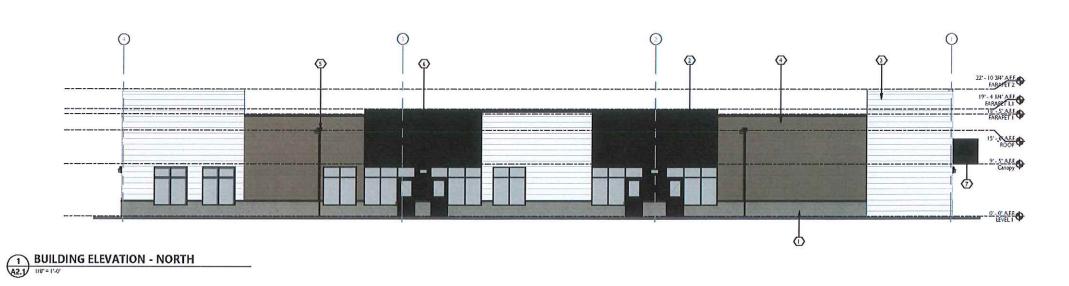



PRELIMINARY PLAN ONLY-NOT FOR CONSTRUCTION

SITE REVIEW DESIGN REVIE


ARCHITECTURE ENGINEERING P L A N N I N G INTERIORS
LANDSCAPE
15895 SW 72ND AVE SUITE 200
PORTLAND, OREGON 97224
IEL: 503.228.1285
FAX: 503.228.1570
WWW.CIDAINC.COM


NEW CONSTRUCTION


KIDDIE ACADEMY-CAMAS PROJECT ADDRESS - CAMAS, WA

ELEVATIONS

A2.1

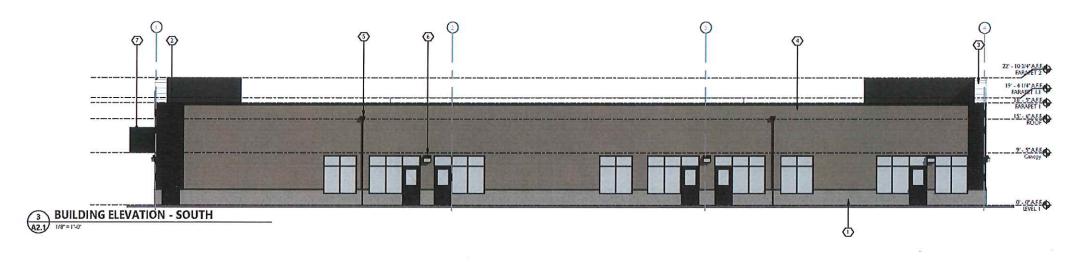


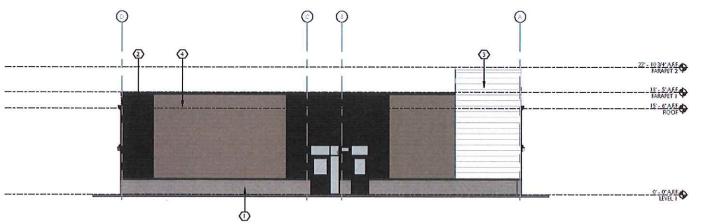

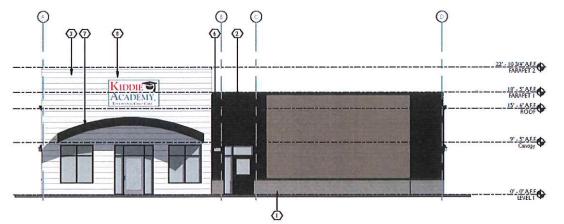

BUILDING ELEVATION - EAST

BUILDING ELEVATION - WEST

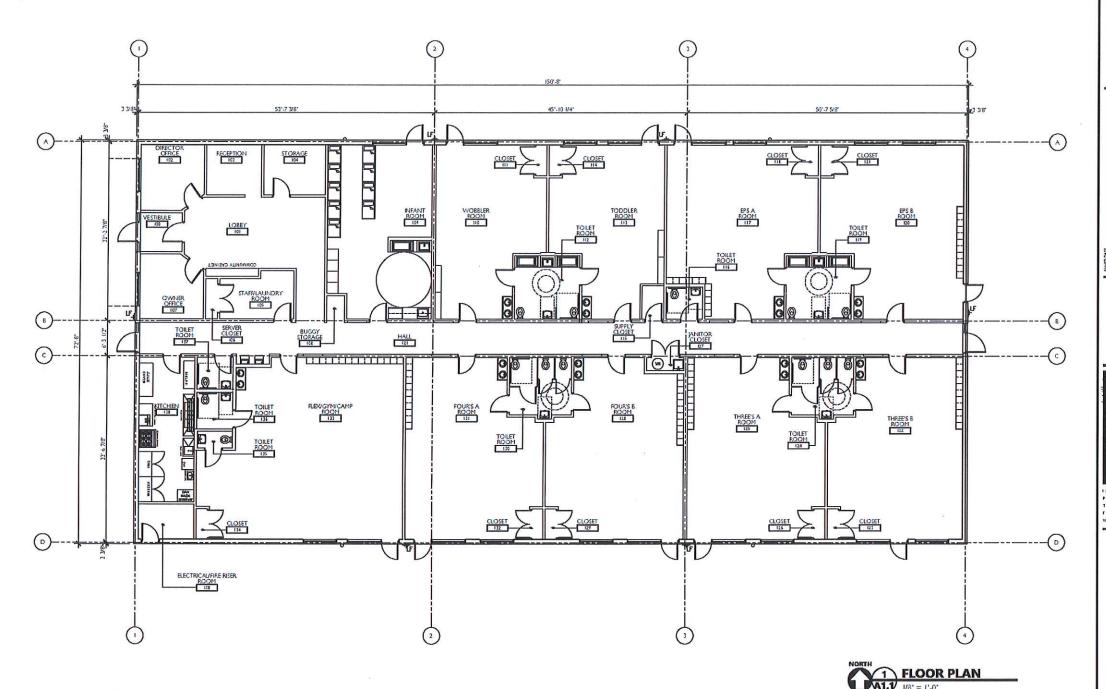

FLOOR PLAN GENERAL NOTES

APPLICABLE CODES: ALL WORK SHALL BE IN CONFORMANCE WITH ALL FEDERAL, STATE, AND LOCAL CODES, SECRICATIONS WID STANDARDS SHALL HEARL AND AGE INTENDED TO BE, THE LATEST EDITION, AMPLIONENT OR FERSION OF SUCH REFERENCE STANDARD IN EFFECT AS OF THE DATE OF THE CONTRACT DOCUMENTS.

CONTRACTOR SHALL COORDINATE ANY NECESSARY TESTING AND INSPECTIONS.

ALL HARDWARE SHALL COMPLY WITH REQUIREMENTS OF THE ADA.

FIRE EXTINGUISHERS SHALL BE LOCATED AS REQUIRED BY SECTION 506, IFC. COORDINATE FINAL LOCATION WITH FIRE MARSHALL.

-GLASS USED IN DOORS OR GLAZING LOCATED WITHIN A 24" ARC OF THE NEAREST VERTICAL EDGE OF A DOOR OR IN AREAS SUBJECT TO HUMAN IMPACT OR OTHER HAZARDOUS

LOCATIONS SHALL BE TEMPERED OR OF AN APPROVED SAFETY GLAZING MATERIAL PER SECTION 2406, IBC.

-DIMBNISIONS ARE TO CENTER OF WALL AT NEW WALLS AND FACE OF WALL AT DOSTING WALLS UNITES NOTED OTHERWISE

PRELIMINARY PLAN ONLY-NOT CONSTRUCTION

ARCHITECTUR ENGINEERING PLANNING INTERIORS

15595 EW 71HD AVE CUITE 100
PORTLAND, OREGON 97124
TEL: 503,115,1285
FAX: 503,125,1576
WWW.CIDAINC.COM

KIDDIE ACADEMY - CAMAS CAMAS, WASHINGTON

A1.1

190019.01 ONI FOR POODA ALL RIGHTS REE

GENERAL NOTES

CONTRACTOR SHALL CONTACT LANDSCAPE ARCHITECT AT LEAST TWO WEEKS PRIOR TO START OF LANDSCAPE WORK TO REVIEW PLANT SUBSTITUTIONS & JURISDICTICNAL REQUIREMENTS

PLANTING NOTES

8CALE 1" = 20"

- ALL CONSTRUCTION SHALL BE PERFORMED IN ACCORDANCE WITH CURRENT CITY OF CAWAS STANDARDS AND THE WASHINGTON STRUCTURAL SPECIALTY 7. CODE.
- 2 VERIFY ALL EXISTING CONDITIONS, WICLIDING LOCATION OF PROPERTY
 UNES, PRIOR TO BEGINNING ANY WORK REPORT ANY DISCREPANCIES TO
 THE OWNERS REPROSENTATIVE IMMEDIATELY

 COORDINATE AND SCHEDULE ALL WORK WITH THE OWNER'S REPRESENTATIVE. 11.
 CONTRACTOR SHALL DESIGN THE IRRIGATION SYSTEM AND PROVIDE OWNER
 WHISHOP DRAWNING TOR APPROVAL SEE SPECS.
- DO NOT WILL FULLY PROCEED WITH COISTRUCTION WHEN UNKNOWN
 OSSTRUCTIONS AND/OR DEFFERENCES EXST THAT MAY NOT HAVE BEEN KNOWN
 DURING DESIGN INMEDIATE MOTIFY OWNERS REPRESENT AID OF OF DIRHOVING STRUCTIONS AND/OR DEFFERENCES PRIOR TO REMOVING ADD
 DIRHOVING OSSTRUCTIONS AND/OR DEFFERENCES PRIOR TO REMOVING ADD
 CONTRACTOR SHALL PROVIDE TOPSOL, SOIL AND EROSION
 CONTRACTOR SHALL SUBMIT CERTIFIED FOIL AND/SIS REPORT FOR CONTRACTOR SHALL SUBMIT CERTIFIED FOR SHALL SHALL SUBMIT CERTIFIED FOR SHALL SHA
- 4 PROTECT EXISTING ITEMS TO REMAIN OURSING CONSTRUCTION ANY CAMAGE TO EXISTING ITEMS OESIGNATED TO REMAIN ITE CURSS, WALKS, PLANT MATERIAL, I.D. LAWN OR FERCES SHALL BE REPAIRED OR REPLACED AT NO ADDITIONAL COST TO THE OWNER.

 ONDER ORANIAGE CONDITIONS INCESSARY TO ENSURE PROPER GROWING CONDITIONS FOR PROPOSED PLANTINGS. SEE SPECS.
- 5 VERBY THE LOCATION OF ALL UNDERGROUND UTLITIES, LINES, PIPES.

 AULTS, OR BONES PRIOR TO EXCAVATION MARKAND PROTECT ALL

 UNLITIES, SITE FEATURES AND VEDETATION TO REJAIN IN PLACE, ANY DAMAGE
 TO ANY MOVIME EXISTING UTILITY ELEMENTS SHALL BE REPAIRED PROPERTY
 AND IMMEDIATELY.

 CONTRACTOR SHALL FOLLOW PROVIDERS INSTRUCTIONS AND
 RECOMMENDATIONS FOR SEEDING

 ALL PLANTS SHALL BE INSTALLED ACCORDING TO AMERICAN STANDARD FOR
 MISSIRY STOCK (ANS) 226.1) AS WELL AS DETAIL DRAWINGS AND
 SPECIFICATIONS.
- REMOVE FROM THE SITE AND LEGALLY DISPOSE OF ALL DEBRIS AND EXCAVATED MATERIX, NOT REQUIRED FOR FILL NO RUBBISH DR DEBRIS SHALL SE BRIEDATED BY A FULLY AUTOMATED, PERMOVENT SE BUREDO NOT THE SITE.

- MULTAIN ALL ROADWAYS AND PAVED PATHWAYS CLEAN AND FREE OF CONSTRUCTION MATERIALS AND DEBRIS, PROVIDING NECESSARY DUST CONTROL WHERE REQUIRED.
- INSTALL EROSION CONTROL SYSTEMS IN ACCORDANCE WITH CITY OF CAMAS STANDARDS PRIOR TO SITE WORK AND LANDSCAPE INSTALLATION
- CONTRACTOR SHALL SUBMIT CERTIFIED TOPSOIL ANALYSIS REPORT FOR CAMBER'S APPROVAL PRIOR TO PLANT INSTALLATION. SEE SPECS.

- CONTRACTOR SHALL RISTALL RAIN SENSORS AS PER MANUFACTURE'S RISTRUCTIONS AND RECOMMENDATIONS VERIFY THE LOCATION WITH THE OWNER PRIOR TO INSTALLATION.
- 13 PRIOR TO FINAL ACCEPTANCE, CONTRACTOR SHALL PROVIDE OWNER WITH AS-BURIT PLANS OF THE INSTALLATION, COPIES OF ALL OPERATION VANUALS AND WARRANTY DOCUMENTS.
- 19 ALL NEW PLANTS IN LANDSCAPE AREAS SHALL SE WARRANTED FOR A PERIOD OF DNE YEAR FROM THE DATE OF FINAL ACCEPTANCE.

TREES	CODE	QTY	BOTAMCAL NAME	COMMON NAME	SIZE	
	AB	3	ACER GRISEUM	PAPERBARK WAPLE	2 CAL	\dagger
\odot						
\odot	AF	5	ACER RUBRUM "FRANKSRED" TM DROUGHT TOLERANT	RED SUIISET IMPLE	2 CAL	
\bigcirc	FD	5	FAGUS SYLVATICA DAWYCK PURPLE	EUROPEAN BEECH	2º CAL	
\odot	GD.	2	GYMNOCLADUS CIOICUS 'ESPRESSO' CROUGHT TOLERANT	KENTUCKY COFFEETREE	2º CAL	
((·)	MA2	2	MAACMA AMURENSIS	AMUR MAACKA	rca	
$\widetilde{\langle \cdot \rangle}$	FC	1	PRUMUS BARGENTII 'COLUMNARIS'	COLUMBAR SARGENT CHERRY	2º CAL	
EVERGREEN TREES	CODE	QTY	BOTA I PCAL HAME	CONNON NAME	SIZE	
0	PF	2	PRIUS FLEXIUS 'VANDERWOLF'S PYRAMID'	VALOERWOLF'S PYRAMIO PINE	5 HT.	
8	TH	9	THUMA PLICATA 'HOGAN'	HOGAN CEDAR	5 HT.	
SHRUBS	CODE	QTY	BOTANICAL NAME	COMMONIMANE	SIZE	
0	AC2	33	ARBUTUS UNEDO "COMPACTA"	DWARF STRAWBERRY TREE	5GAL.	
0	СТ	16	CEANOTHUS THYRSIFLORUS EVERGREEN MATIVE	BLUE BLOSSON	5GAL	
0	EC	3	EUONYMUS ALATUS COMPACTUS	COMPACT BURNING BUSH	5GAL	
0	HР	37	HYDRAVIGEA ARBORESCENS 'PEE WEE'	PEE WEE OAKLEAF HYDRANGEA	5GAL	
0	UE.	9	LOROPETALUM CHINENSE "PIPA"S RED"	PIPA'S RED LOROPETALUM	5 GAL	
D	PH	39	PENNISETUM ALOPECUROIDES 'HAMELN'	HAVELN FOURTAIN GRASS	5 GAL	
0	RE	36	RHAPHOLEPIS INCICA "CONOR" EVERGREEN EROUGHT TOLERANT	ELEANDR TABOR INDIAN HAWTHORN	5GAL	
₩	RM	11	ROSA SHRUS 'MEIPOQUE' TM	PINK MEIOILANG ROSE	5 GAL	
GROUND COVERS	CODE	QTY	EDTARCAL NAME	СОУМОН НАЖЕ	912E	SPACING
	CC	149	СЕАНОТНИЯ Х "СЕНТЕИВНА!."	CENTENHIAL CEANOTHUS	1 GAL	36.0°
	CL.	99	COTOREASTER DAMMERI LOWYAST	LOWFAST BEARBERRY COTOREASTER	1 GAL	24" 0 €
	FC	220	FRADARIA CHILOENSIS	BEACH STRAWBERRY	1 GAL	15" o.c
	ΊΥ	143	JUNIPERUS HORIZOHTALIS 'YOUKOSTOWK'	CREEPING JUNDPER	1 GAL	35 026
	ыд	108	MAHONIA REPENS	CREEPING MAHONIA	1 GAL	24* 0.€
	RH	45	ROSMARINUS OFFICINALIS 'HUNTINISTON CARPET'	HUNTINGTON CARPET ROSEMARY	1 GAL	35" O.C.
រាក់ទី កើតទី កើតទី និង ២០ ខែ២០ ខែ២០ ខែ២	RP2	124	RUBUS CALYCINOIDES 'EMERALD CARPET'	CREEPING RASPBERRY	I GAL	24° 0.¢.

PLANT SCHEDULE

LANDSCAPE REQUIRE	TO THE TO THE TO THE TOTAL	Į	
TOTAL SITE AREA	=46,913 9F (108 AC)		
NO EXISTING TREES ON SITE			~
TREE DENSITY REQ 20 UNITS PER ACRE	=22 TREE UNITS	20 200 PT	-

=25 TREE UNITS =11 (56% OF TREE DENSITY

=1 TREE PER 6 PKG. SPACES =6 PKG LOT TREES

PKG LOT TREES REQ. 36 PKG. SPACES 20% REQUIRED EVERGREEJ EVERGREEN PROPOSED

PERCENTAGE OF EVERGREEN SHRUBS

TREES PROPOSED
OF EVEROREEN TREES

REQUIREMENT)

= 29% PERCENTAGE OF NATIVE PLANTINGS =31%

PERCENTAGE OF DROUGHT TOLERANT PLANTS = 93%

© 50 50 50 50 50 50 50 50 50 50 50 50 50	63'-6" 12 BUFFER
	B B B B B B B B B B B B B B B B B B B

GRAPHIC SCALE LANDSCASPE PLAN



CAMA **ACADEMY**

KIDDIE

SHEET TITLE LANDSCAPE


PLAN

DATE: 08/20/2019 DRAWN: CHECKED: NWS REVISIONS:

O WE SHOW THE SATE

SHEET NUMBER

JOB NUMBER: A19133,10

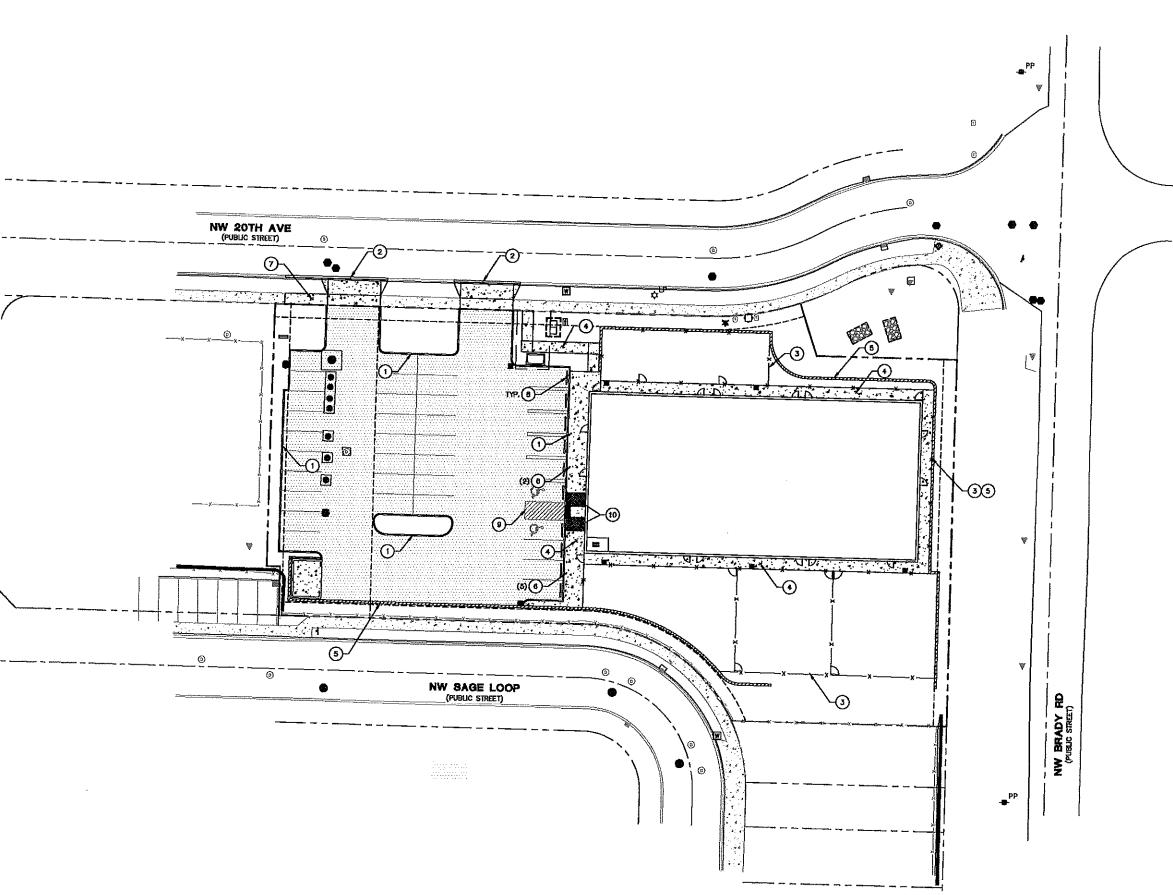

SHEET NOTES

- 1. SEE SHEET CO.1 FOR GENERAL SHEET NOTES.
- 2. SEE ARCHITECTURAL PLANS FOR ADDITIONAL SITE INFORMATION,
- 3. THE CONTRACTOR SHALL HAVE A FULL SET OF THE CURRENT APPROVED CONSTRUCTION DOCUMENTS INCLUDING ADDENDA ON THE PROJECT SITE AT ALL TIMES.
- 4. THE CONTRACTOR SHALL KEEP THE ENGINEER AND JURISDICTION INFORMED OF CONSTRUCTION PROGRESS TO FACILITATE SITE OBSERVATIONS AT REQUIRED INTERVALS. 24—HOUR NOTICE IS REQUIRED.

© CONSTRUCTION NOTES

- 1 INSTALL STANDARD CURB PER DETAIL 2/C4.1.
- 2 INSTALL DRIVEWAY PER CITY OF CAMAS STANDARD DETAIL ST17/C4.3.
- 3 INSTALL SITE FENCING. SEE ARCHITECTURAL PLANS FOR ADDITIONAL INFORMATION.
- 4 INSTALL PRIVATE SIDEWALK PER DETAIL 1/C4.1
- 5 INSTALL RETAINING WALL. SEE ARCHITECTURAL AND STRUCTURAL PLANS FOR ADDITIONAL INFORMATION.
- 6 INSTALL BOLLARD PER DETAIL 6/C4.1.
- 7 INSTALL PUBLIC SIDEWALK PER CITY OF CAMAS STANDARD DETAIL STIB/C4.3.

- B INSTALL WHEEL STOP PER DETAIL 7/C4.1.
- 9 ADA PARKING STRIPING PER DETAIL 4/C4.1.
- 10 ADA RAMP PER DETAIL 8/C4.1.

LEGEND

PROPERTY LINE CONCRETE SIDEWALK SURFACING PER DETAIL 1/C4.1

ASPHALT SURFACING PER DETAIL 5/C4.1

ACADEMY

CAMAS

HARDSCAPE

DATE: DRAWN: CHECKED: NWS

THESE BRAININGS AND THE PROPERTY OF AN EXEMPERING BYO, AND AND MOT TO BE TISSED OR REPRESENCED IN ANY MANNEY, EXCEPT WITH THE PRICE WISTED PERMISSION OF AN DISCRESSION BYO.

(IN FEET) 1 inch = 20 feet



EXGINEERING

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SHEET TITLE

KIDDIE

PLAN


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REVISIONS:

O M. PRINCES

SHEET NUMBER

JOB NUMBER: A19133.10

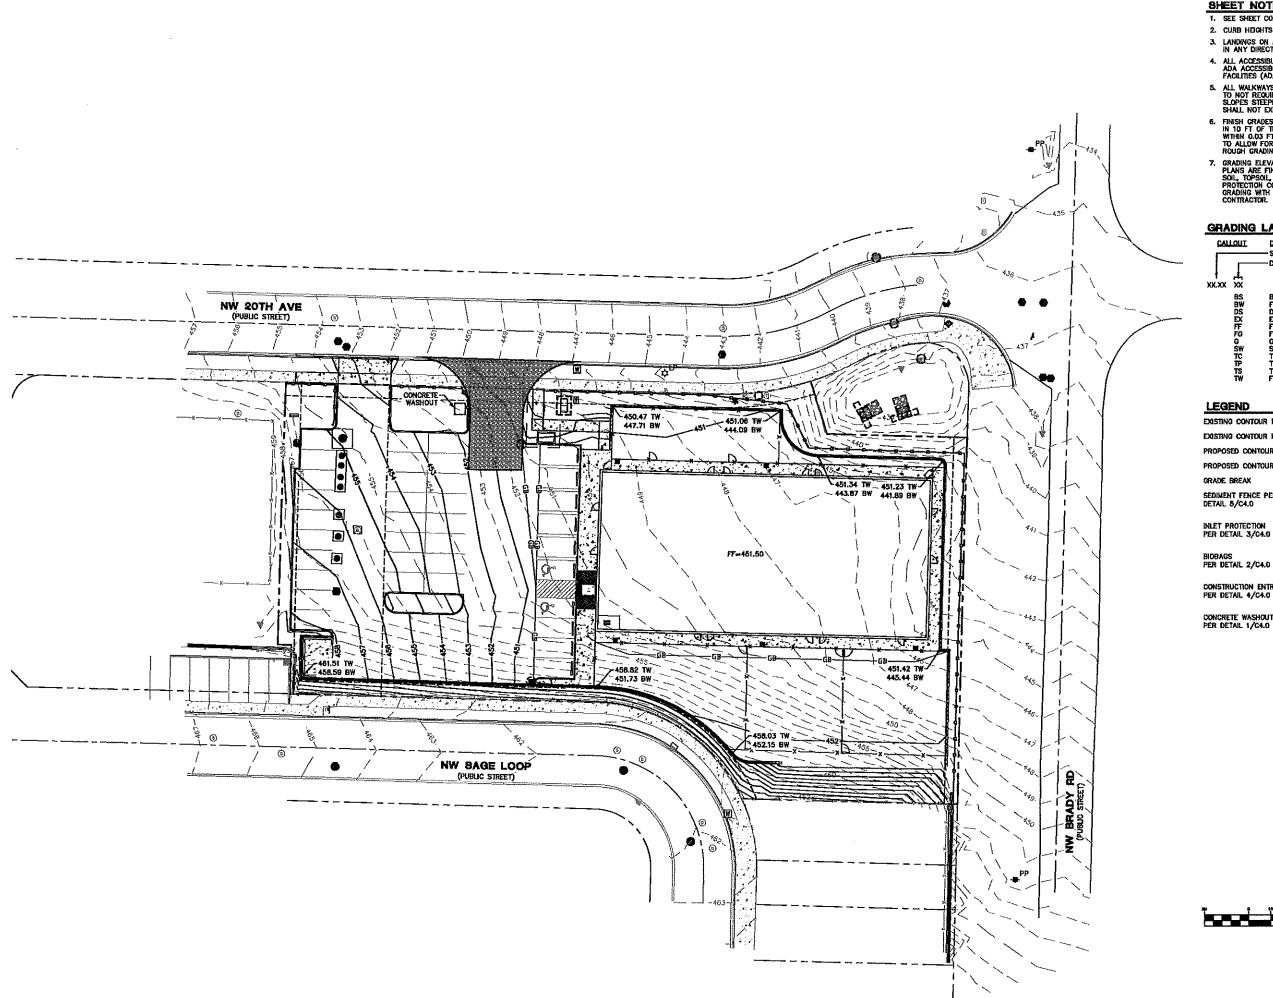

SHEET NOTES

- 1. SEE SHEET CO.1 FOR GENERAL SHEET NOTES.
- 2. CURB HEIGHTS ARE 6" UNLESS NOTED OTHERWISE.
- LANDINGS ON ACCESSIBLE ROUTES SHALL NOT EXCEED 2% IN ANY DIRECTION.
- 4. ALL ACCESSIBLE ROUTES SHALL COMPLY WITH CURRENT ADA ACCESSIBILITY GUIDELINES FOR BUILDING AND FACILITIES (ADAAG).
- 5. ALL WALKWAYS FROM ACCESSIBLE UNITS ARE DESIGNED TO NOT REQUIRE HANDRAILS, THEREFORE, RAMPS WITH SLOPES STEEPER THAN 5.0% AND LESS THAN 8.33% SHALL NOT EXCEED 0.5' RISE OR 6.0' LENGTH.
- 6. FINISH CRADES ARE TO BE BROUGHT TO WITHIN 0.08 FT IN 10 FT OF THE GRADES SHOWN AT SUBGRADE AND TO WITHIN 0.03 FT IN 10 FT AT FINISH GRADE. CONTRACTOR TO ALLOW FOR PLACEMENT OF REQUIRED TOPSOIL IN ROUGH GRADING.
- 7. GRADING ELEVATIONS AS SHOWN ON SITE AND LANDSCAPE PLANS ARE FINSHED GRADE WHICH INCLUDES SUBGRADE SOIL, TOPSOIL, SOIL AMENDMENTS, ROCKERY AND RUNOFF PROTECTION CONTRACTOR IS RESPONSIBLE TO COORDINATE GRADING WITH BOTH EXCAVATOR AND LANDSCAPE CONTRACTOR.

GRADING LABEL LEGEND

POSTERIAL.	DESCRIPTION.
XXXX XX	— SPOT ELEVATION — DESCRIPTION LISTED BELOW.
BS BW DEX FFO G SW TC P TS TW	BOTTOM OF STAIRS FINISHED GRADE AT BOTTOM OF WALL DOOR SLIL EXISTING GRADE FINISHED FLOOR ELEVATION FINISH GRADE GROUND SDEWALK TOP OF CURB TOP OF PAVEMENT TOP OF STAIRS FINISHED GRADE AT TOP OF WALL

FOEND

LEGEND	
EXISTING CONTOUR MINOR	102
EXISTING CONTOUR MAJOR	
PROPOSED CONTOUR MINOR	102
PROPOSED CONTOUR MAJOR	100
GRADE BREAK	<u> </u>
SEDIMENT FENCE PER DETAIL 5/C4.0	-9-0-0-0-0-0
INLET PROTECTION PER DETAIL 3/C4.0	\circ
BIOBAGS PER DETAIL 2/C4.0	c 5 53
CONSTRUCTION ENTRANCE PER DETAIL 4/C4.0	
CONCRETE WASHOUT PER DETAIL 1/C4.0	

SHEET TITLE

ATE:	08/20/2019
RAWN:	JJS.
HECKED:	NWS

JOB NUMBER: A19133.10

10 /4E /0010 - DD CHEWITTAL

(IN FEET) 1 inch = 20 feet



EXGINEERING
h Drow | Sulfe 300 | Beaverlon, OR | 97006
tel | 500 520 5539 | fix | www.aseng.com

K ⋖ 4875 SW Gniffth Drov 503 620 3030 tel | f

CAMAS


ACADEMY KIDDIE

GRADING PLAN

REVISIONS:

C AS PERSONS SE.

SHEET NUMBER

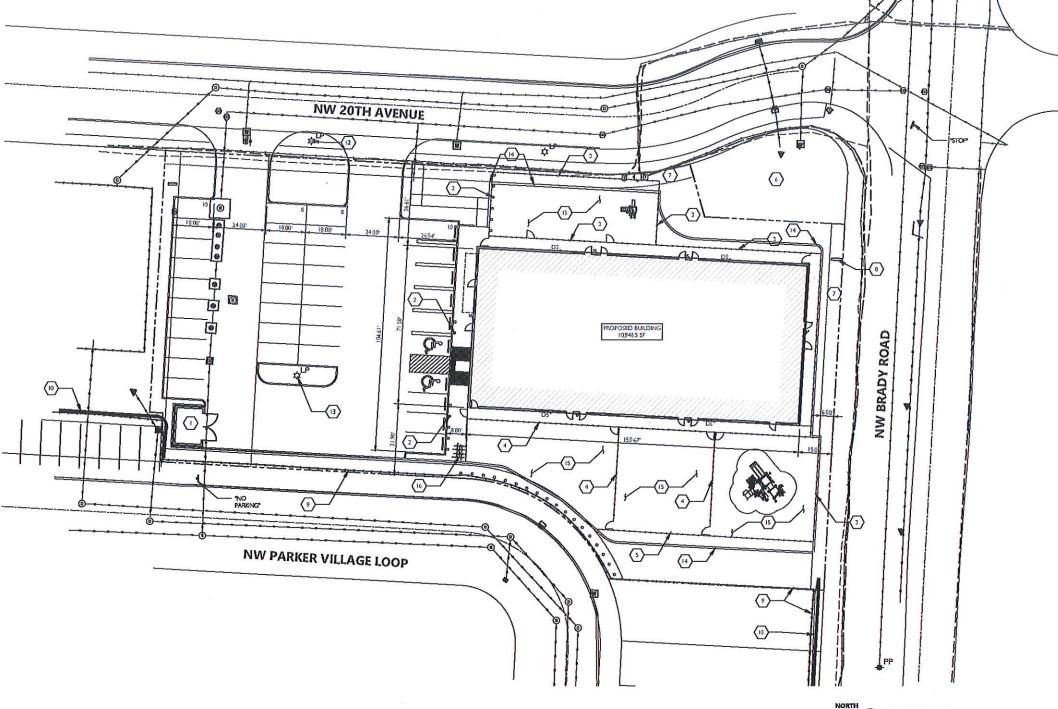

1 SITE PLAN 1 1 = 20-0

GENERAL NOTES

- CONTRACTOR SHALL VERFY AND CONFIRM EXISTING CONDITIONS SHOWN OR MPUED ON DRAWINGS PRIOR TO START OF CONSTRUCTION. NOTIFY ARCHITECT/ENGINEER OF ANY DISCREPANCIES.
- TYPICAL CURB RADIUS = 3' UNLESS NOTED OTHERWISE.
- FRIOR TO SITE CLEARING, GRADING OR CONSTRUCTION IN THE VEGETATED CORRIDOR WATER QUALITY AND SENSITIVE AREAS SHALL BE SURVEYED, STAKED AND TEMPORARILY FENCED. VEGETATED CORDIDOR SHALL REMAIN FENCED AND UNDISTURBED DURING CONSTRUCTION.

LEGAL DESCRIPTION

ABBREVIATED DESCRIPTION: PARKER VILLAGE PH LOT 61 31 1823 CLARK COUNTY WASHINGTON

SITE APEA:

BUILDING COVERAGE: 10,9485 SF, 23.3% IMPERMOUS SURFACE (NOT INCL. BUILDING): 18,4665 SF 40.4% LANDSCAPE AREA: LANDSCAPING (NOT INCL PLAY AREA:

8,612 SF, 18.3% 8,496 SF 18.0% PLAY YARD: TOTAL SITE AREA: 46,972 SF (1.08 ACRES)

PARKING PROVIDED:

TYPE	SIZE	# PROVIDE
STANDARD	9' X 18'	34 STALLS
H/C ACCESSIBLE	9' X 18'	2 STALLS
TOTAL BROUGHT BARRY	10.	2/ CTAIL C

LEGEND

FIRE HYDRANT POWER POLE / LIGHT POLE

CATCH BASIN SANITARY SEWER MANHOLE

SANITARY LATERAL 0 STORM DRAIN MANHOLE WATER METER WATER RISER

CURE INLET CLEAN OUT ELECTRICAL PANEL COMMUNICATIONS RISER.

> ACCESS LID CULVERT INVERT FAD-MOUNTED TRANSFORMER

9GN "AS-NOTED" EXISTING

DOWNSPOUT

BUILDING MOUNTED LIGHT FOCTURE

ACCESSIBLE PAPKING PROPERTY BOUNDARY PROPERTY EASEMENT

PRELIMINARY PLAN ONLY-NOT CONSTRUCTION

ENGINEERIN PLANNING INTERIORS 5695 EW 71HD AVE SUITE 10

KIDDIE ACADEMY - CAMAS CAMAS WASHINGTON

STE PLAN

A0.1

COMPODA, ECADOA ALL RONTS REED

KEYNOTES

TRASH ENCLOSURE (1)

BOLLARD 5'-0' HIGH DECORATIVE FENCE RELOCATED STREET LIGHT

RETAINING WALL

BICYCLE PARKING

OUTDOOR PLAY AREA

NEW LIGHT MOUNTED LIGHT

(12)

(13)

(14)

(15)

(16)

4"4" HIGH \ CHAIN LINK FENCE 4 5'4" HIGH CHAIN LINK FENCE

(E) DETENTION POND

(E) 6'-0' UTILITY EASEMENT 7

MONUMENT SIGN (E) 6'40' VINYL FENCE

(E) KEYSTONE BLOCK WALL

(E) BLOCK WALL

 $\langle 2 \rangle$ (1)

(5) 6

(3)

9 (10)



Community Development Department 616 NE Fourth Avenue Camas, WA 98607 (360) 817-1568

STAFF REPORT Design Review Application for Vutukuri Duplex City File No. DR19-08

To: Design Review Committee

FROM: Madeline Sutherland, Assistant Planner

APPLICANT: Tony Marnella

LOCATION: 1213 NW Benton Street

Camas, WA 98607 Parcel No. 82973000

APPLICABLE LAW: The application was submitted on August 30, 2019. The applicable codes are those codes that were in effect at the date of application. Camas Municipal Code Chapters (CMC): Title 18 Zoning (not exclusively): CMC Chapter 17.21 Procedures for Public Improvements; CMC Chapter 18.19 Design Review; Camas Design Review Manual (2016); and CMC Chapter 18.55 Administration and Procedures; and RCW 58.17.

BACKGROUND:

The Vutukuri duplex is located on approximately 0.11 acres of single-family (R-7.5) zoned property at 1213 NW Benton Street. The applicant is currently seeking design review approval for the construction of a duplex residential building. Each residential unit contains a single car garage accessed at the front of the building, with additional parking provided on the driveway. Landscaping is provided on site.

The project area is bordered on each side by single-family residential homes. Existing plex's are located within the project vicinity.

PURPOSE:

Design Review is required under CMC Chapter 18.19. Design review is not intended to determine the appropriate use on a parcel but rather review a proposed development for compliance with City codes and plans related to landscaping, architectural elevations and other elements relative to required improvements. The recommendations from the Design Review Committee (DRC) must consider the general design review standards (CMC Chapter 18.19.050.A and the Camas Design Review Manual "DRM" pages 4-7), along with the the specific standards for multi-family (CMC Chapter 18.19.050.B.3.c and the DRM page 19); which are included in the enclosed Design Review Checklist.

STANDARD AND MULTI-FAMILY DESIGN PRINCIPLES AND GUIDELINES:

The standard and multi-family principles are required and must be demonstrated to have been satisfied in overall intent for design review approval. The standard design guidelines are developed to assist a project in meeting the established principles and each guideline should be adequately addressed. If the

proposal cannot meet a specific guideline, then an explanation should be provided by the applicant as to why and how it will be mitigated to satisfy the intent of the design principles. The development guidelines include five major categories: 1) Landscaping and Screening, 2) Architecture, 3) Massing and Setbacks, 4) Historic & Heritage Preservation, and 5) Circulation and Connections. The Design Review Checklist is enclosed to help guide the DRC in reviewing the standard applicable specific design review principles and guidelines.

RECOMMENDATION:

That the Design Review Committee reviews the submitted materials, deliberates, and forwards a recommendation to the Director for a final decision.



Design Review Checklist for (DR19-08) Vutukuri Duplex

The purpose of this sheet is to provide a simplified and expedited review of the design review principles and guidelines using objective review standards. The standards are intended as tool for the decision-maker in making findings that the proposal either achieves compliance with the intent of the principles or reasonably mitigates any conflict. When reviewing the check sheet, the proposal should as a whole "comply" with the standards and thus be generally consistent with the overriding principles. [Yes = In Compliance; No = Not In Compliance; NA = Not Applicable]

Standard Principles and Guidelines

ARCH	HTECT	URE		
Yes	No	NA	Principles and Guidelines	Comments
			Corrugated materials, standing seam, T-1 11, or similar	
			siding materials are avoided unless it produces a high	
			visual (or aesthetic) quality.	
			Buildings walls or fences visible from roadways are	
			articulated in order to avoid a blank look.	
			The use of bold colors has been avoided unless used as	
			minor accents.	
			Higher density/larger structures abutting lower density	
			residential structures have been designed to mitigate	
			size and scale differences.	
LAND	SCAP	NG AI	ND SCREENING	
Yes	No	NA	Principles and Guidelines	Comments
			Vegetation for landscaping includes native, low	
			maintenance plantings. Significant trees are retained if	
			feasible.	
			Trees planted along streetscapes with overhead power	
			lines include only those trees identified on the City's	
			Tree list.	
			Landscaping, including trees, shrubs, and vegetative	

			anatural action to muchidad to trioughly agreed to the	
			groundcover, is provided to visually screen and buffer	
			the use from adjoining less intense uses including	
			parking.	
			Proposed fencing is incorporated into the landscaping so	
			as to have little or no visual impact.	
			Signs located on buildings or incorporated into the	
			landscaping are unobtrusive and vandal resistant. If	
			illuminated they are front lit.	
			Landscape lighting - low voltage, non-glare, indirect	
			lighting is directed, hooded or shielded away from	
			neighboring properties.	
			Street lighting (poles, lamps) is substantially similar or	
			architecturally more significant than other street lighting	
			existing on the same street and do not conflict with any	
			City approved street lighting plans for the street.	
			Parking and building lighting is directed away from	
			surrounding properties through the use of hooding,	
			shielding, siting and/or landscaping.	
			Outdoor furniture samples are consistent with the	
			overall project design.	
			Existing trees over 6" dbh that are not required to be	
			removed to accommodate the proposed development	
			are retained and incorporated into the landscape plan.	
			Rock outcropping's, forested areas and water bodies are	
			retained.	
HISTO	ORIC A	ND H	ERITAGE PRESERVATION	
Yes	No	NA	Principles and Guidelines	Comments
			The use of Historic Markers, information kiosks, project	
			names, architectural features, or other elements of the	
			project promote the historic heritage of the site or	
			surrounding area.	

Specific Principles and Guidelines

MULTI-FAMILY								
Yes	No	NA	Principles and Guidelines	Comments				
1. DUPLEX, TRIPLEX & FOUR-PLEX								
			Attached garages account for less than 50% of the front					
			face of the structure (as measured by lineal footage).					
			Garages visible from the street are articulated by					
			architectural features, such as windows, to avoid a blank					
			look.					
			Buildings provide a complementary façade that faces the					
			public right of way, and is the primary entrance to a unit					
			or multiple units, unless impracticable.					

The proposed duplex meets the design review standards under the CMC 18.19.050 (A) and Standard Principals CMC 18.19.050 (B)(3)(c):

A. Design Review:

 Landscaping shall be done with a purpose. It shall be used as a tool to integrate the proposed development into the surrounding environment.

The landscaping is designed to integrate the new duplex into the neighborhood. The existing laurel hedge on the north side of the lot will be preserved and the large deciduous tree immediately south of the SE corner overhangs the lot. With the current landscape design, the subject duplex will sit within the existing landscape with the landscape being added to the front yards will blend well.

All attempts shall be made at minimizing the removal of significant natural features.
 Significant natural features shall be integrated into the overall site plan.

The existing laurel hedge on the north side of the lot will be preserved and the large deciduous tree immediately south of the SE corner overhangs the lot. With the current landscape design, the subject duplex will sit within the existing landscape. There are no significant natural features on the subject property

 Buildings shall have a "finished" look. Any use of panelized materials shall be integrated into the development in a manner that achieves a seamless appearance.

The design of the new duplex incorporates architectural features of the turn of the century homes in the neighborhood such as board and batt. This is a panelize styled feature and it will blend seamlessly into the overall exterior detailing.

 A proposed development shall attempt to incorporate or enhance historic/heritage elements related to the specific site or surrounding area.


The design of the new duplex incorporates architectural features of the turn of the century homes in the neighborhood such as: board and batt, covered porches, 4" wide trim around windows/doors and dormer detail at 2nd floor.


- B. Standard Principals, Duplex, Triplex and Fourplex:
 - Garages shall account for less than fifty percent of the front face of the structure. Garages visible from the street shall be articulated by architectural features, such as windows, to avoid a blank look

The garages of the new duplex face the street and meet the above standard. Windows will be in the carriage style garage doors and the front porches are forward of the garage face with posts overlapping the inside corner of the garage. This is an added element that softens the garage face.



Vicinity Map

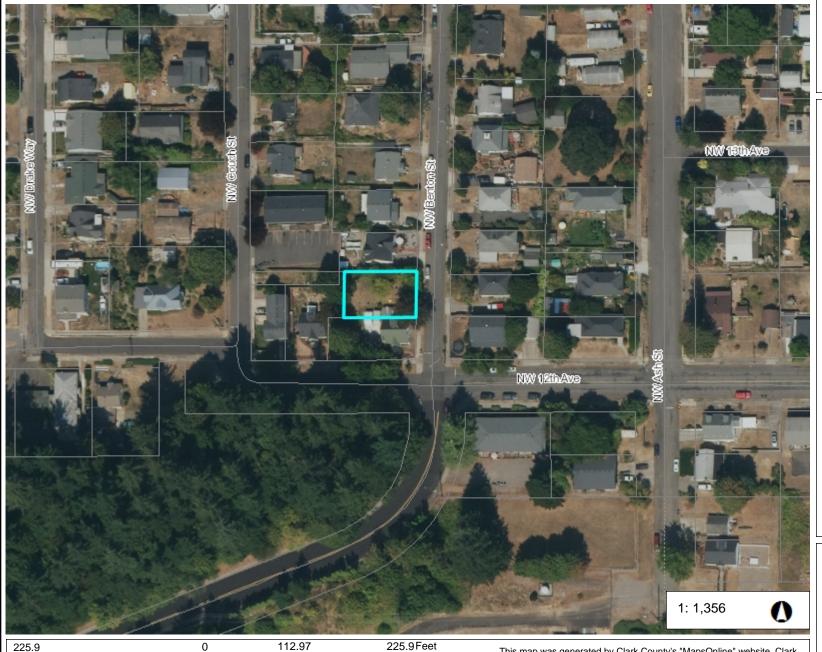

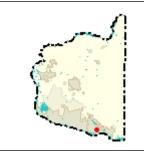

Legend

Taxlots

All Roads

Interstate

State Route

. Arterial

Forest Arterial

Minor Collector

Forest Collector

--- Private or Other


Cities Boundaries

Urban Growth Boundaries

Notes:

WGS_1984_Web_Mercator_Auxiliary_Sphere Clark County, WA. GIS - http://gis.clark.wa.gov

This map was generated by Clark County's "MapsOnline" website. Clark County does not warrant the accuracy, reliability or timeliness of any information on this map, and shall not be held liable for losses caused by using this information.

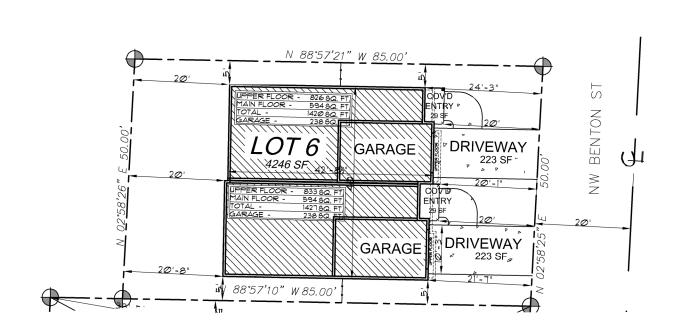

LOT AREA	4,242 SF
BUILDING COVERAGE	1,772 SF
% OF COVERAGE	43.4%
IMPERVIOUS AREA	446 SF

BUILDING HEIGHT = 25'-9"



SCALE: 1"=20'

SETBACKS:

FRONT = 20' REAR = 20' SIDE YARD = 5'

PLAN NAME:


VUTUKURI

DRAWN: E DRAFT
PLOT: 8/21/19

1"=20

VUTUKURI SITE



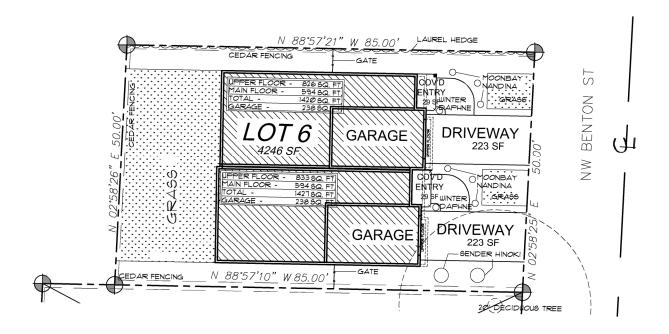



SCALE: 1"=20'

SETBACKS:

FRONT = 20' REAR = 20' SIDE YARD = 5'

PLAN NAME:

VUTUKURI

DRAWN: E DRAFT.

PLOT: 8/26/19

SCALE: | " = 20 |

VUTUKURI LANDSCAPE





Brian Emrich: S60-909-4582 Email: edrafting@hotmail.com

FILE NAME : 1427-40-ST-L

DRAWN BY:

E DRAFTING

SCALE:

As indicated

PLOT DATE:

8/22/2019

9:16:34 AM

Written dimensions on these drawings shall have precedence over scaled dimensions. Contractor shall assume responsibility for all dimensions and conditions on the job. The designer must be notified and consent to any variations from dimensions set forth herein. The type of exterior finish, the installation and waterproofing details are all to be the full responsibility of the owner/builder. This Designer assumes no responsibility for the integrity of the building envelope. This document is the property of E Drafting Corp. No reuse or reproduction is allowed without the written consent from E Drafting Corp.

SHEET

Building Elevations

A1

GENERAL NOTES:

- ALL MORK SHALL BE DONE IN CONFORMANCE WITH THE LATES EDITION OF LOCAL BUILDING CODE, ONE AND TWO FAMILY DWELLING CODES AND ALL OTHER GOVERNING CODES, LAWS AND REGULATIONS.
- SITE/CONSTRUCTION DOCUMENTS AND CONSTRUCTION PHASE: CONTRACTOR SHALL NOT SCALE THE DRAWINGS, OR DETAILS. CONTRACTOR SHALL VERIFY ALL DIMENSIONS, ELEVATIONS AND CONDITIONS AT THE JOBSITE. NOTIFY DESIGN AGENCY IN WRITTING OF ANY SIGNIFICANT DEVIATIONS, ANY CHANGES TO CONSTRUCTION DOCUMENTS OR IF ADDITIONAL DETAILS, SPECIFICATIONS ARE NEEDED FOR PROPER EXECUTION OF THE WORK. ALSO NOTIFY DESIGN AGENCY IN WRITTING IF THERE ARE ANY CORRECTIONS OR CHANGES TO BE MADE TO THE CONSTRUCTION DOCUMENTS REQUIRED BY THE PLANNING/BUILDING DEPARTMENT OFFICALS. PLANS CORRECTION LIST OR COMMENTS (FROM THE PLANNING/BUILDING
- DEPARTMENT OFFICIALS) MUST BE DELIVERED TO THE DESIGN AGENCY. THE CONTRACTOR SHALL BE RESPONSIBLE FOR COORDINATION OF ALL TRADES, INCLUDING ALL ARCHITECTURAL, STRUCTURAL, MECHANICAL AND ELECTRICAL REQUREMENTS.
- MECHANICAL AND ELECTRICAL WORK IS ON A CONTRACTOR DESIGN/BUILD BASIS. COORDINATE ALL ARCHITECTURAL AND STRUCTURAL MORK WITH MECHANICAL AND ELECTRICAL REQUIREMENTS. ALL DIMENSIONS ARE TO THE FACE OF FRAMING MEMBERS UNLESS NOTED OTHERWISE. ALL EXTERIOR WALLS TO BE 2X6
- STUDS AT 16" O.C., ALL INTERIOR WALLS TO BE 2x4 STUDS AT 16" O.C. UNLESS NOTED OTHERWISE. COORDINATE ALL ITEMS NOT SHOWN OR NOTED WITH OWNER AND/OR DESIGNER, INCLUDING BUT NOT LIMITED TO FINISHES,
- COLORS, CABINETS, HARDWARE, FIXTURES, ETC ... SEAL OR MEATHER STRIP ALL EXTERIOR OPENINGS AND PENETRATIONS IN MANNER TO PREVENT OUTSIDE AIR INFILTRATION AND MOISTURE FROM ENTERING STRUCTURAL AND OCCUPIED SPACES, INCLUDING AROUND PLUMBING AND ELECTRICAL
- LINES AND EQUIPMENT PASSING THROUGH WALLS, GUTTERS, DOWNSPOUTS, ETC... IT IS THE GENERAL CONTRACTORS RESPONSIBILITY TO FOLLOW AND COORDINATE PER THE MANUFACTURER'S PRINTED INSTRUCTIONS, SPECIFICATIONS AND INSTALLATION DETAILS THE INSTALLATION OF ALL BUILDING PRODUCTS (INTERIOR AND EXTERIOR), FIXTURES, EQUIPMENT, ETC... OR FOLLOW THE INDUSTRY STANDARD DETAILS FOR ALL THE CONDITIONS NOT SHOWN ON THE DRAWINGS FOR PROPER EXECUTION OF THE WORK IN ACCORDANCE WITH THE CONSTRUCTION DOCUMENTS. THE DESIGN AGENCY MUST BE NOTIFIED IN WRITTING TO PROVIDE ADDITIONAL DETAILS, SPECIFICATIONS OR INFORMATION PER REQUEST OF THE GENERAL CONTACTOR OR OWNER FOR PROPER EXECUTION OF THE WORK.

CONSTRUCTION PHASE:

THE DESIGNER SHALL NOT HAVE CONTROL OVER OR CHARGE OF AND SHALL NOT BE RESPONSIBLE FOR CONSTRUCTION MEANS, METHODS, TECHNIQUES, SEQUENCES OR PROCEDURES, OR FOR SAFETY PRECAUTIONS AND PROGRAMS IN CONNECTION WITH THE MORK, SINCE THESE ARE SOLELY THE CONTRACTOR'S RESPONSIBILITY UNDER CONTRACT FOR CONSTRUCTION. THE DESIGNER SHALL NOT BE RESPONSIBLE FOR CONTRACTOR'S SCHEDULES OR FAILURE TO CARRY OUT THE WORK IN ACCORDANCE WITH THE CONSTRUCTION DOCUMENTS.

MATERIAL SPECIFICATION NOTE:

THE DESIGNER DOES NOT RECOMMEND OR SPECIFY USE OF ANY TYPE OF "STUCCO PRODUCTS" OR EXTERIOR INSULATED AND FINISH SYSTEM "E.I.F.S." FOR THE EXTERIOR OF THE HOUSE. THE DESIGNER WILL NOT BE LIABLE FOR ANY KIND OF DAMAGES TO THE BUILDING (STRUCTURAL OR COSMETIC) IF THE OWNER OR THE CONTRACTOR DECIDE TO USE SUCH PRODUCTS.

MISCELLANEOUS NOTES:

- EACH BEDROOM TO HAVE A MINIMUM WINDOW OPENING OF 5.7 SQ. FT. WITH A MINIMUM WIDTH OF 20 IN. AND A SILL LESS THAN 44 IN. ABOVE FIN.
- ALL WINDOWS WITHIN 18 IN. OF THE FLOOR, AND WITHIN 12 IN. OF ANY DOOR ARE TO HAVE TEMPERED GLAZING SKYLIGHTS ARE TO BE GLAZED WITH TEMPERED GLASS ON OUTSIDE AND LAMINATED GLASS ON INSIDE (UNLESS PLEXIGLAS). GLASS TO HAVE
- MAXIMUM CLEAR SPAN OF 25 IN., AND FRAME IS TO BE ATTACHED TO A 2X CURB WITH A MINIMUM OF 4 IN. ABOVE ROOF PLANE. ALL TUB AND SHOMER ENCLOSURES ARE TO BE GLAZED WITH SAFETY GLASS.
- ALL EXTERIOR WINDOWS ARE TO BE DOUBLE GLAZED AND ALL EXTERIOR DOORS ARE TO BE SOLID CORE WITH MEATHER STRIPPING. PROVIDE \ IN. DEADBOLT LOCKS ON ALL EXTERIOR DOORS, AND LOCKING DEVICES ON ALL DOORS AND WINDOWS WITHIN 10 FT. (VERTICAL) OF GRADE. PROVIDE PEEP-HOLE 54 - 66 IN. ABOVE FIN. FLOOR ON EXTERIOR ENTRY DOORS.
- CONNECT ALL SMOKE DETECTORS (SEE PLAN FOR LOCATION) TO HOUSE ELECTRICAL SYSTEM AND INTER- CONNECT EACH ONE, SO THAT, WHEN ANY ONE IS TRIPPED, THEY WILL ALL SOUND.
- PROVIDE COMBUSTION AIR VENTS (W/ SCREEN AND BACK DAMPER) FOR FIREPLACES, WOOD STOVES AND ANY APPLIANCES WITH AN OPEN
- PER HOUR. RANGE HOODS ARE ALSO TO BE VENTED TO THE OUTSIDE.
- BATHROOMS AND UTILITY ROOMS ARE TO BE VENTED TO THE OUTSIDE WITH A FAN CAPABLE OF PRODUCING A MINIMUM OF 4 AIR EXCHANGES ELECTRICAL RECEPTACLES IN BATHROOMS, KITCHENS AND GARAGES SHALL BE G.F.I. OR G.F.I.C. PER NATIONAL ELECTRICAL CODE

= *8*33

SQ. FT.

SQ. FT.

SQ. FT.

MASHINGTON STATE: 50 CFM FAN V.T.0.5 OREGON STATE: 50 CFM FAN TOILET COMPARTMENTS 80 CFM FAN BATHING & SPA AREAS

VENT ALL TO OUTSIDE

SMOKE & CARBON MONOXIDE COMBO DETECTORS

REQUIRED AS SHOWN ON THE PLANS. DETECTORS

TO BE INTERCONNECTED AND POWERED BY

PREMISE WIRING AND HAVE BATTERY BACKUP.

AREA CALCS: (LEFT UNIT) MAIN FLOOR

UPPER FLOOR

GARAGE + SHOP

TOTAL SQ. FT. 1427

AREA CALCS: (RIGHT UNIT) SQ. FT. MAIN FLOOR UPPER FLOOR SQ. FT. 826 = TOTAL 1420 SQ. FT. GARAGE + SHOP SQ. FT.

GENERAL FLOOR PLAN NOTES:

. WINDOW SIZES & ROUGH OPENINGS TO BE VERIFIED BY

2. WINDOWS THAT ARE BOTH WITHIN 24 INCHES OF A DOOR IN A CLOSED POSITION AND WITHIN 60 INCHES OF THE FLOOR SHOULD BE TEMPERED.

TUBS, WHIRLPOOLS, SAUNAS AND STEAM ROOMS WHERE THE GLASS IS WITHIN 60 INCHES ABOVE A DRAIN INLET SHOULD BE

3. WINDOMS IN ENCLOSURES FOR BATHTUBS, SHOWERS, HOT

4. WINDOWS WITH A PANE LARGER THAN NINE SQUARE FEET, HAVING A BOTTOM EDGE CLOSER THAN 18 INCHES TO THE FLOOR AND A TOP EDGE HIGHER THAN 36 INCHES ABOVE THE FLOOR SHOULD BE TEMPERED.

5. FIREBLOCK ALL PLUMBING PENETRATIONS AND STAIR RUNS

6. ALL WOOD IN CONTACT WITH CONCRETE TO BE PRESSURE


7. TOP OF HANDRAILS SHALL BE PLACED AT 38" ABOVE THE NOSING OF TREADS & LANDINGS THE NOSING OF TREADS AND LANDINGS. HANDRAILS SHALL BE CONTINUOUS THE FULL LENGTH OF THE STAIRS. THE HANDGRIP PORTION SHALL NOT BE LESS THAN 1 1/4" NOR MORE THAN 2" IN CROSS-SECTIONAL DIMENSION. PROVIDE A SMOOTH SURFACE WITH NO SHARP CORNERS. HANDRAILS PROJECTING FROM A WALL SHALL HAVE A SPACE NOT LESS THAN 1 1/2" BETWEEN THE WALL AND THE HANDRAIL.

3. PREFABRICATED FIREPLACES, CHIMNEYS AND RELATED COMPONENTS TO BEAR U.L. OR I.C.B.O. SEAL OF APPROVAL AND TO BE INSTALLED PER MANUFACTURER'S SPECIFICATION.

7. ELEV. OF FLOOR OR LAND'G 11/2" MAX (OR 73/4" MAX FOR INSWING DR) BELOW THRESHOLD IS REQ'D FROM THE REQ'D EXIT DOOR. WHERE DOOR IS NOT THE REQ'D EXIT DOOR A STAIRWAY OF 2 OR FEWER RISERS IS PERMITTED WHERE DOOR DOES NOT SWING OVER RISER.

CEILING VENTILATION:

THE NET FREE VENTILATING AREA SHALL NOT BE LESS THAN 1/150 OF THE AREA OF SPACE TO BE VENTILATED, EXCEPT THAT THE AREA MAY BE 1/300, PROVIDED AT LEAST 50% OF THE REQUIRED VENTILATING AREA IS PROVIDED BY VENTILATORS LOCATED IN THE UPPER PORTION OF THE SPACE TO BE VENTILATED AT LEAST 3 FEET ABOVE EAVE VENTS WITH THE BALANCE OF THE REQUIRED VENTILATION PROVIDED BY EAVE VENTS. THE OPENINGS SHALL BE COVERED WITH CORROSION-RESISTANT METAL MESH WITH MESH OPENINGS OF 1/4" IN DIMENSION.

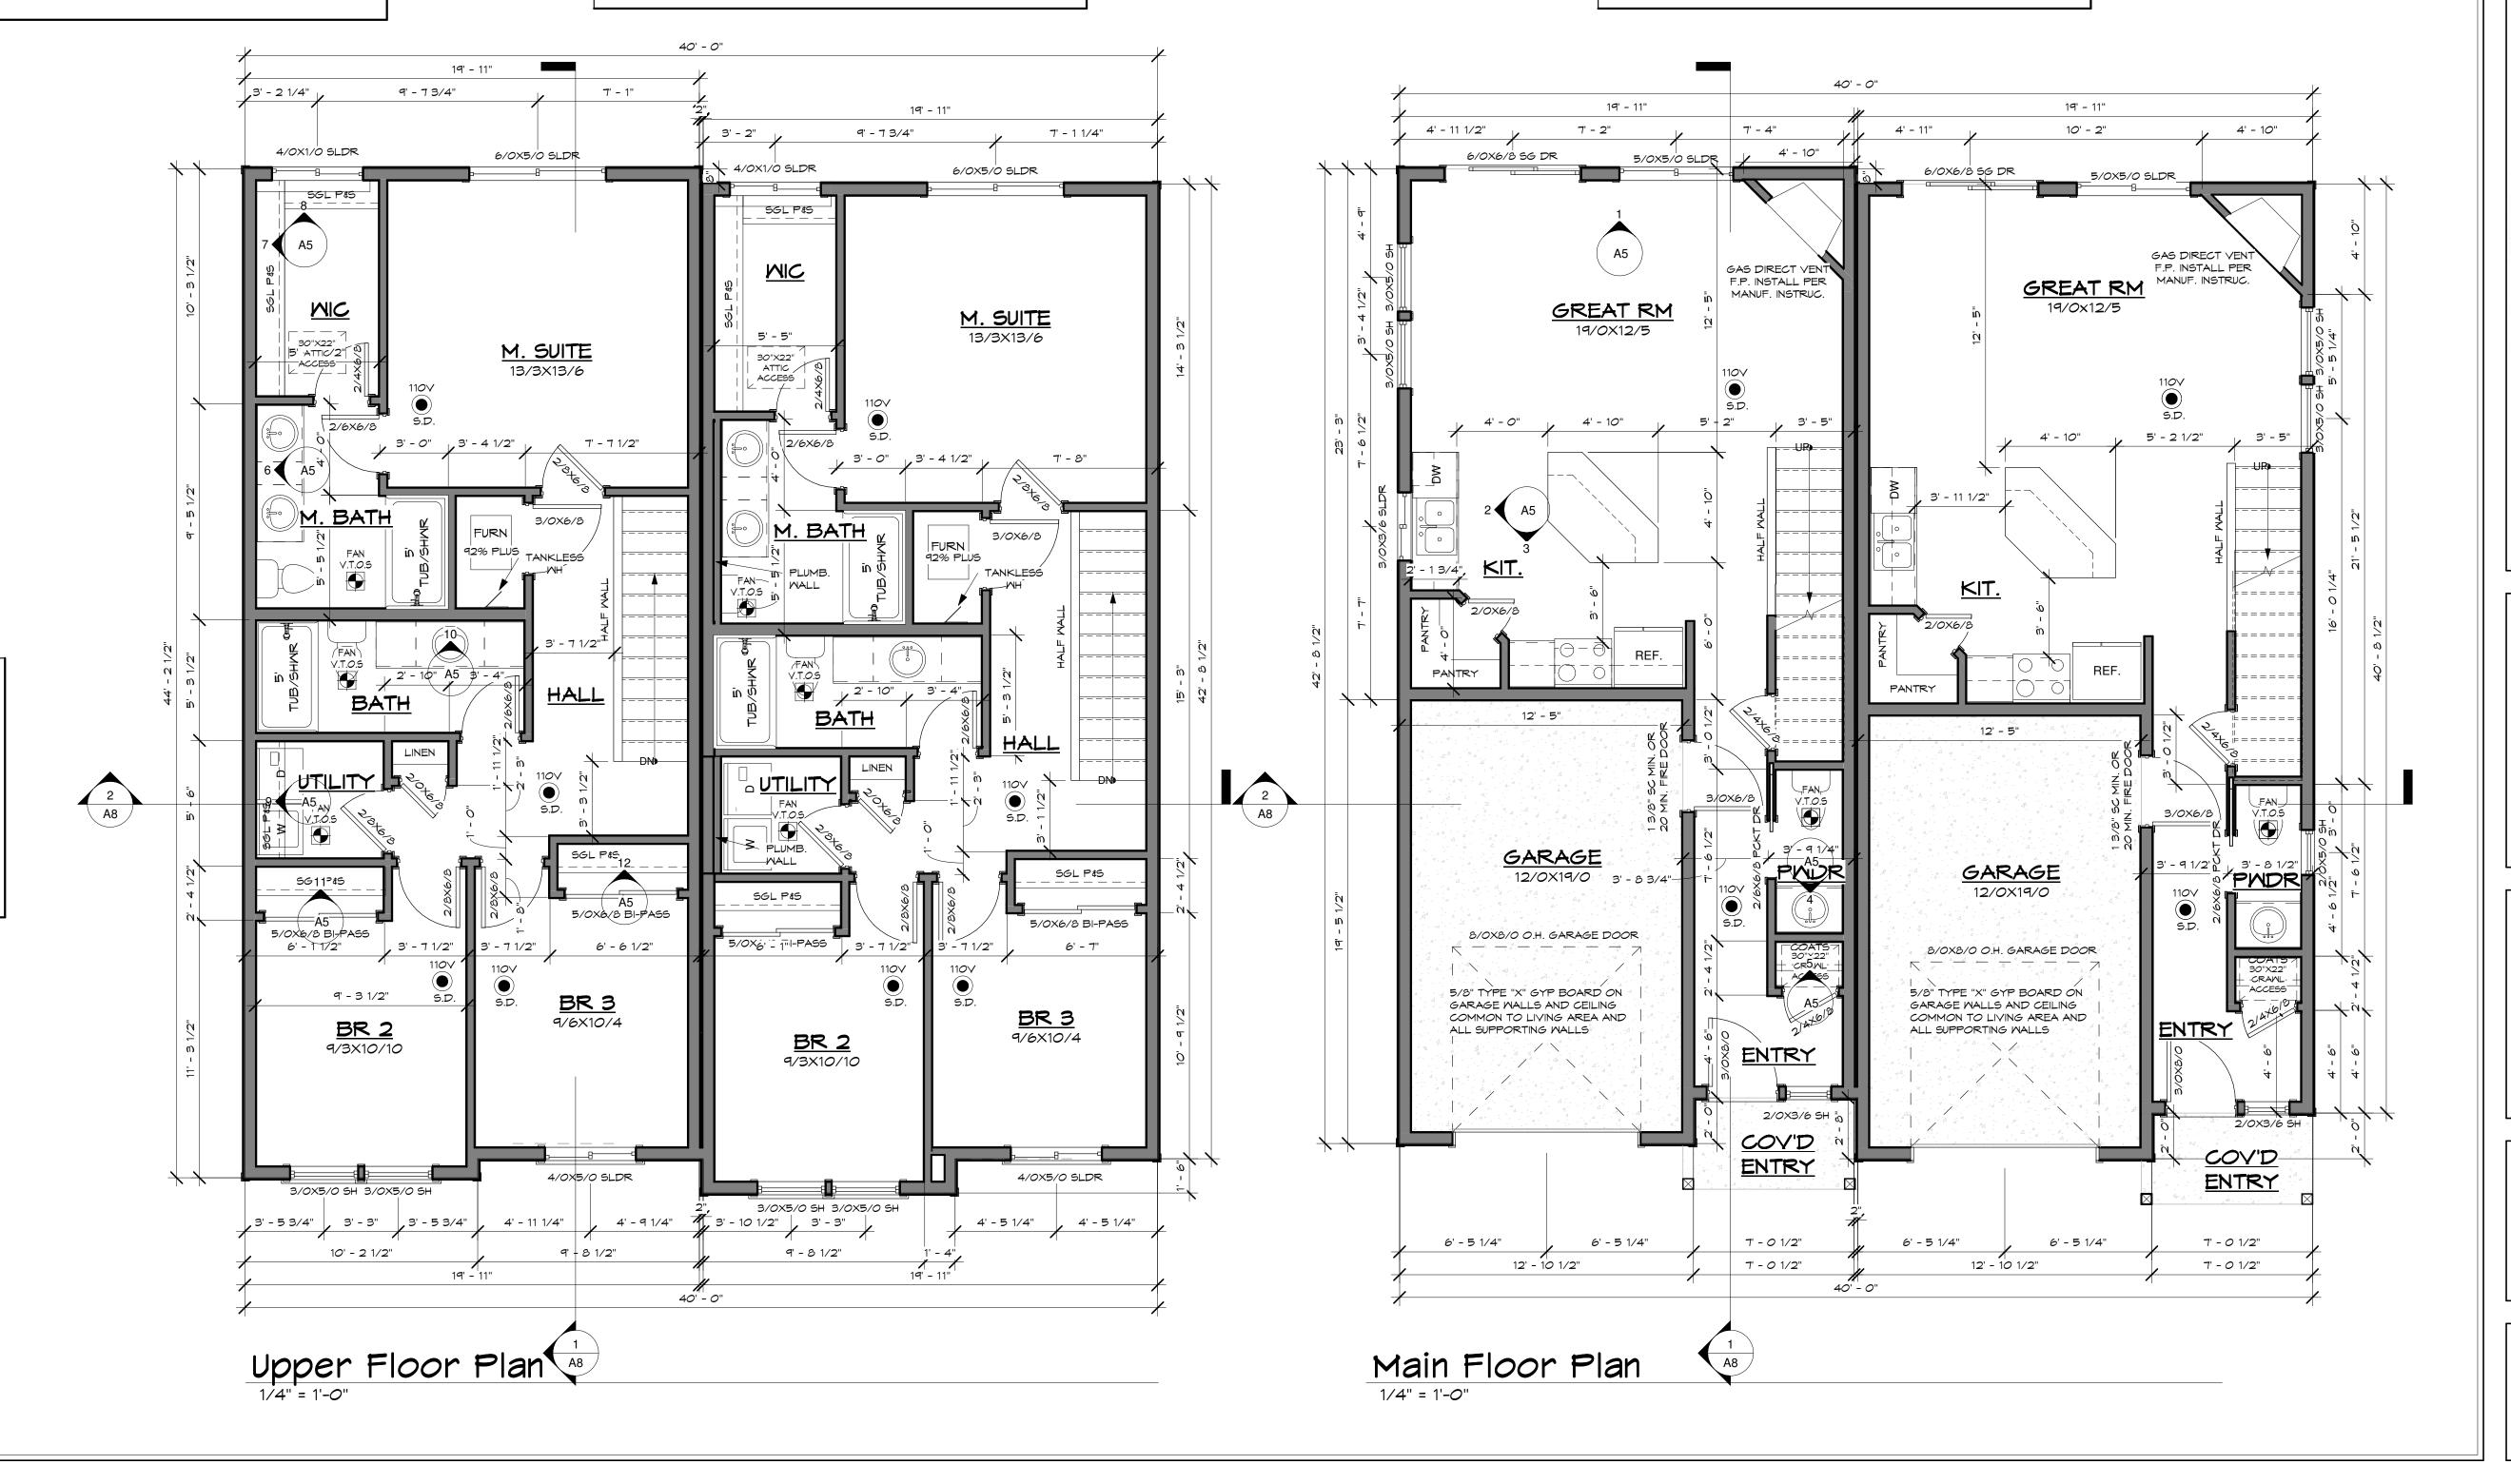



FILE NAME 1427-40-ST-L DRAWN BY: E DRAFTING SCALE: 1/4" = 1'-0" PLOT DATE :

Written dimensions on these drawings shall have precedence over scaled dimensions. Contractor shall assume responsibility for all dimensions and conditions on the job. The designer must be notified and consent to any variations from dimensions set forth herein. The type of exterior finish, the installation and waterproofing details are all to be the full responsibility of the owner/builder. This Designer assumes no responsibility for the integrity of the building envelope. Thi document is the property of E Drafting Corp. No reuse or reproduction is allowed without the written consent from E Drafting Corp.

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SHEET Floor Plans

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